#### DI LIMBING SYMBOL LIST

	VALVES	⊚ <sup>RD</sup>	ROOF DRAIN	GAL	GALLONS
	VALVES			GPH	GALLONS PER HOUR
<b></b>	VALVE, GENERAL	© <sup>V™</sup>	VENT THROUGH ROOF	GPM	GALLONS PER MINUTE
<b>\</b>	VALVE		PIPING SYSTEMS	НВ	HOSE BIBB
	OATE VALVE		COLD WATER PIPING	HD	HEAD
	GATE VALVE		COLD WATER PIPING	HUD	HUB DRAIN
<del> </del>	PRESSURE REDUCING VALVE		HOT WATER PIPING	HP	HORSE POWER
1	MOTORIZED, 2-WAY VALVE		HOT WATER RETURN PIPING	HTR	HEATER
	WO TOTALLO, Z WAT WALTE			HW	HOT WATER
	CHECK VALVE	——	GAS PIPING	HWR	HOT WATER RETURN
	QUARTER TURN VALVE	D	CONDENSATE PIPING	ID	INSIDE DIAMETER
			A OLD DEGLOTANT DIDING	IE	INVERT ELEVATION
	GLOBE VALVE	AR	ACID RESISTANT PIPING	. IN	INCHES
<u>BV</u>	BALANCING VALVE	——F——	FIRE PROTECTION PIPING	L LBS.	LAVATORY POUNDS
	MOTORIZED 7 WAY VALVE	: .	COMPRESSED AIR PIPING	MBH	THOUSAND BTU'S PER HOUR
	MOTORIZED, 3-WAY VALVE	———A——	COMPRESSED AIR PIPING	MIN	MINIMUM
	<u>FITTINGS</u>		WASTE PIPING BELOW GRADE OR FINISHED FLOOR	(N)	NEW
<u> </u>	PIPE RISE		THAISITED TEOOR	N/A	NOT APPLICABLE
	PIPE RISE		WASTE PIPING ABOVE GRADE OR FINISHED FLOOR	NIC	NOT IN CONTRACT
——∋	PIPE DROP		THAIRED TEOOR	NO.	NUMBER
	TEE UP ON PIPE		STORM DRAIN PIPING ABOVE GRADE OR FINISHED FLOOR	NOP	NORMALLY OPEN
	TEE OF ON THE			NTS	NOT TO SCALE
	TEE DOWN ON PIPE	- — SD — -	STORM DRAIN PIPING BELOW GRADE OR FINISHED FLOOR	OD	OUTSIDE DIAMETER
	CONTINUATION			Р	PUMP
•	SON THE PARTY OF T		WASTE VENT PIPING	PDI	PLUMBING & DRAINAGE INSTITUTE
3	CAP		ABBREVIATIONS	PRV	PRESSURE REDUCING VALVE
	UNION		• *	PSI	POUNDS PER SQUARE INCH
		AD	AREA DRAIN	RD	ROOF DRAIN
	PIPE BELOW GRADE	AFG	ABOVE FINISHED GRADE	REC	ROOF CEPTOR
	PIPE REMOVED IN DEMOLITION	AFF	ABOVE FINISHED FLOOR	RET	RETURN
	THE NEWOYLD IN BEMOUNDING	BFP	BACKFLOW PREVENTER	RL	RAIN WATER LEADER
	CONCENTRIC REDUCER	BFF	BELOW FINISHED FLOOR	SF	SQUARE FEET
	ECCENTRIC REDUCER	CD	CONDENSATE DRAIN	SOV	SHUT OFF VALVE
	LOOLIN INTO INLUGACIO	CF	CUBIC FOOT	TEMP	TEMPERATURE
	FLOW DIRECTION	CFH	CUBIC FEET PER HOUR	TP	TRAP PRIMER PIPING
#	HOSE BIBB	CL	CENTERLINE CEILING	TPV	TRAP PRIMER VALVE
1'		CLG CONT.	CONTINUATION	U	URINAL
	PUMP	CV	CHECK VALVE	UH	UNIT HEATER
<u>wco</u>	WALL CLEANOUT	CW	COLD WATER	<b>v</b>	VENT
		DIA	DIAMETER	VAC	VACUUM
CO	FLOOR CLEANOUT	DN	DOWN	VTR	VENT THRU ROOF
B	CATCH BASIN	(E)	EXISTING	W	WASTE
		EL	ELEVATION	w/	WITH
D	FLOOR DRAIN	ELECT	ELECTRICAL	WC	WATER CLOSET
<u>FS</u>	FLOOR SINK	FC	FLEXIBLE CONNECTOR	WHA	WATER HAMMER ARRESTOR
		FPS	FEET PER SECOND		
		FS	FLOW SWITCH		
		FT	FEET		
		GCO	GRADE CLEANOUT		

#### GENERAL PLUMBING NOTES

- A. REPORT TO ARCHITECT, IN WRITING, CONDITIONS WHICH WILL PREVENT PROPER PROVISION OF THIS WORK.
- B. THE SUBMISSION OF BID PROPOSAL SHALL BE CONSIDERED AS CONCLUSIVE EVIDENCE THAT THE CONTRACTOR IS THOROUGHLY FAMILIAR WITH THE INTENT OF THE CONTRACT DOCUMENTS AND SCOPE OF WORK. THE CONTRACTOR, PRIOR TO BIDDING, SHALL VISIT THE JOB SITE, CHECK EXISTING INSTALLATIONS AND SYSTEMS RELATED TO HIS WORK AND SHALL IN THE BID PROPOSAL INCLUDE ALL LABOR AND MATERIAL REQUIRED TO COMPLETE THE SYSTEM.
- C. CONTRACTOR SHALL COMPLETE THE WORK WITH MINIMUM INTERFERENCE WITH EXISTING SYSTEMS. ANY SHUTDOWN OF THE EXISTING SYSTEM SHALL BE COORDINATED WITH THE GENERAL CONTRACTOR AND THE OWNER'S REPRESENTATIVE TWO WEEKS IN ADVANCE.
- D. ALL WORK UNDER THIS DIVISION SHALL BE COORDINATED WITH OTHER TRADES.
- E. PROTECT EXISTING BUILDING STRUCTURES, AND ADJACENT FINISHED SURFACES DURING CONSTRUCTION. PATCH, REPAIR AND REFINISH EXISTING WORK DAMAGED BY WORK UNDER THIS DIVISION TO MATCH ADJACENT UNDISTURBED AREAS. PATCHING AND REFINISHING IS TO BE PERFORMED BY WORKMEN SKILLED IN THE TRADES INVOLVED. DO NOT CUT ANY STRUCTURAL MEMBERS WITHOUT THE REVIEW AND APPROVAL OF THE STRUCTURAL ENGINEER.
- F. ALL MATERIALS AND WORKMANSHIP ARE SUBJECT TO REVIEW AND APPROVAL BY THE ARCHITECT. ANY PORTION OF THE WORK FOUND TO BE DEFECTIVE SHALL BE REPLACED BY THE CONTRACTOR AS PART OF THIS CONTRACT AT NO ADDITIONAL COST TO THE OWNER.
- G. ANY PIPING OFFSETS REQUIRED AS RESULT OF EXISTING JOB CONDITIONS, OR LACK OF COORDINATION WITH OTHER TRADES SHALL BE PROVIDED BY THE CONTRACTOR AT NO ADDITIONAL COST TO OWNER AND IS SUBJECT TO REVIEW BY THE ARCHITECT.
- H. ALL FLOOR DRAIN TRAPS WILL BE PRIMED TO PROVIDE WATER SEAL FOR PREVENTION OF DRYING AND PREVENTION OF FUMES EXITING UP THROUGH DRAINS.
- INSULATE HOT WATER PIPING SUPPLY AND RETURN. INSULATE COLD WATER PIPING LOCATED EXPOSED IN TEMPERED ROOMS, IN CRAWL SPACE OR ATTIC AREA, AND EXPOSED OUTSIDE UNDER OVERHANGS. PIPING EXPOSED TO RAIN SHALL BE INSULATED WITH CLOSED CELL INSULATION, ALUMINUM JACKET INSULATION SHALL BE PAINTED TO MATCH THE SURROUNDING, AS APPROVED PER ARCHITECT IN SUBMITTAL.
- J. FOR PIPES PENETRATING WALL, PROVIDE ESCUTCHEON ALL EXPOSED LOCATIONS.
- K. COORDINATE WITH FLOOR, CEILING AND WALL CONSTRUCTION TRADE TO PROVIDE ACCESS PANEL FOR ALL VALVES AND OTHER EQUIPMENT REQUIRING ACCESS.

#### GENERAL DEMOLITION NOTES

- A. COORDINATE DEMOLITION, CUTTING PATCHING, ETC. WITH GENERAL CONTRACTOR AND EXISTING FIELD CONDITIONS PRIOR TO SUBMITTING CONSTRUCTION CONTRACT BIDS. SEE SPECIFICATIONS GENERAL PROVISIONS, NOT ALL PIPING IS ILLUSTRATED.
- B. REFER TO ARCHITECTURAL, STRUCTURAL, MECHANICAL AND ELECTRICAL DRAWINGS FOR SPACE ALLOTMENT, BEAM LOCATION AND COORDINATION PURPOSES. CONFLICTS REGARDING SPACE REQUIREMENTS, CLEARANCES, INTERFERENCE WITH STRUCTURE OR OTHER WORK, ETC., SHALL BE DIRECTED TO THE ARCHITECT FOR RESOLUTION PRIOR TO INSTALLATION OF
- C. CUTTING, PATCHING AND PAINTING OF EXISTING WALLS, CEILINGS AND FLOOR TO ACCOMODATE WORK AS SHOWN OR SPECIFIED HEREIN, SHALL BE INCLUDED IN THE WORK FOR EACH TRADE.
- D. VERIFY AND COORDINATE EXISTING WASTE, VENT AND WATER PIPING TO REMAIN IN SERVICE. EXISTING WASTE, VENT AND WATER PIPING SERVING EXISTING PLUMBING FIXTURES, FLOOR SINKS AND FLOOR DRAINS TO BE REMOVED ARE TO BE CAPPED BELOW FLOOR OR REMOVED BACK TO PLUMBING PIPING REMAINING IN SERVICE THEN CAPPED, EXCEPT AS NOTED.

#### GENERAL SEISMIC NOTES

A. PIPING AND DUCTWORK DISTRIBUTION SYSTEMS SHALL BE BRACED TO SYSTEM THE FORCES PRESCRIBED IN ASCE 7-05 SECTION 13.3 AS DEFINED IN ASCE 7-05 SECTION 13.6.8, 13.6.7, AND 13.6.5.5, ITEM 6, RESPECTIVELY.

THE BRACING AND ATTACHMENTS TO THE STRUCTURE SHALL COMPLY WITH ONE OF THE OSHPD PRE-APPROVALS WITH AN OPA #, SUCH AS MASON INDUSTRIES (OPA 349), OR ISAT (OPA 485) AS MODIFIED TO SATISFY ANCHORAGE REQUIREMENTS OF ACI 318, APPENDIX D.

THE STRUCTURAL ENGINEER OF RECORD SHALL VERIFY THE ADEQUACY OF THE STRUCTURE TO SUPPORT THE HANGER AND BRACE LOADS. WHERE THEY DO NOT COMPLY WITH THE REQUIREMENT ON DETAIL T/S5.2.

- B. ALL MECHANICAL EQUIPMENT SHALL BE ANCHORED OR BRACED TO MEET THE HORIZONTAL AND VERTICAL FORCES PRESCRIBED IN THE 2007 CBC, SECTION 1614A.1.13 AND ASCE 7-05 SECTIONS 13.3, 13.4 & 13.6. THE ATTACHMENT OF THE FOLLOWING ITEMS SHALL BE DESIGNED TO RESIST THE FORCES PRESCRIBED ABOVE, BUT NEED NOT BE DETAILED ON THE PLANS:
  - 1. EQUIPMENT WEIGHTING LESS THAN 400 POUNDS SUPPORT DIRECTLY ON THE FLOOR OR ROOF.
  - 2. FURNITURE REQUIRED TO BE ATTACH IN ACCORDANCE WITH PART 2, TITLE 24, C.C.R.
- 3. TEMPORARY OR REMOVABLE EQUIPMENT.
- 4. EQUIPMENT WEIGHTING LESS THAN 20 POUNDS SUPPORT BY VIBRATION ISOLATORS. 5. EQUIPMENT WEIGHTING LESS THAN 20 POUNDS SUSPENDED FROM A ROOF OR FLOOR OR HUNG FROM WALL.

FOR THOSE ELEMENTS THAT DO NOT REQUIRE DETAILS ON THE APPROVED DRAWINGS, THE INSTALLATION SHALL BE SUBJECT TO THE APPROVAL OF THE MECHANICAL/ELECTRICAL ENGINEER AND THE FIELD REPRESENTATIVE OF THE DIVISION OF THE STATE ARCHITECT.

THE STRUCTURAL ENGINEER OF RECORD SHALL VERIFY THE ADEQUACY OF THE STRUCTURE TO SUPPORT THE HANGER AND BRACE LOADS. WHERE THEY DO NOT COMPLY WITH THE REQUIREMENT ON DETAIL T/S5.2.

- C. FIRE PROTECTION PIPING
- 1. THE SPACING AND DETAILS OF THE SUPPORT AND BRACING OF FIRE SPRINKLER PIPING SHALL COMPLY WITH
- THE LATEST EDITION OF NFPA 13.
- 2. PROVIDE ANCHORAGE DETAILS AND CALCULATIONS OF THE CONNECTION OF SWAY BRACING TO THE STRUCTURE. 3. DESIGN LOADS FOR THE ANCHORAGE MAY BE COMPUTED PER TABLE 4-6.4.3.5.2 OF NFPA 13, 1994 EDITION.
- 4. WHERE APPLICABLE DETAILS FOR THE SUPPORT AND BRACING MAY BE PER ITEM B ABOVE. 5. ALL SHOP DRAWINGS OF THE SPRINKLER SYSTEM SHALL BE SUBMITTED TO THE LOCAL FIRE MARSHAL AND MECHANICAL ENGINEER OF RECORD FOR REVIEW AND APPROVAL PRIOR TO INSTALLATION.
- D. CALCULATIONS AND DRAWINGS SHALL BE SUBMITTED FOR PIPING SUPPORTS AND BRACING SHOWING:
- 1. LOCATION OF SEISMIC BRACING. 2. REACTION FORCES TO THE SUPPORTING STRUCTURE.
- 3. MANUFACTURER'S DESIGNATION OF SUPPORT DEVICES.
- SEISMIC BRACING POINTS SHALL BE SUBMITTED ON CONTRACTOR'S COORDINATED SHOP DRAWINGS.
- F. A COPY OF THE BRACING SYSTEMS INSTALLATION MANUAL SHALL BE ON THE JOB SITE PRIOR TO STARTING THE INSTALLATION OF THE HANGERS AND/OR BRACES. SUBMIT APPLICABLE DETAILS FOR REVIEW AND

#### SHEET INDEX


- PO.1 PLUMBING LEGENDS, NOTES, ABBREVIATIONS & DRAWING INDEX
- PD1.1 FIRST FLOOR DEMOLITION PLAN PLUMBING
- PD1.2 SECOND FLOOR DEMOLITION PLAN PLUMBING
- THIRD FLOOR DEMOLITION PLAN PLUMBING
- ENLARGED DEMOLITION PLAN PLUMBING FIRST FLOOR PLAN - PLUMBING
- SECOND FLOOR PLAN PLUMBING
- P2.3 THIRD FLOOR PLAN PLUMBING
- P3.2 ENLARGED PLAN PLUMBING
- P3.3 ENLARGED PLANS PLUMBING
- P4.1 PLUMBING EQUIPMENT SCHEDULES PLUMBING DETAILS
- P6.2 PLUMBING DETAILS



architecture planning interiors

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CONTACT	<b>Omar Hawit</b>							
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#### BUILDINGS 5 & 6 RENOVATIONS

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San Mateo County Community
College District

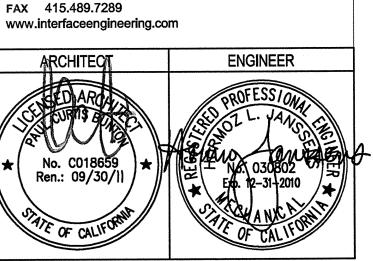
BID ADDENDA

CAÑADA COLLEGE 4200 Farm Hill Boulevard Redwood City, CA 94061

PLUMBING LEGENDS, NOTES, ABBREVIATIONS AND DRAWING INDEX

Date	Drawing Number
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AS NOTED Project Number



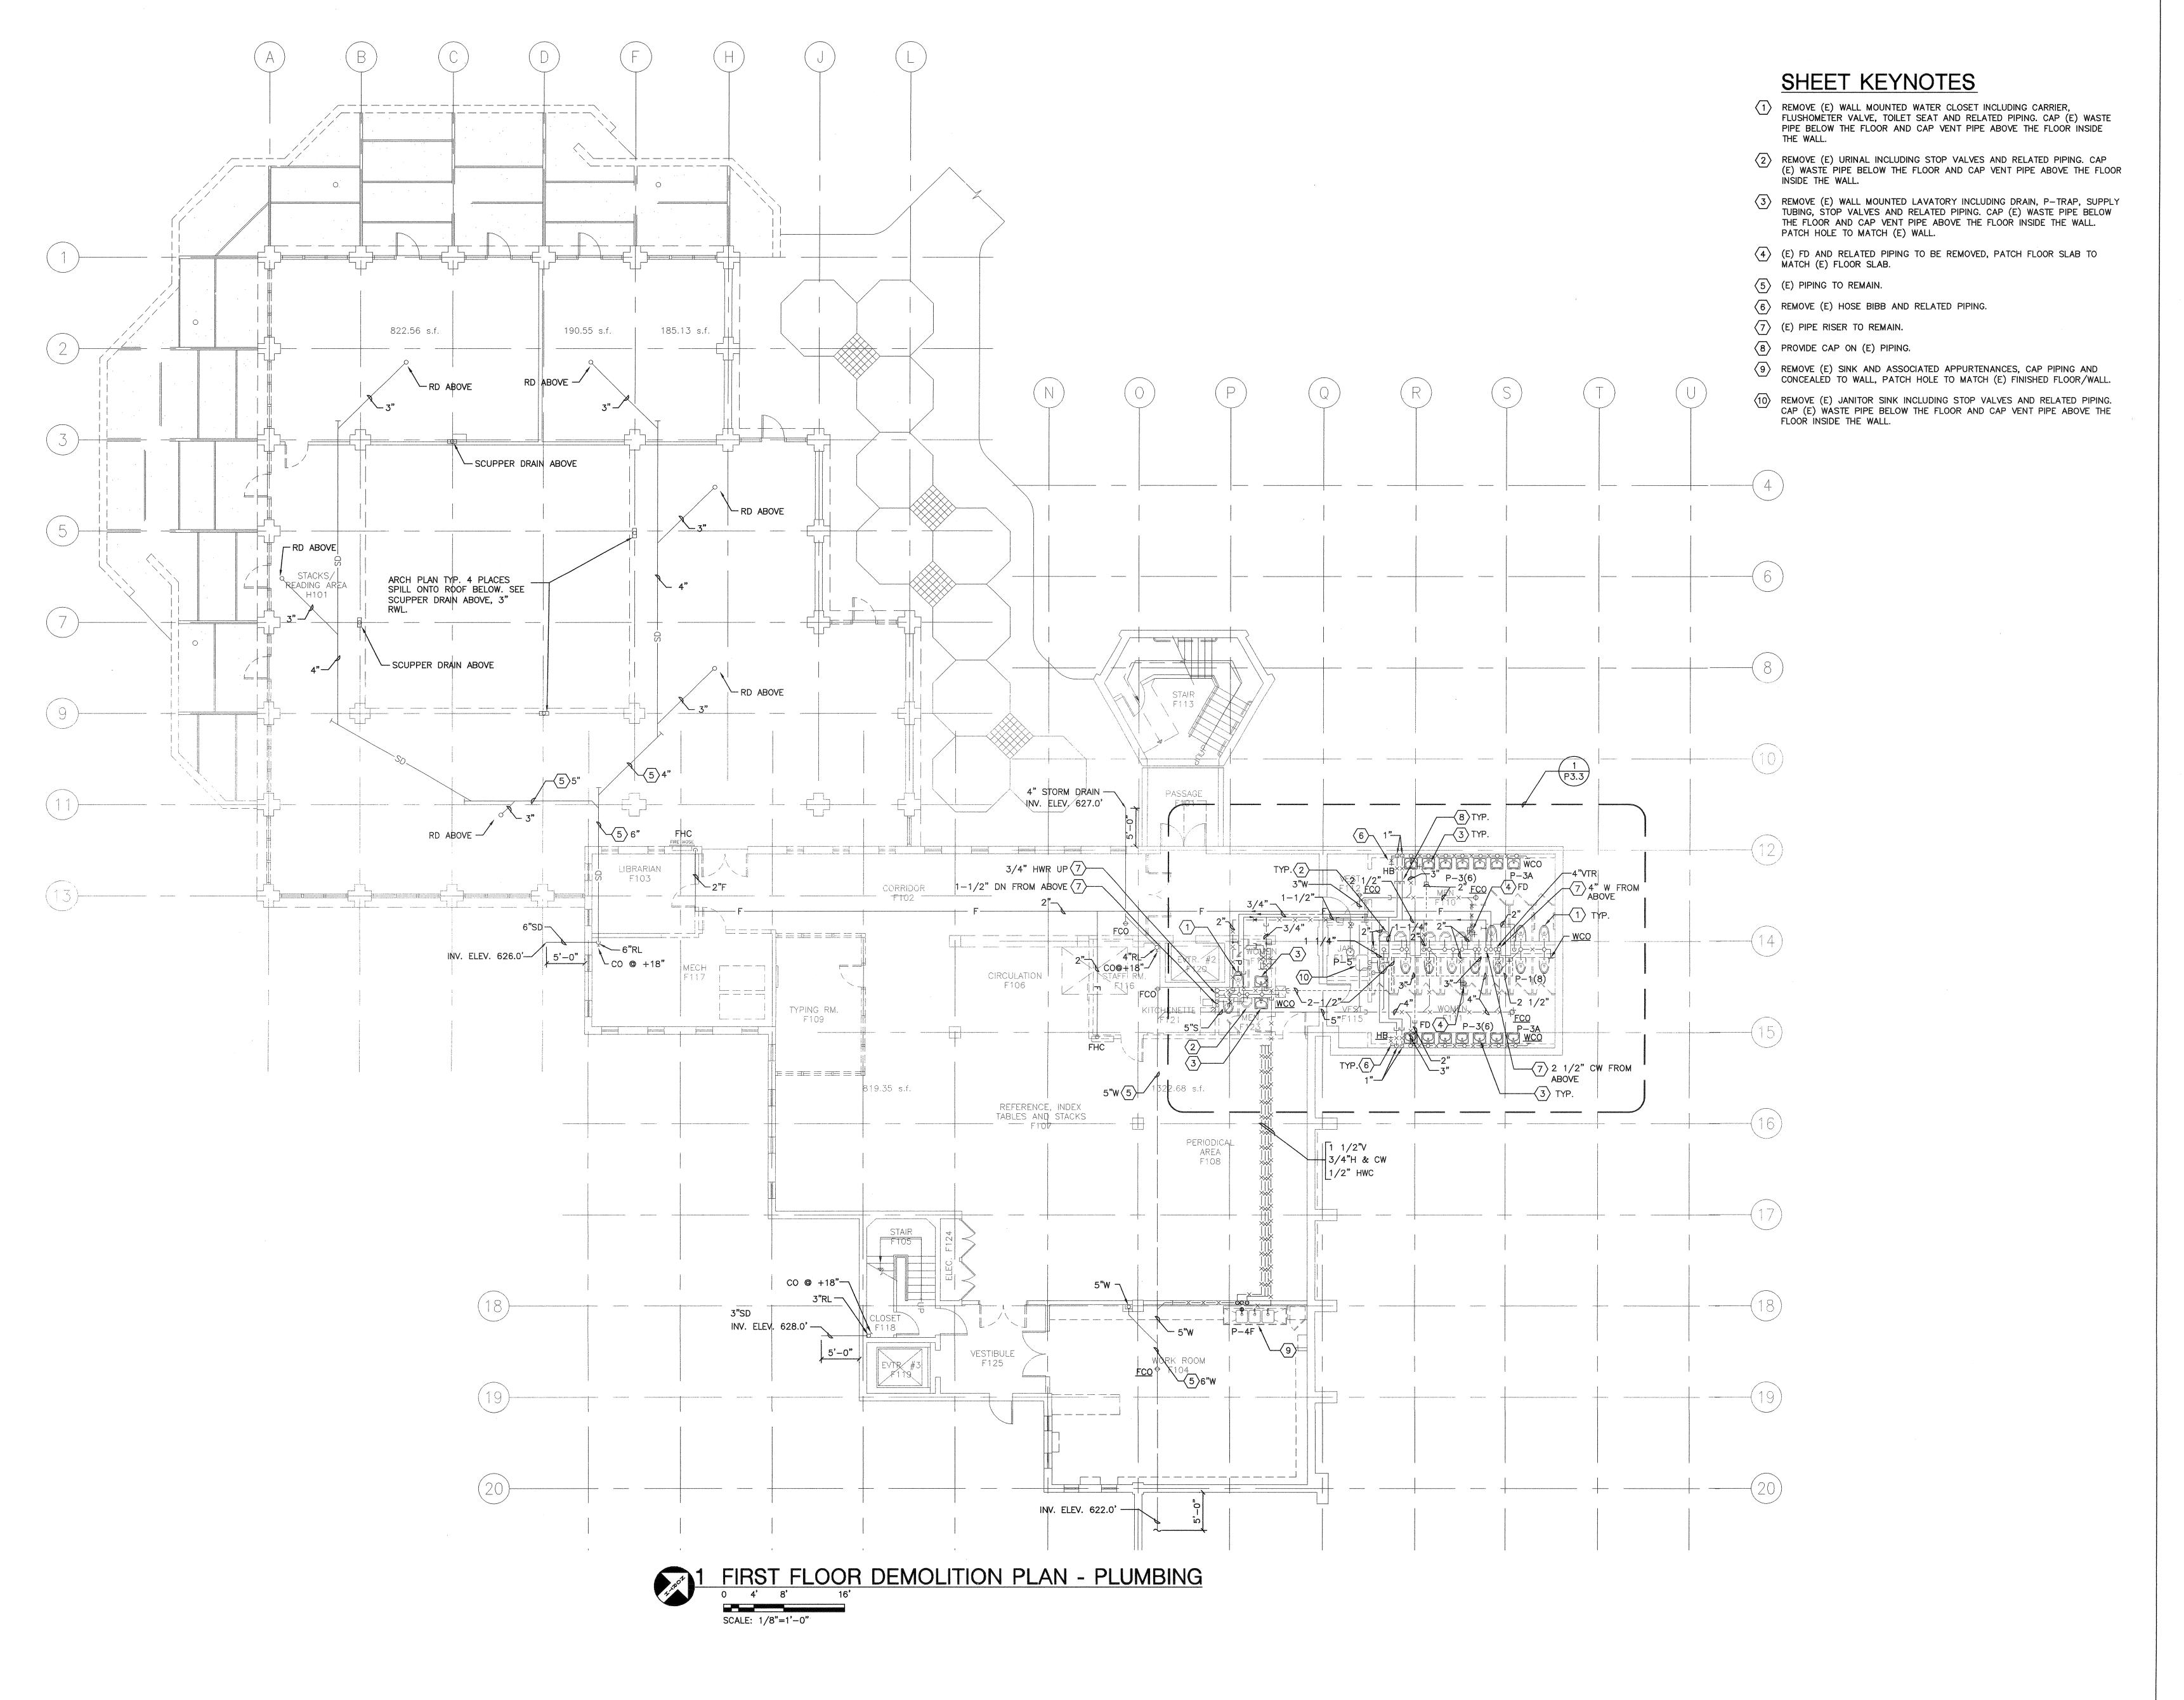

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PROJECT **2007-0731** 

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#### BUILDINGS 5 & 6 RENOVATIONS

San Mateo County Community College District


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## CAÑADA COLLEGE

4200 Farm Hill Boulevard Redwood City, CA 94061

FIRST FLOOR
DEMOLITION PLAN
PLUMBING

Date 01/22/09	Drawing Number
Scale AS NOTED	PD1
Project Number	

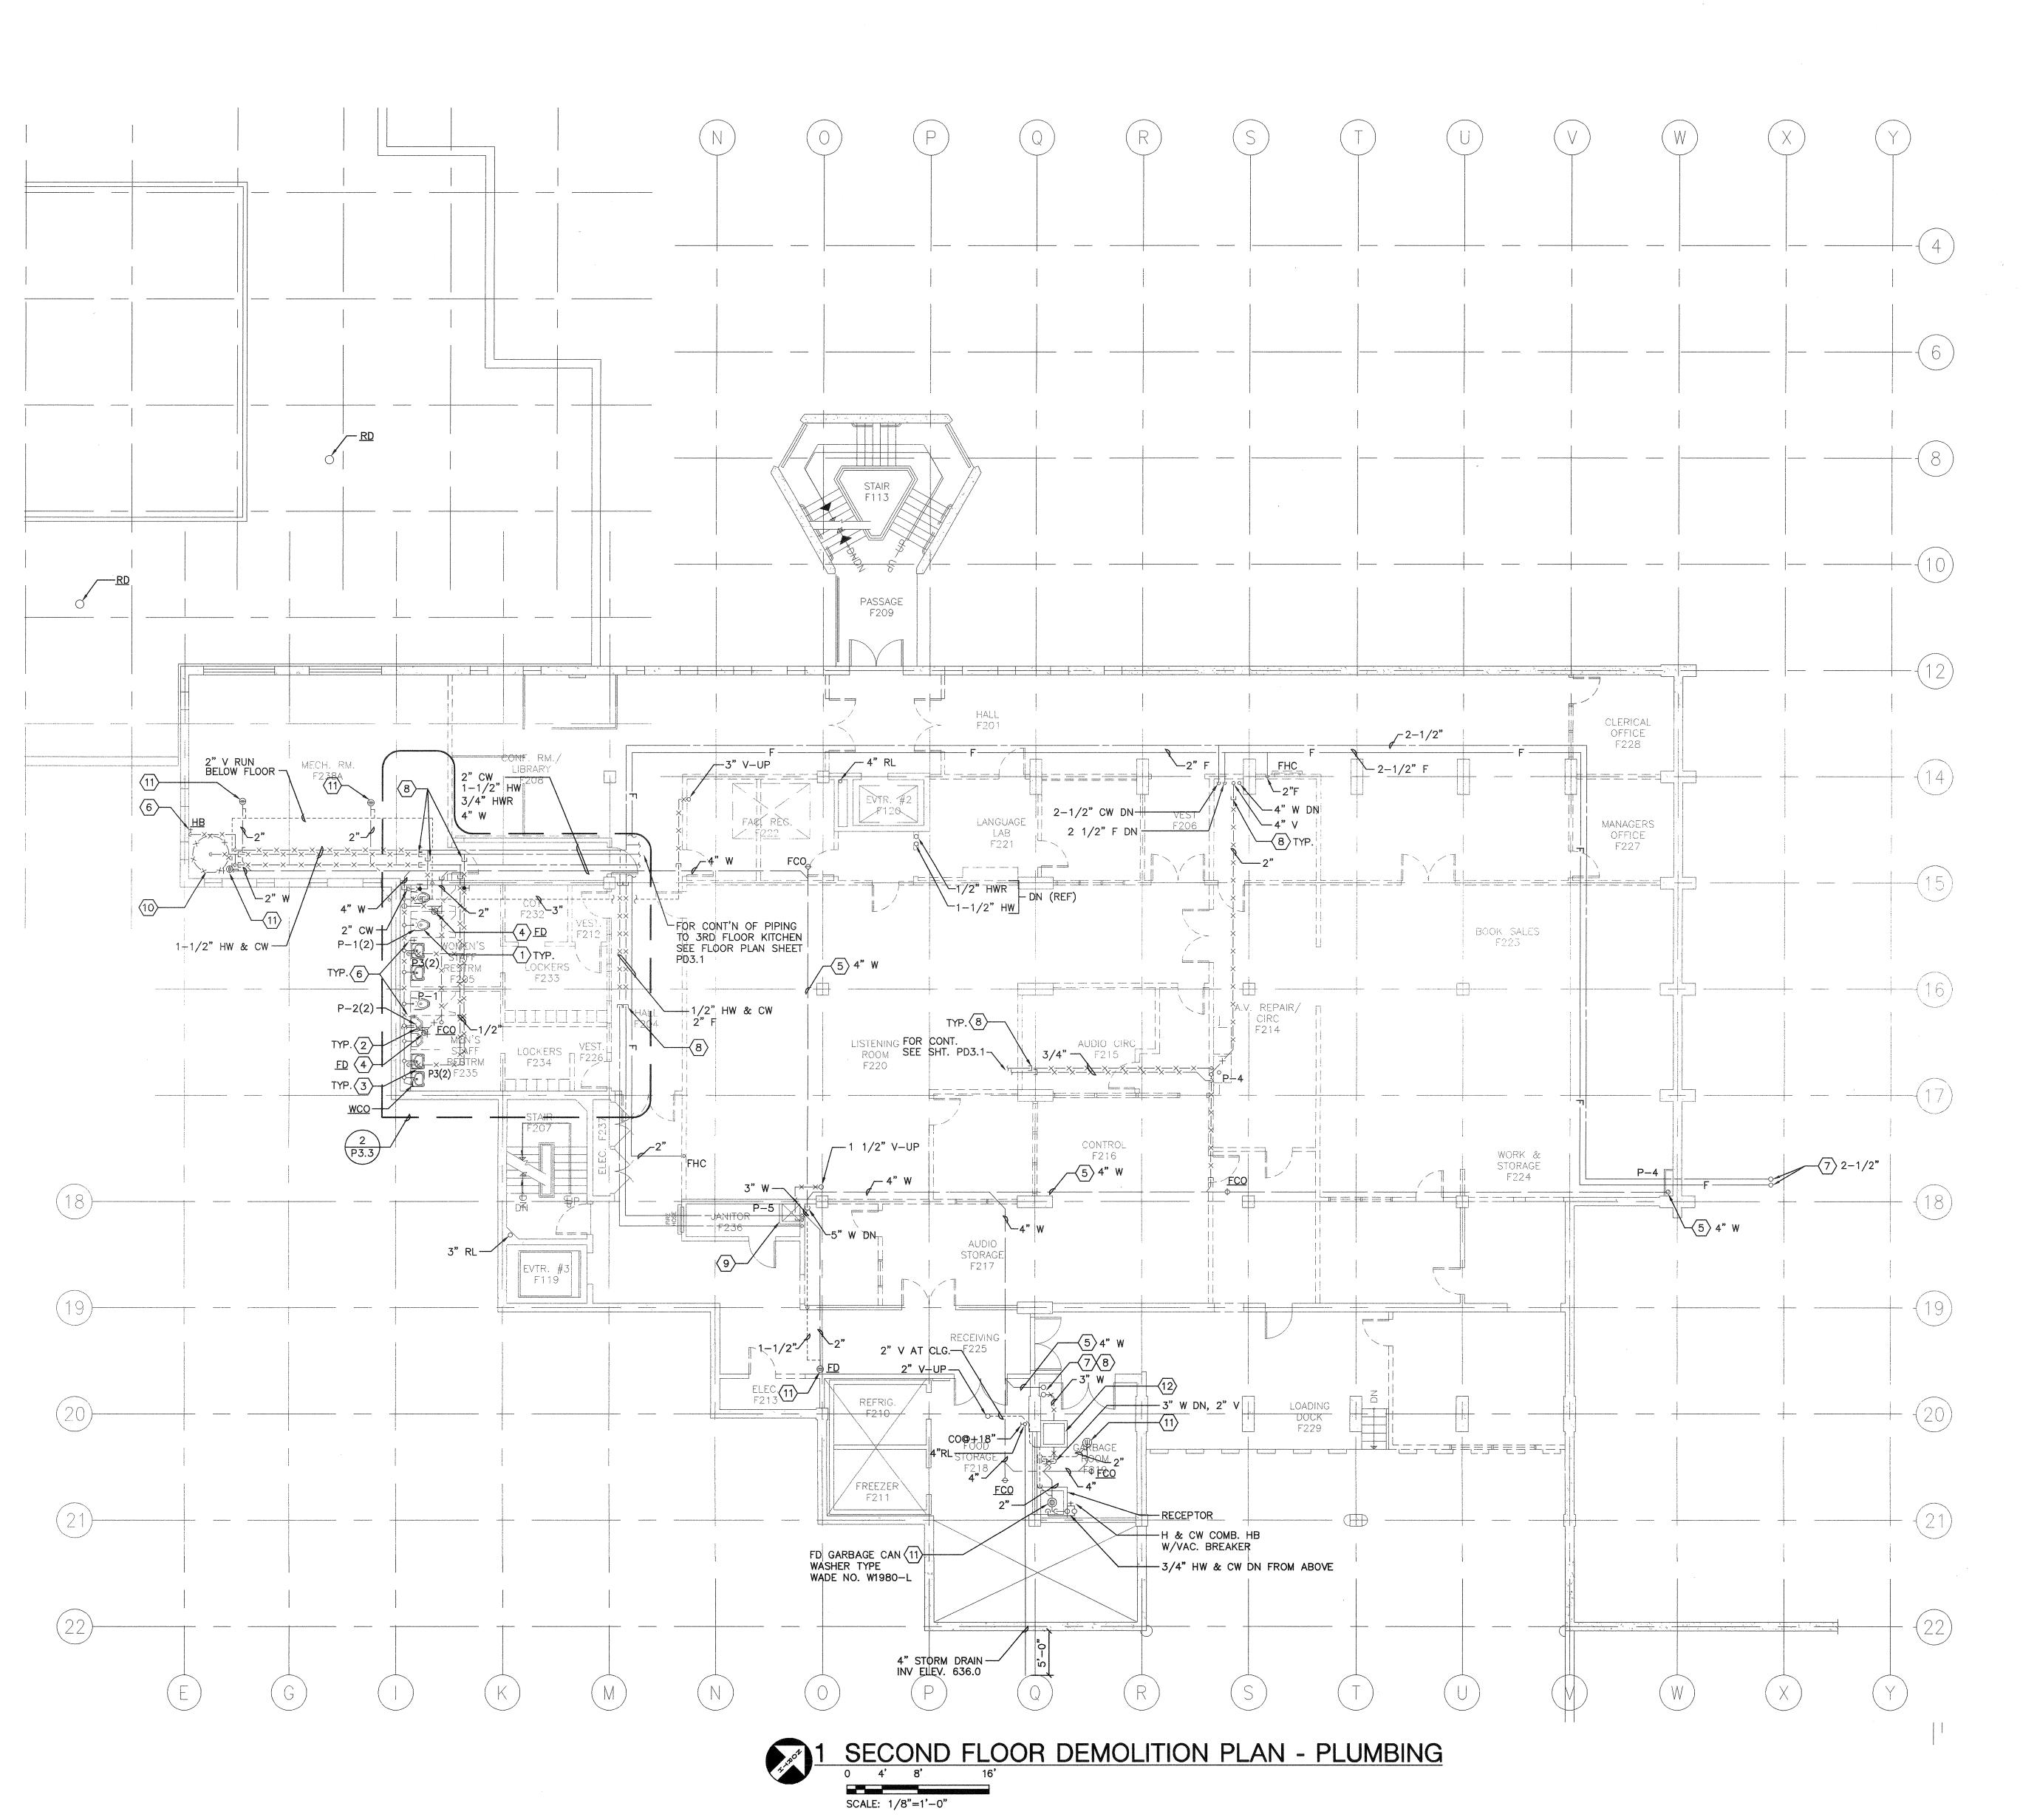

FILE: 0731P12D.DWG - PD12 | EDIT: 1/14/2009 2:23 PM BY ALLENL | PLOT: 1/21/2009 3:14 PM BY OMAR HAWIT

#### SHEET KEYNOTES

- REMOVE (E) WALL MOUNTED WATER CLOSET INCLUDING CARRIER, FLUSHOMETER VALVE, TOILET SEAT AND RELATED PIPING. CAP (E) WASTE PIPE BELOW THE FLOOR AND CAP VENT PIPE ABOVE THE FLOOR INSIDE THE WALL.
- (2) REMOVE (E) URINAL INCLUDING STOP VALVES AND RELATED PIPING. CAP (E) WASTE PIPE BELOW THE FLOOR AND CAP VENT PIPE ABOVE THE FLOOR INSIDE THE WALL.
- REMOVE (E) WALL MOUNTED LAVATORY INCLUDING DRAIN, P-TRAP, SUPPLY TUBING, STOP VALVES AND RELATED PIPING. CAP (E) WASTE PIPE BELOW THE FLOOR AND CAP VENT PIPE ABOVE THE FLOOR INSIDE THE WALL. PATCH HOLE TO MATCH (E) WALL.
- (E) FD AND RELATED PIPING TO BE REMOVED, PATCH FLOOR SLAB TO MATCH (E) FLOOR SLAB.
- $\langle 5 \rangle$  (E) PIPING TO REMAIN.
- $\overline{6}$  REMOVE (E) HOSE BIBB AND RELATED PIPING.
- $\langle 7 \rangle$  (E) PIPE RISER TO REMAIN.
- (8) PROVIDE CAP ON (E) PIPING.
- (E) JANITOR SINK TO REMAIN.
- REMOVE (E) HOT WATER GENERATOR, HOT WATER CIRCULATING PUMP AND ASSOCIATED APPURTENANCES.
- (11) (E) FD TO REMAIN.
- REMOVE & DISPOSE (E) GREASE INTERCEPTOR AND RELATED MATERIALS. PATCH FLOOR SLAB TO MATCH (E) FLOOR SLAB.



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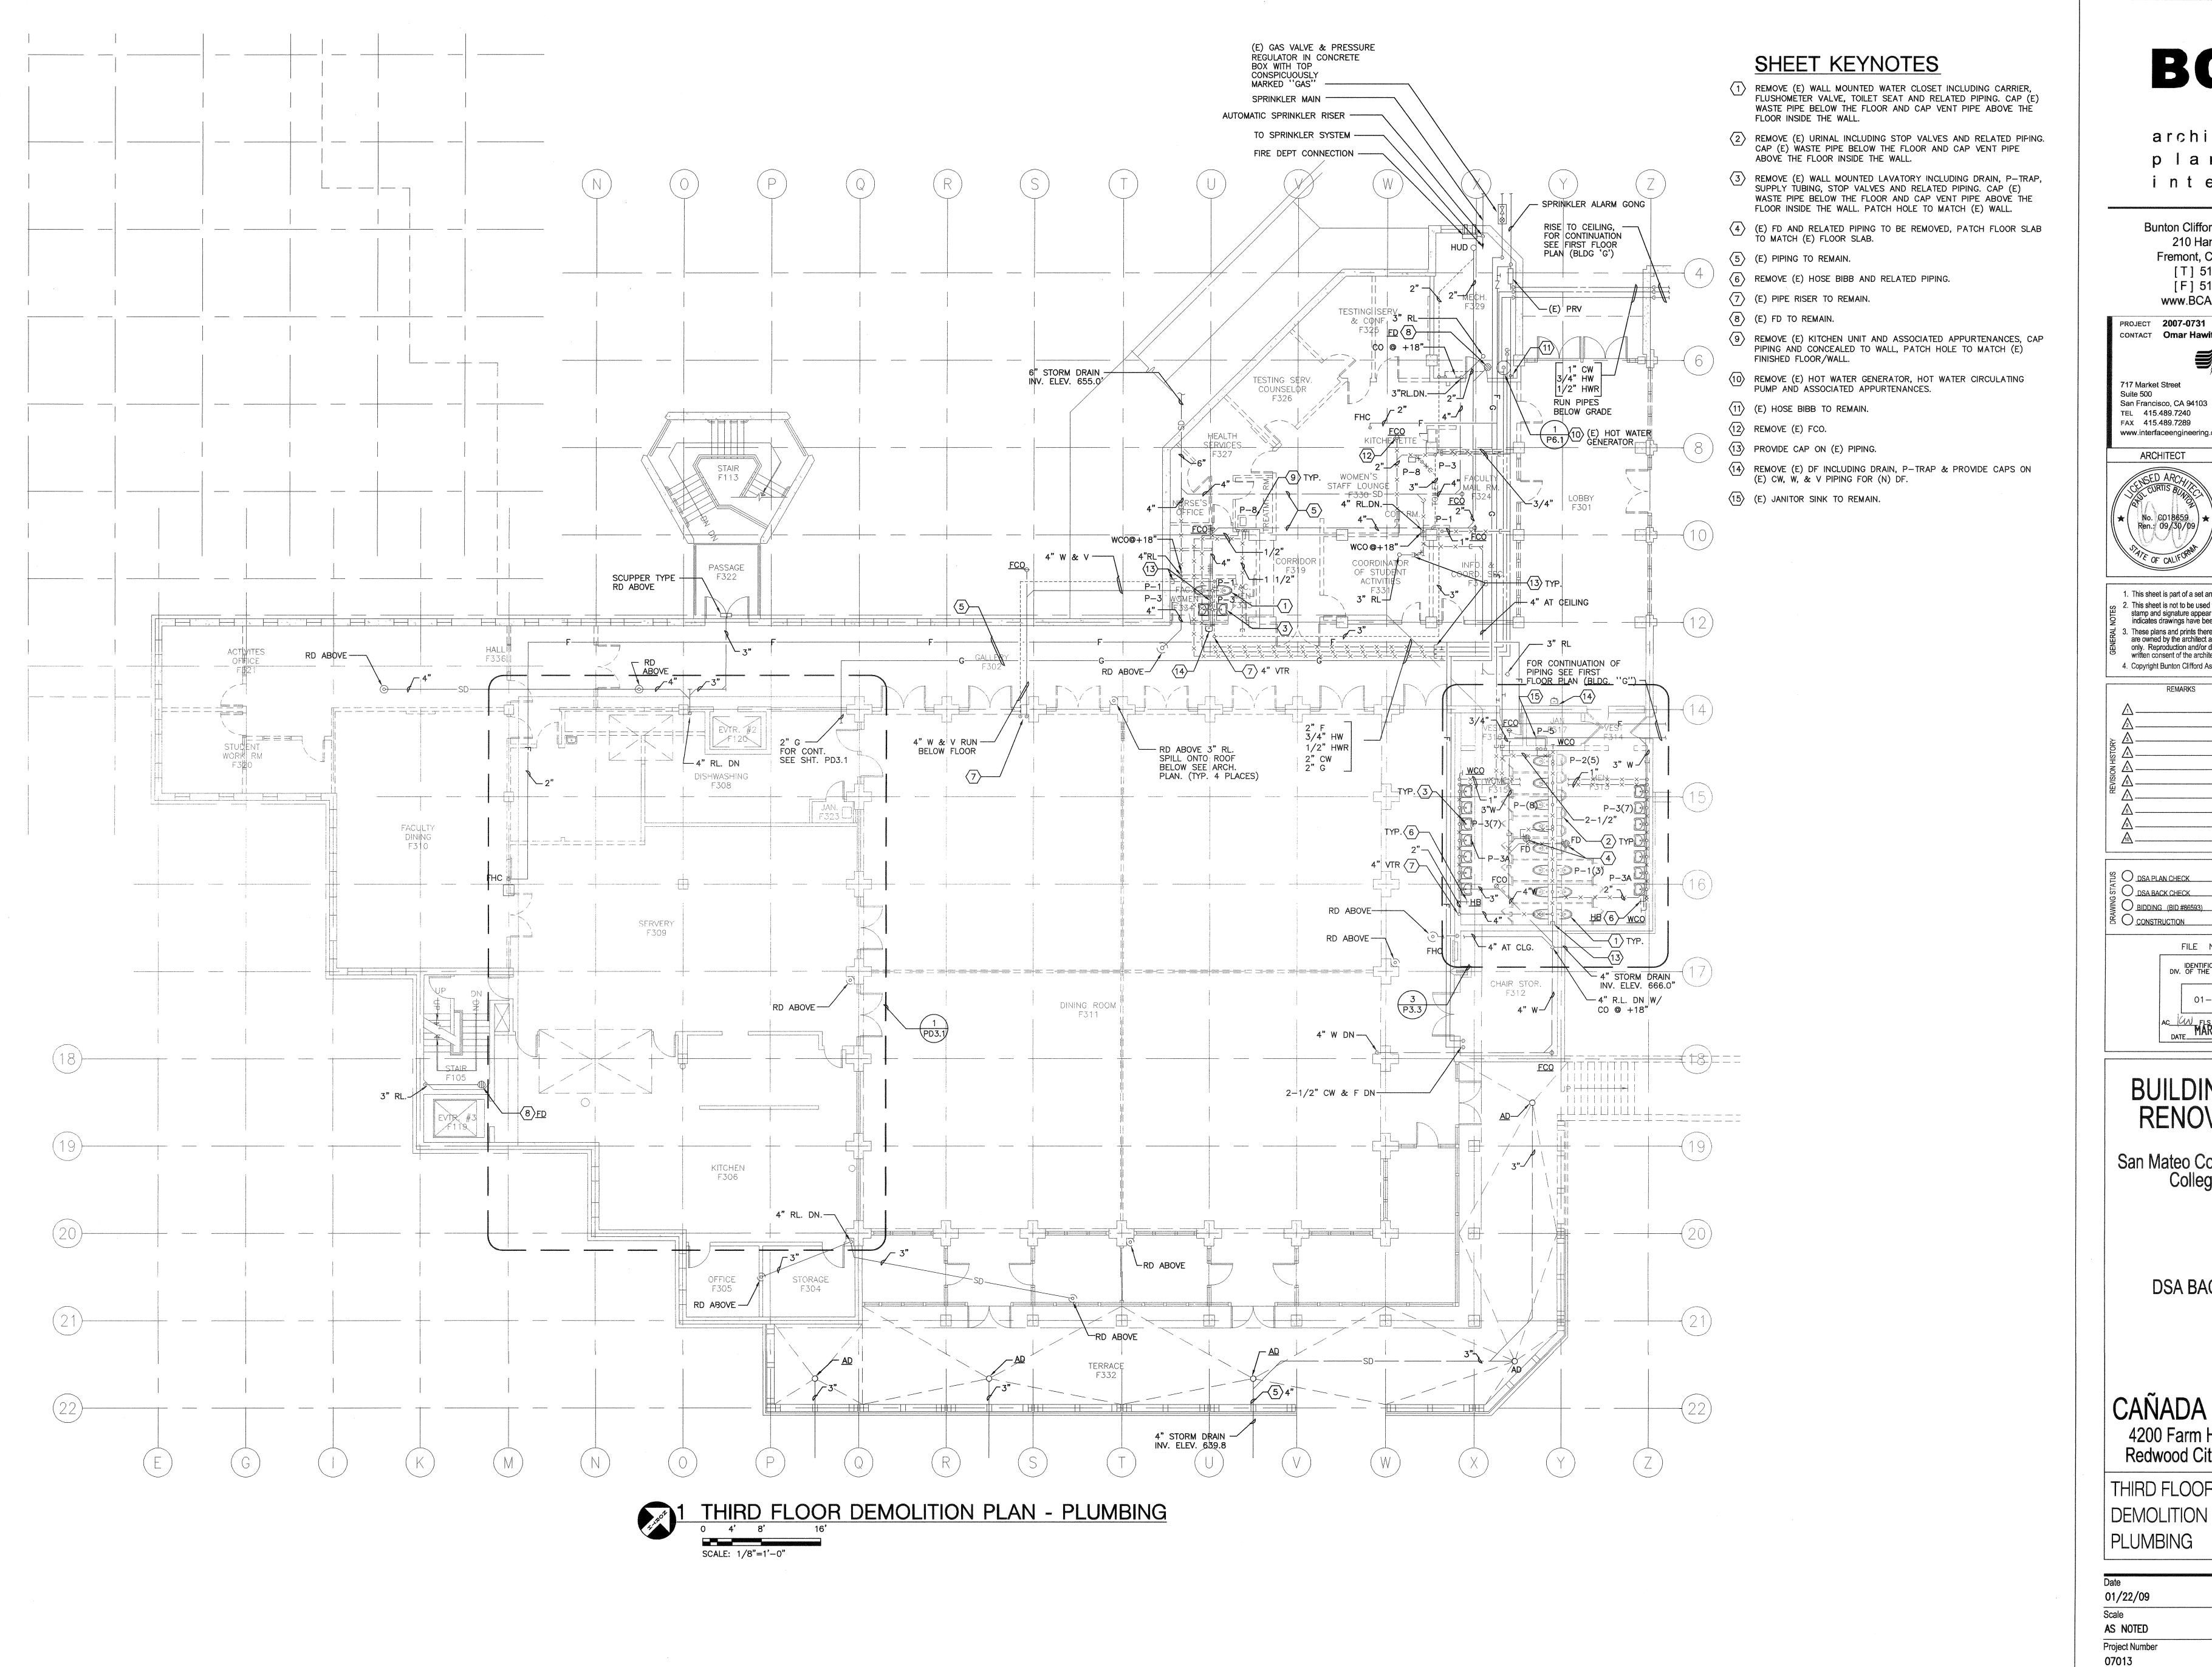
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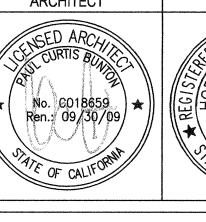
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#### BUILDINGS 5 & 6 RENOVATIONS

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San Mateo County Community
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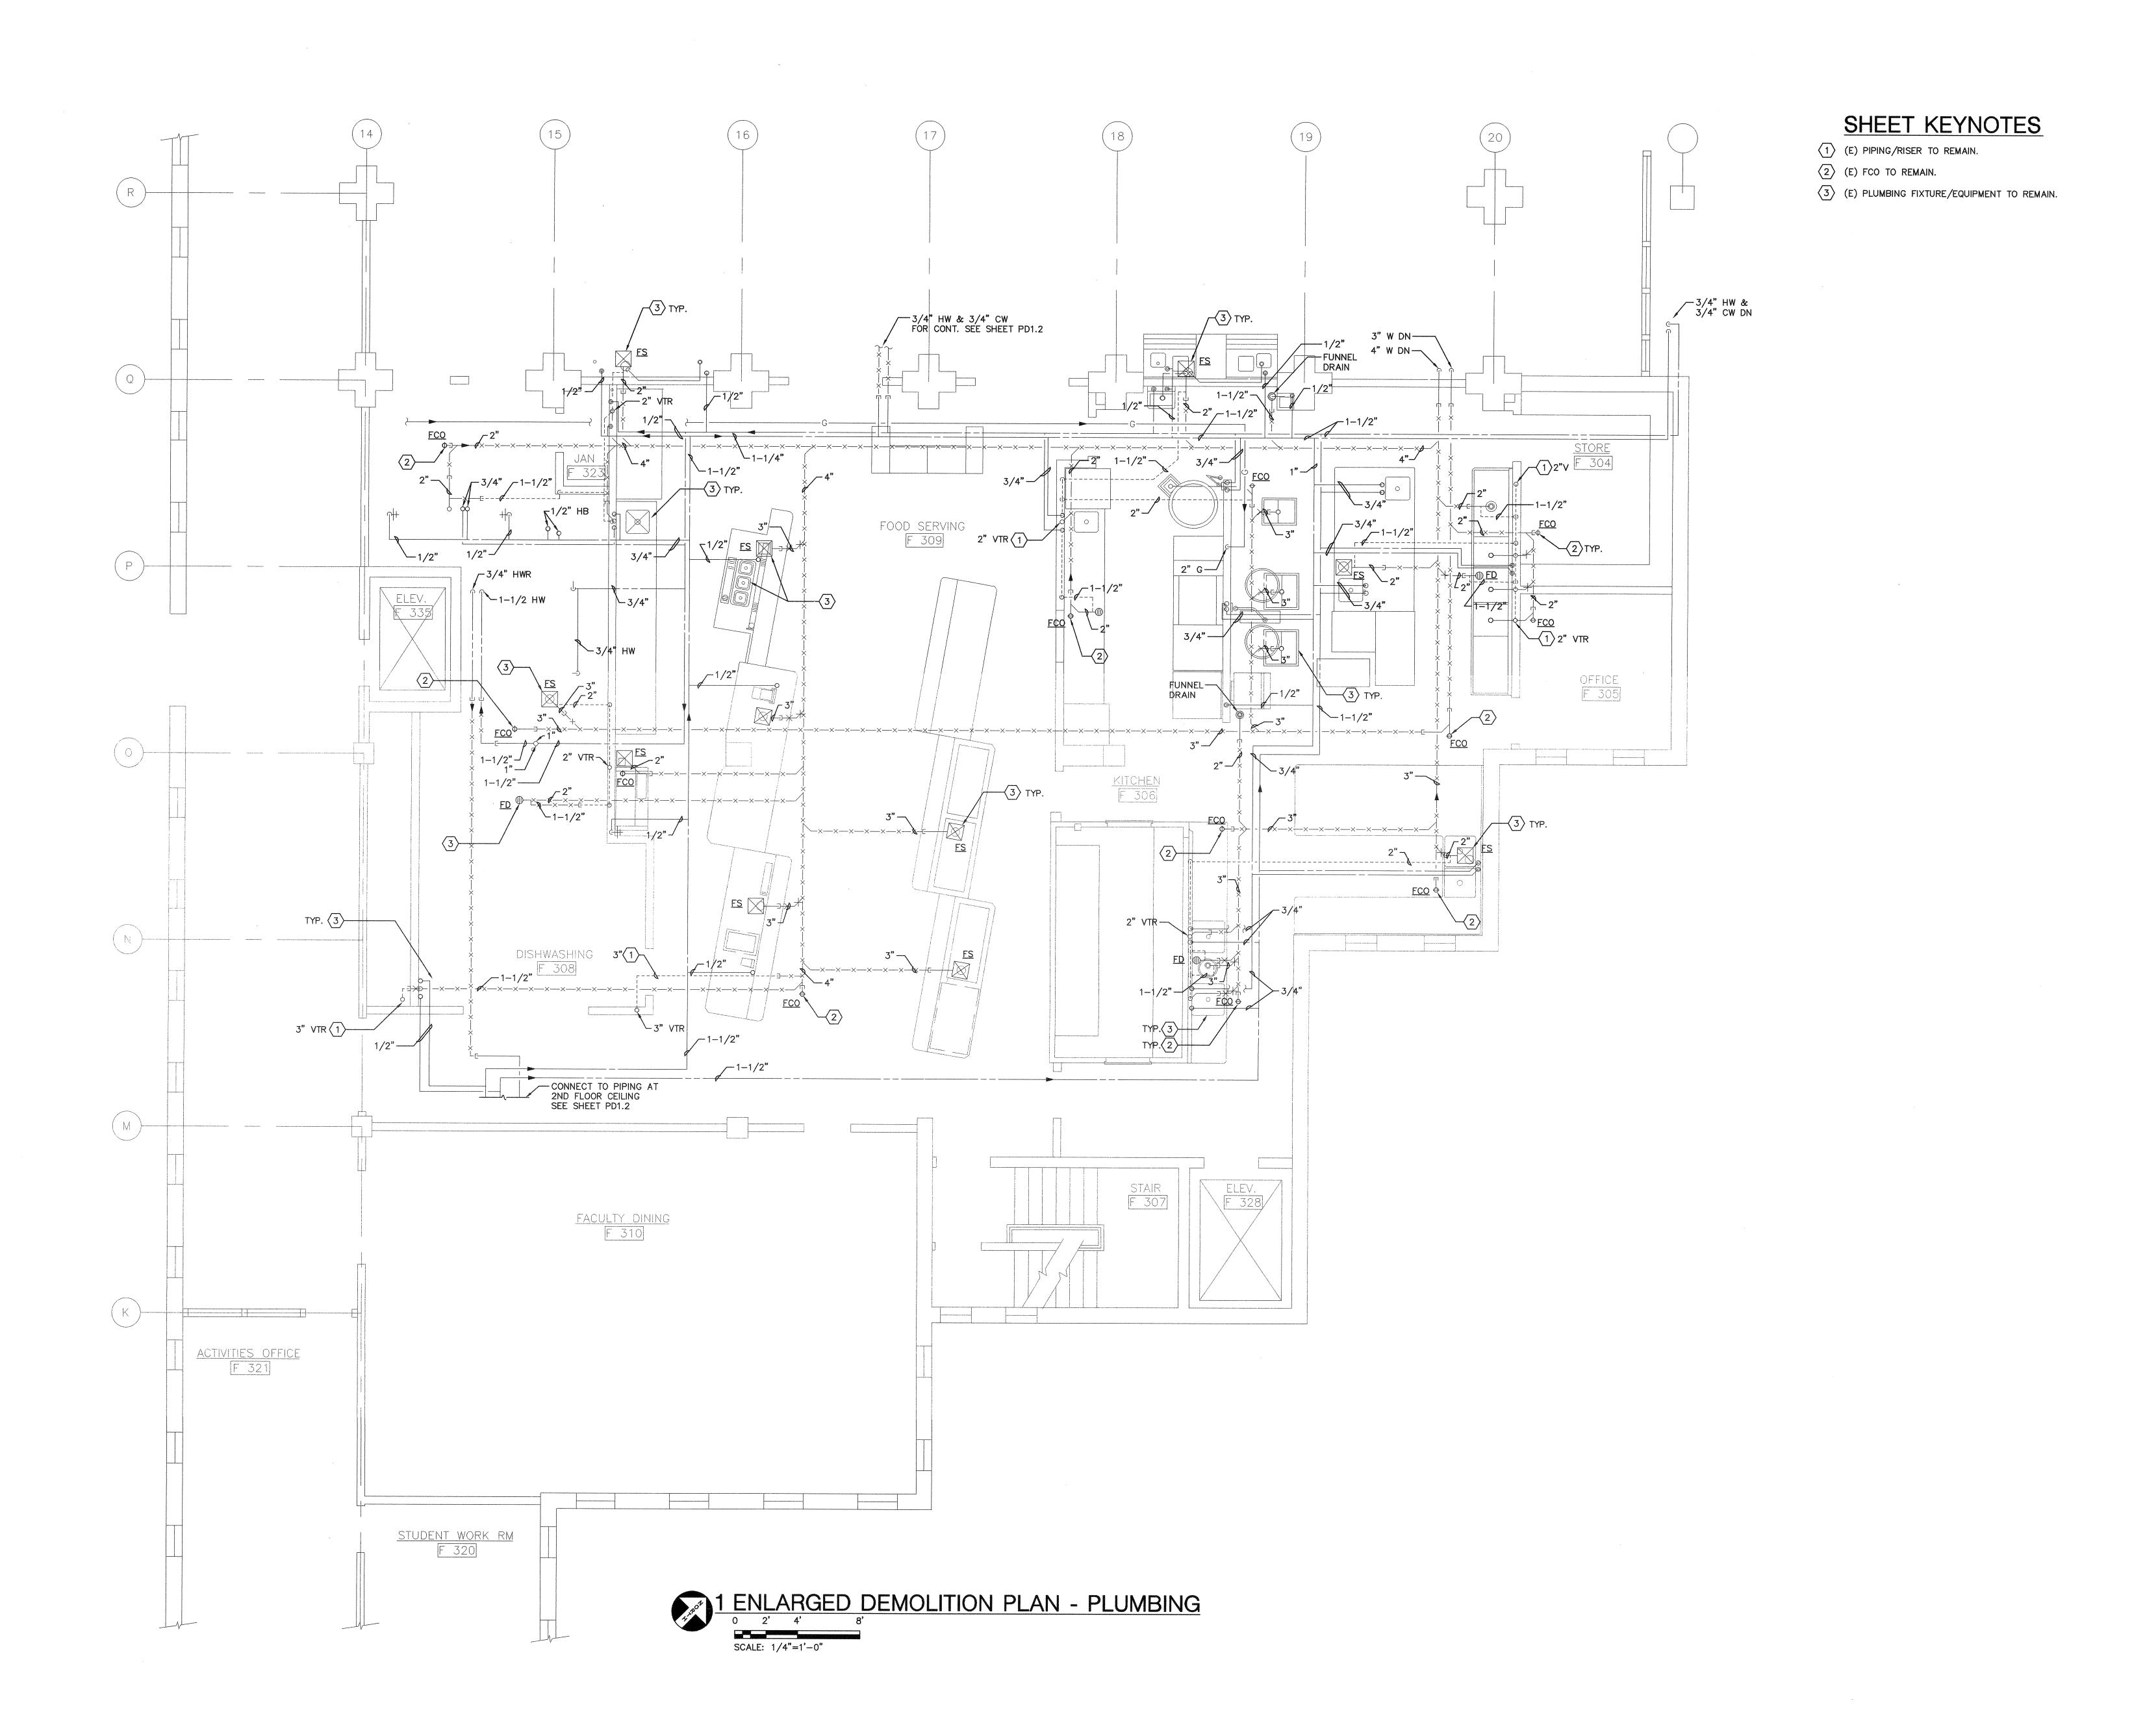
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THIRD FLOOR DEMOLITION PLAN PLUMBING

Drawing Number

PD1.3





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# BUILDINGS 5 & 6 RENOVATIONS

San Mateo County Community College District

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ENLARGED DEMOLITION PLAN


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ARCHITECT **ENGINEER** 

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BIDDING (BID #86593) E O CONSTRUCTION FILE NO. 41-C1 IDENTIFICATION STAMP DIV. OF THE STATE ARCHITECT 01- 110074 AC VAN FLS SS SS SS DATE MAR 1 9 2008

S O DSA PLAN CHECK

# BUILDINGS 5 & 6 RENOVATIONS

San Mateo County Community College District

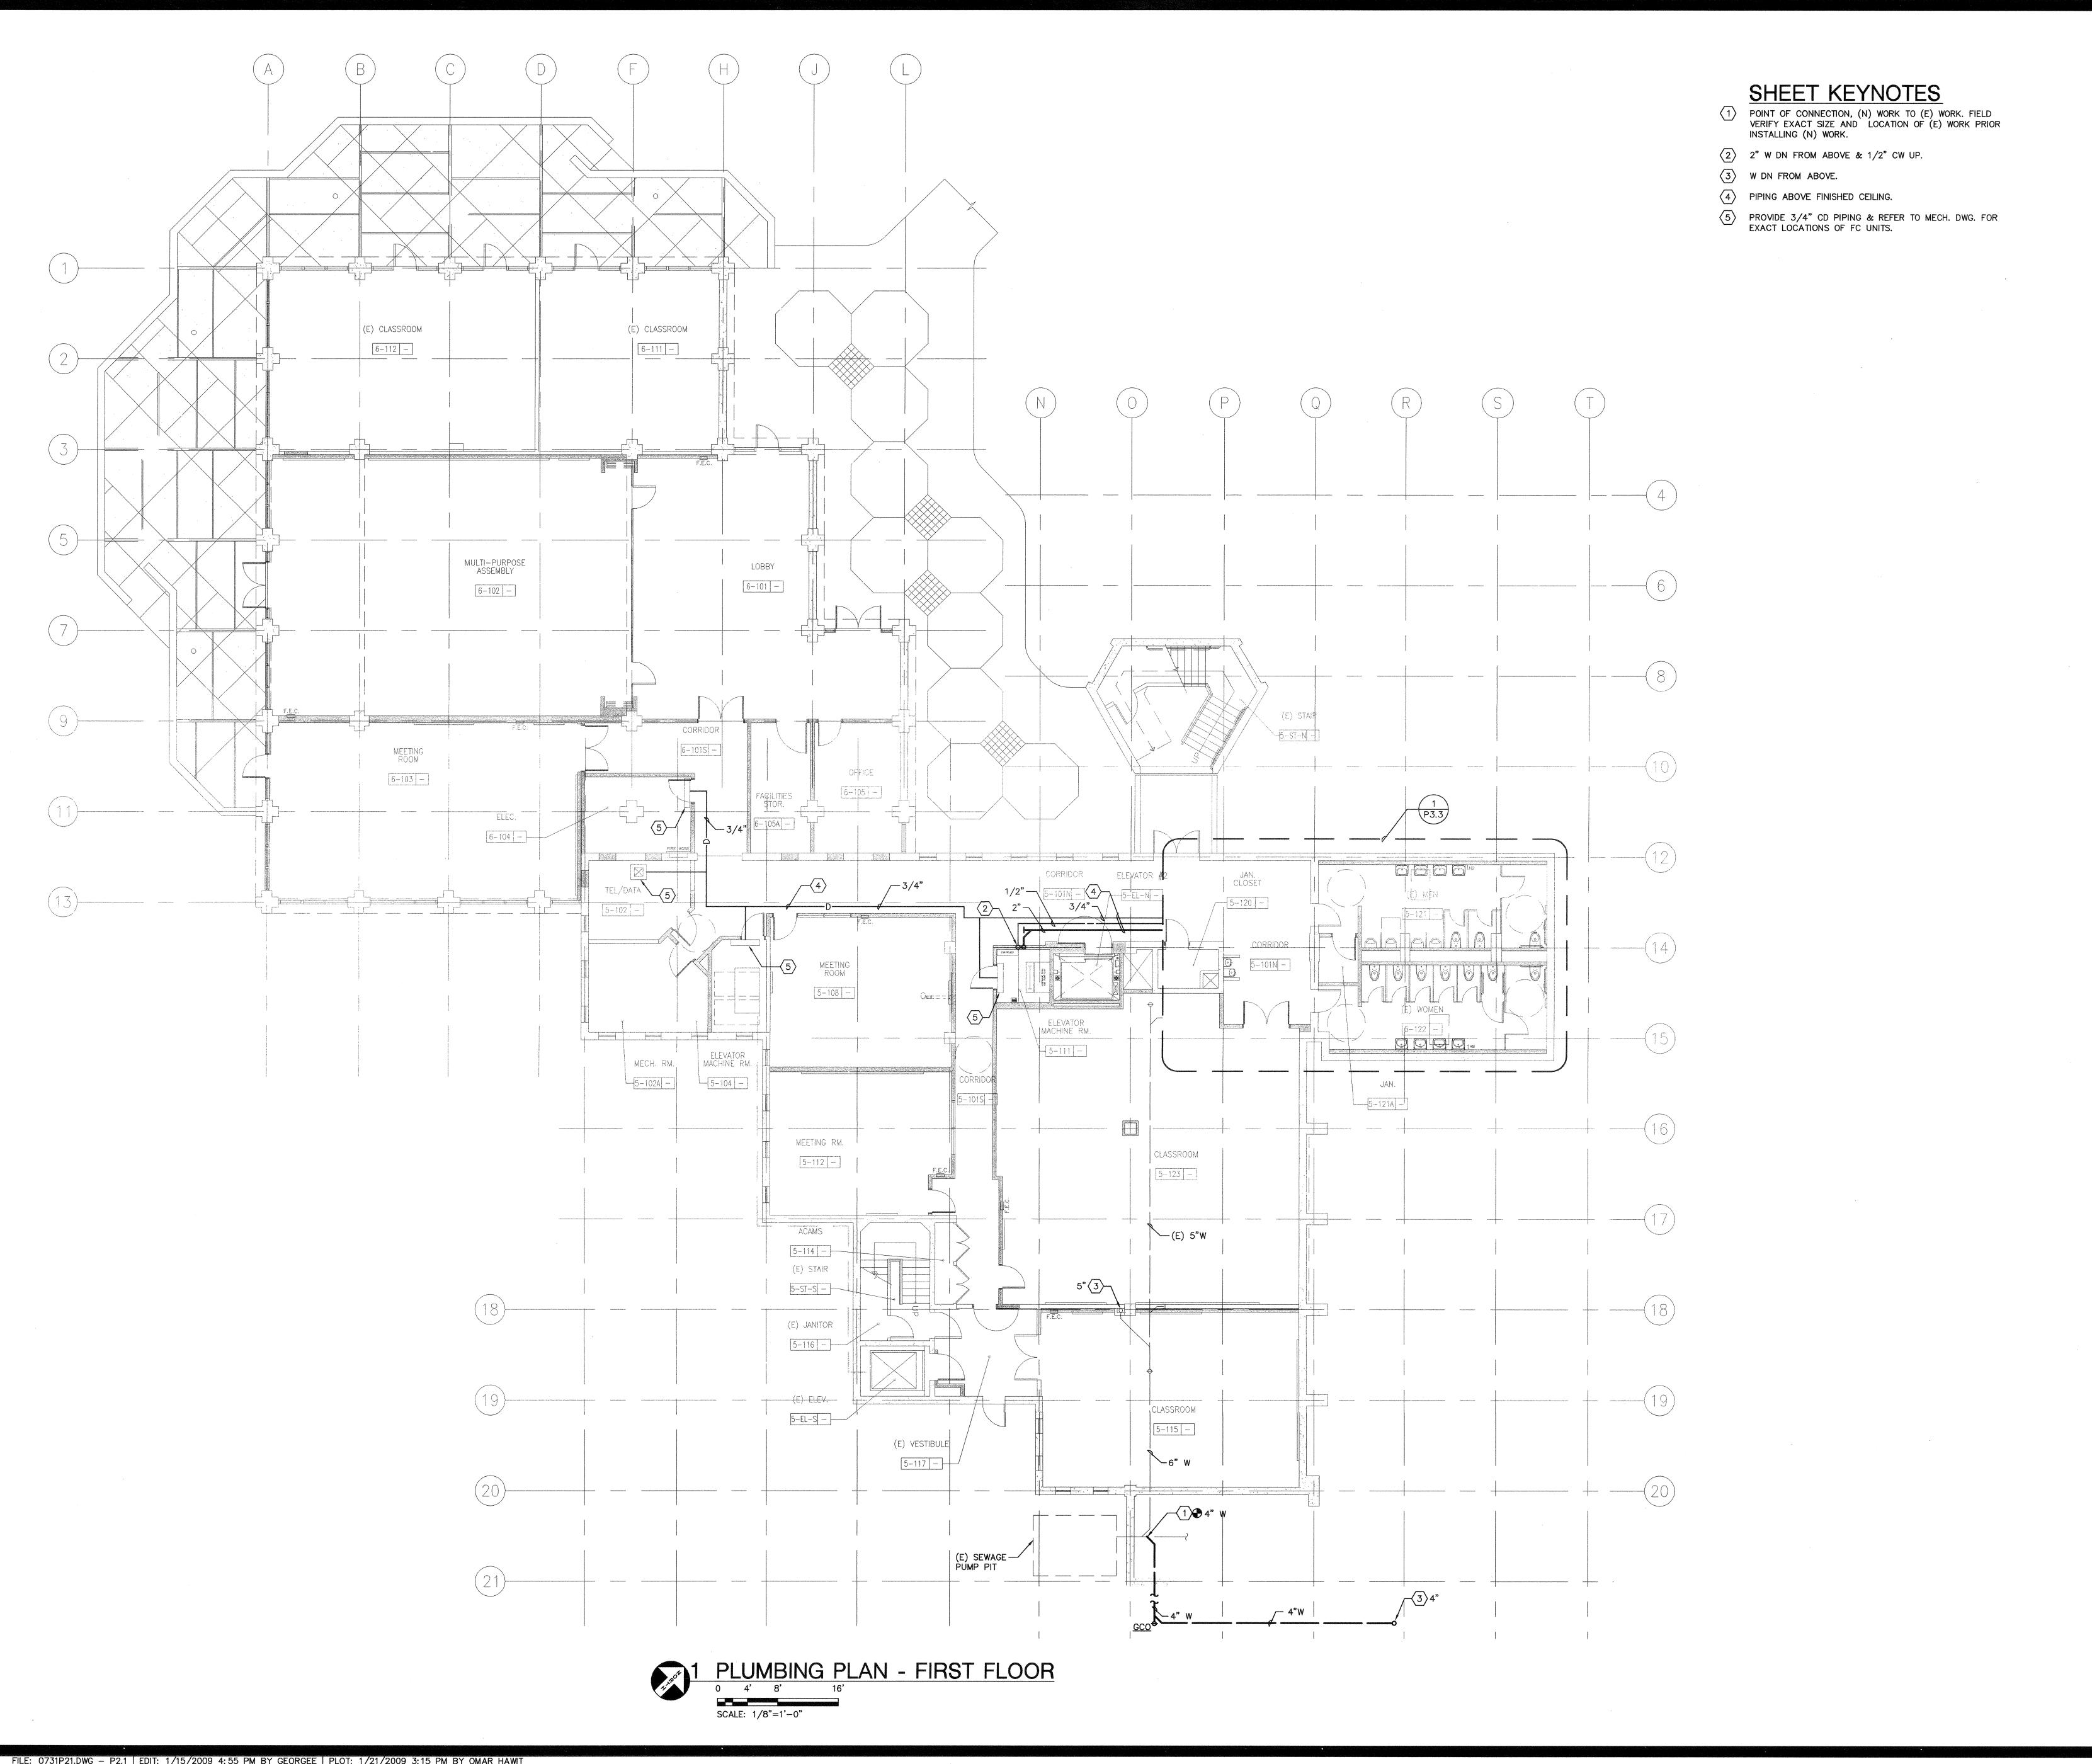DSA BACK-CHECK

CAÑADA COLLEGE 4200 Farm Hill Boulevard Redwood City, CA 94061

PLUMBING PLAN FIRST FLOOR

01/22/09 Scale


AS NOTED

07013

Project Number

Drawing Number

P2.1

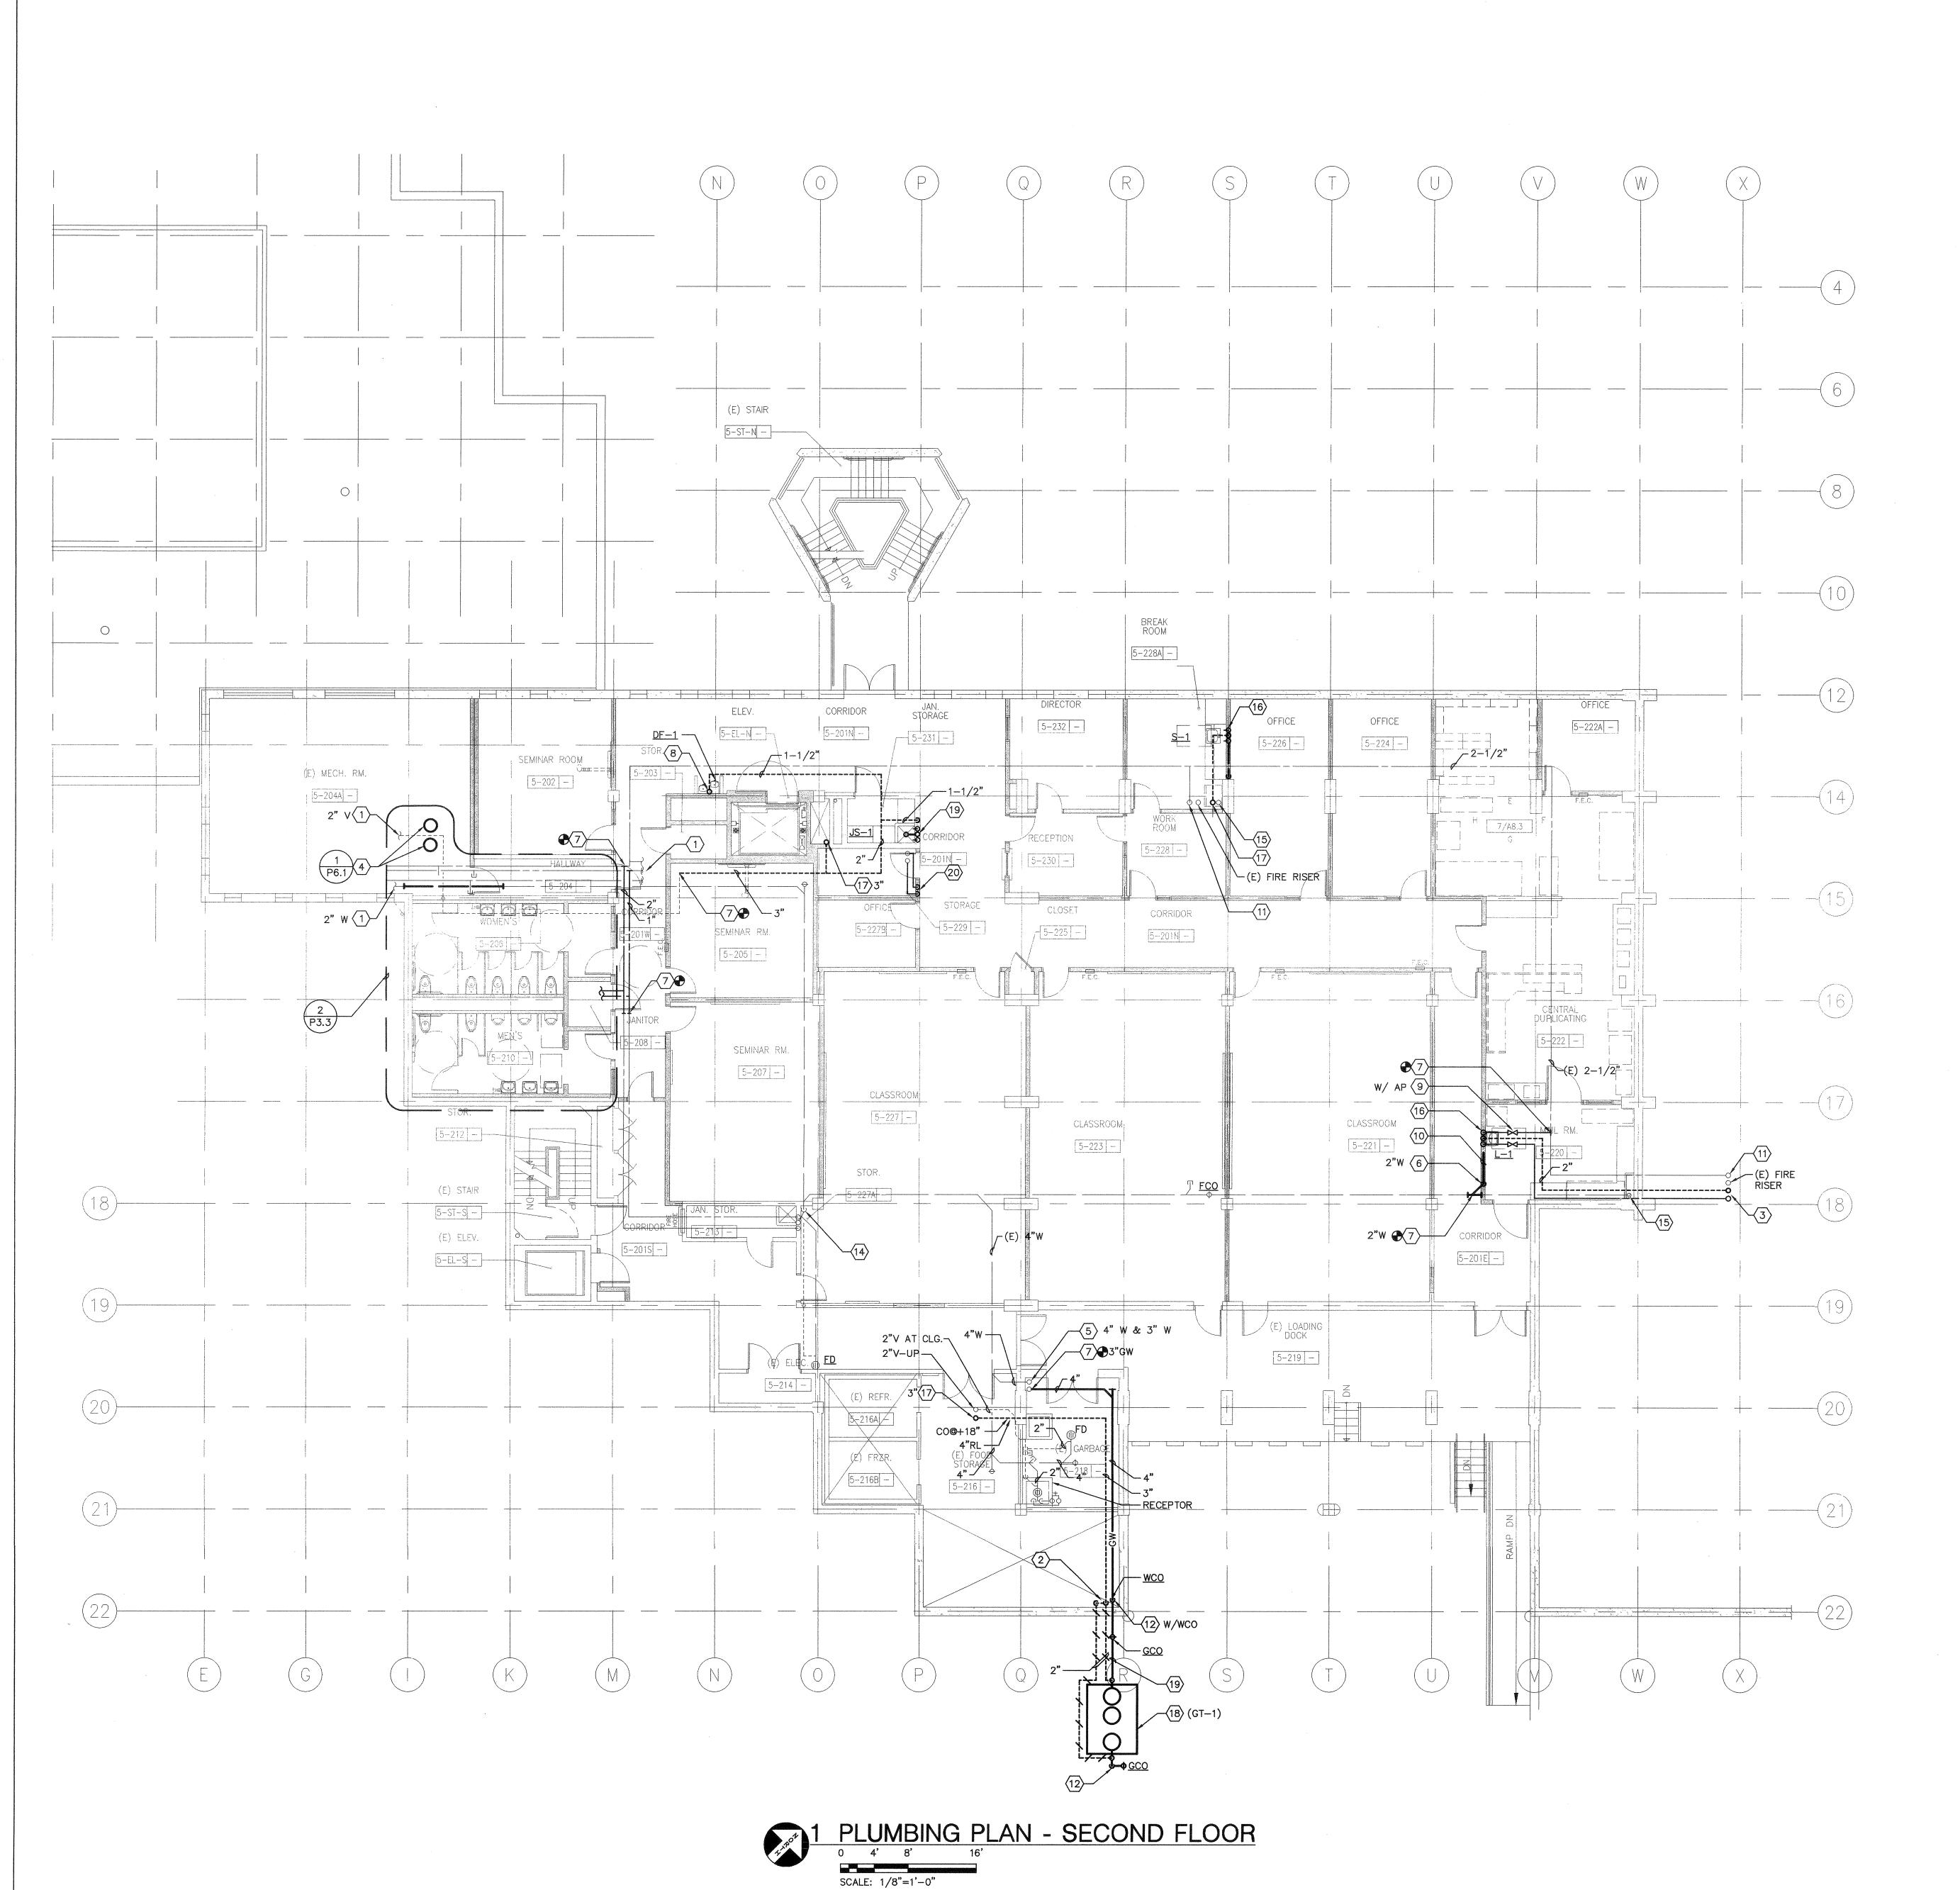

#### SHEET KEYNOTES

- for continuation, see drawing pd1.2.
- $\langle 2 \rangle$  (2)-2"V UP FROM BELOW.
- $\overline{3}$  1/2" HW DN FRCM ABOVE & 2" V UP.
- $\langle 4 \rangle$  PROVIDE (N) WH-1.
- 5 SEE P3.2 FOR CONTINUATION.
- 6 PIPE(S) DOWN THRU FLOOR.
- POINT OF CONNECTION, (N) WORK TO (E) WORK. FIELD VERIFY EXACT SIZE AND LOCATION OF (E) WORK PRIOR INSTALLING (N) WORK.
- (8) 2" W DN & 1-1/2" V UP.
- 9 LINE SIZE SHUT-OFF VALVE.
- (10) INSTALL PIPE WITH A MINIMUM SLOPE OF 2%.
- (11) (E) 2-1/2" CW RISER.
- (12) 4" GW DN.
- 13 PIPING @ CEILING SPACE INSTALL AS HIGH AS POSSIBLE.
- (E) 5" W STACK.
- (E) 4" W STACK.
- (16) 1/2" CW, 1/2" HW, 2" W DN/WCO & 1-1/2" V UP.
- (N) V STACK.
- (18) PROVIDE 1000 GALS GREASE INTERCEPTOR (GI-1).
- (19) COORDINATE W/ CIVIL ENG. DWGS. FOR INV. ELEV. OF 4" GW PIPING.
- (20) 1/2" HWR & 1-1/2" HW DN.



architecture planning interiors

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PROJECT 2007-0731 CONTACT Omar Hawit INTERFACE ENGINEERING 717 Market Street Suite 500 San Francisco, CA 94103 TEL 415.489.7240 FAX 415.489.7289 www.interfaceengineering.com ARCHITECT **ENGINEER** 

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## BUILDINGS 5 & 6 RENOVATIONS

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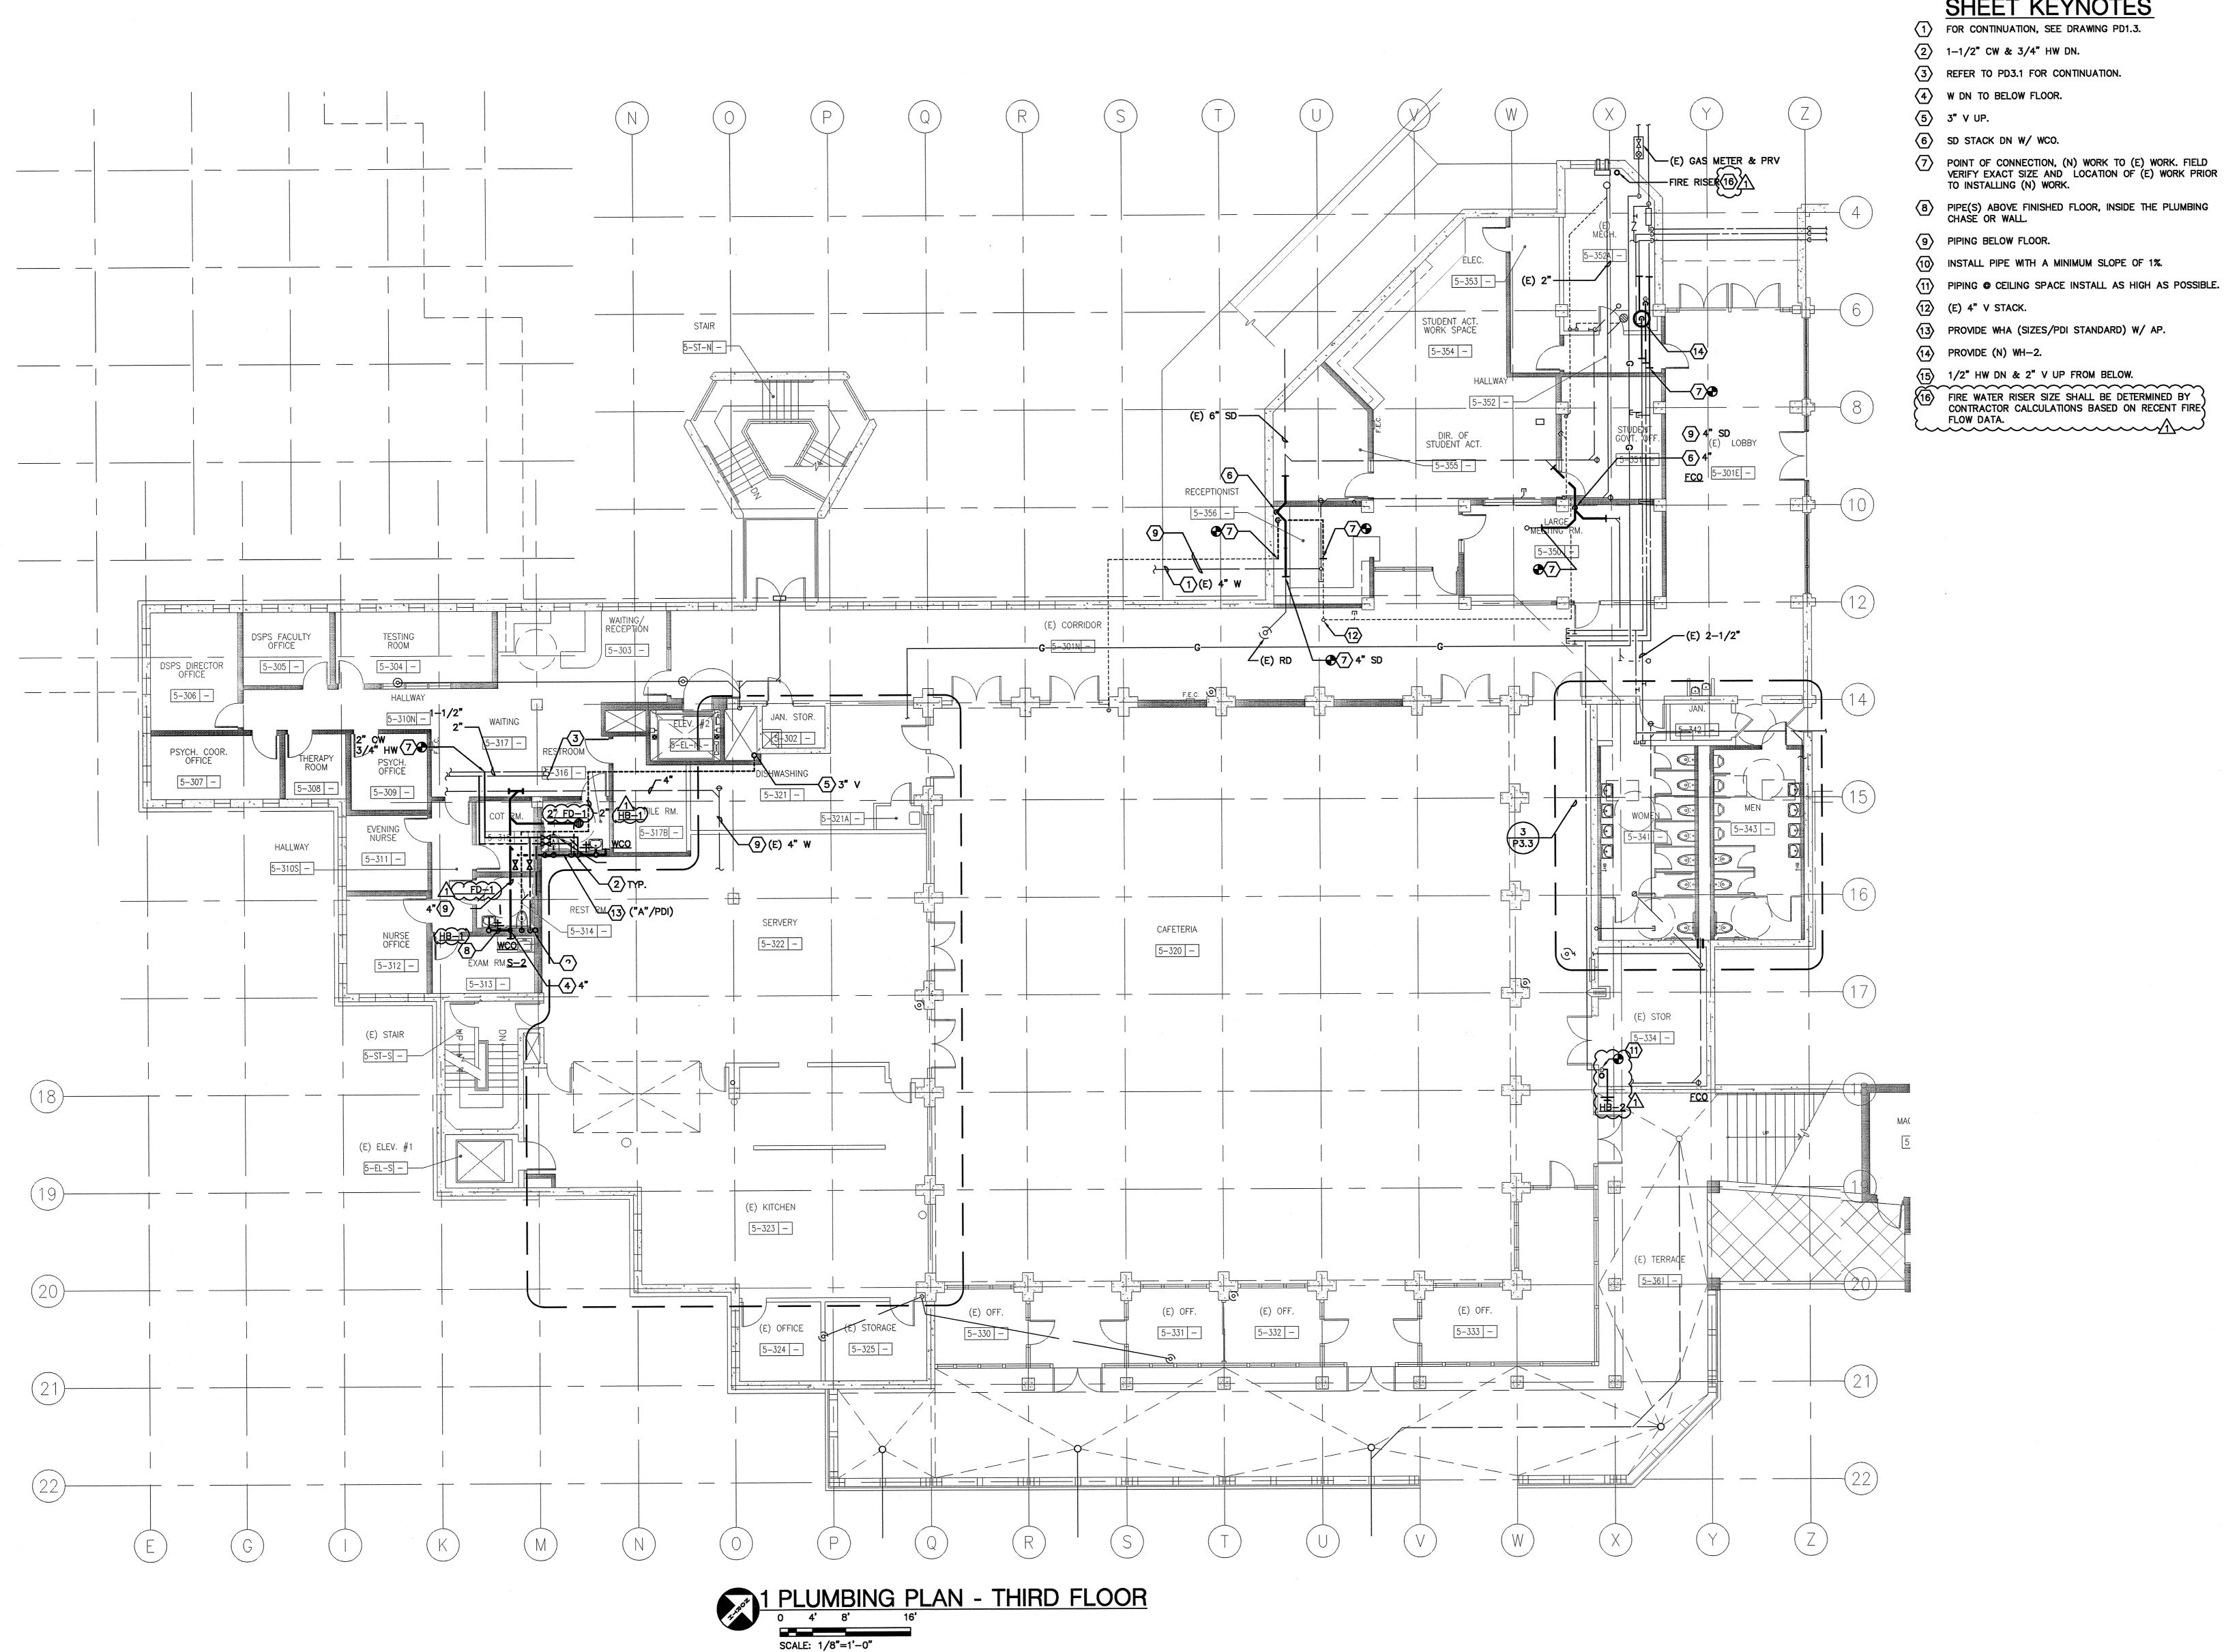
San Mateo County Community
College District

DSA BACK-CHECK

CAÑADA COLLEGE 4200 Farm Hill Boulevard Redwood City, CA 94061

PLUMBING PLAN SECOND FLOOR

Drawing Number 01/22/09 P2.2 AS NOTED Project Number



#### SHEET KEYNOTES

- $\langle 2 \rangle$  1-1/2" CW & 3/4" HW DN.

- POINT OF CONNECTION, (N) WORK TO (E) WORK. FIELD VERIFY EXACT SIZE AND LOCATION OF (E) WORK PRIOR TO INSTALLING (N) WORK.
- PIPE(S) ABOVE FINISHED FLOOR, INSIDE THE PLUMBING CHASE OR WALL.

- PROVIDE WHA (SIZES/PDI STANDARD) W/ AP.
- (15) 1/2" HW DN & 2" V UP FROM BELOW.
- 16) FIRE WATER RISER SIZE SHALL BE DETERMINED BY CONTRACTOR CALCULATIONS BASED ON RECENT FIRE

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BIDDING (BID #86593)	09/18/09
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	FILE NO. 41-C1	
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#### BUILDINGS 5 & 6 RENOVATIONS

San Mateo County Community College District

**BID ADDENDA** 

# CAÑADA COLLEGE


4200 Farm Hill Boulevard Redwood City, CA 94061

PLUMBING PLAN THIRD FLOOR

Drawing Number

Project Number

P2.3

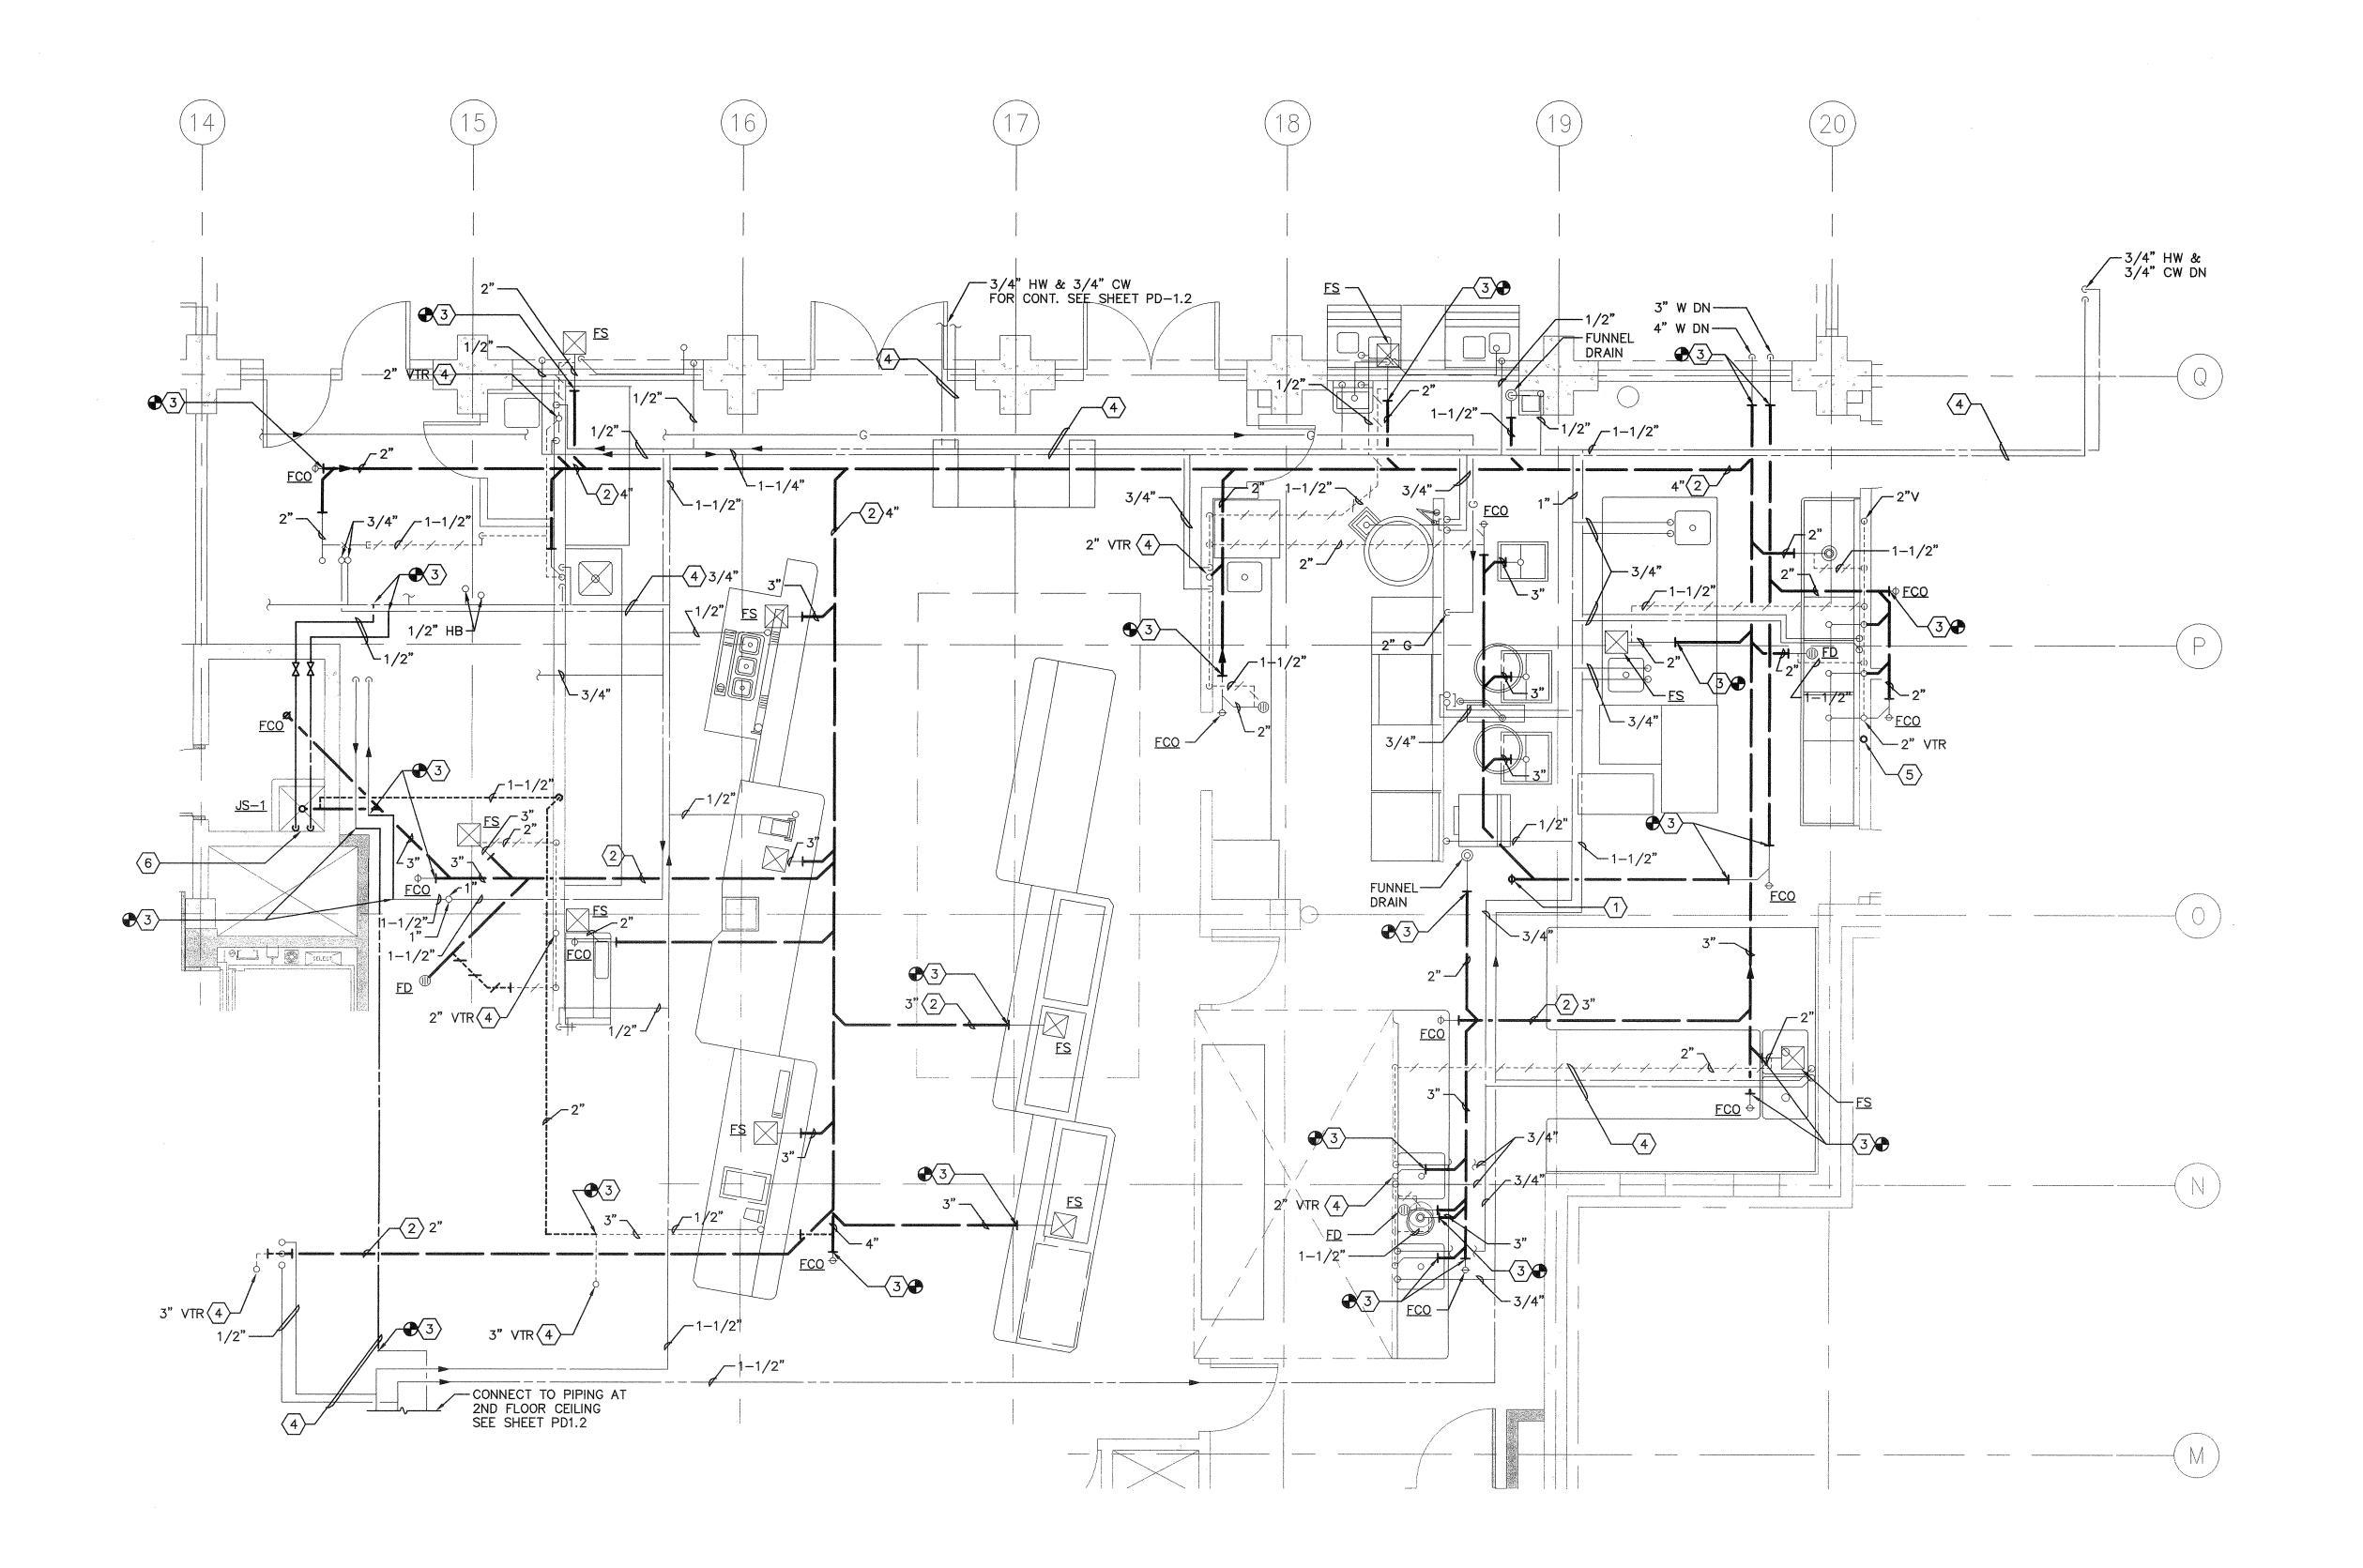

# 1 ENLARGED PLAN - PLUMBING O 2' 4' 8' SCALE: 1/4"=1'-0"

#### SHEET KEYNOTES

- PROVIDE (N) FCO.
- 2 PIPING BELOW FLOOR.
- POINT OF CONNECTION, (N) WORK TO (E) WORK, FIELD VERIFY EXACT SIZE AND LOCATION OF (E) WORK PRIOR INSTALLING (N) WORK.
- (E) PIPING TO REMAIN.
- $\overline{5}$  (N) 3" V UP THRU ROOF.
- 6 1/2" CW & 1/2" HW DN.

# BCA

architecture planning interiors

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#### BUILDINGS 5 & 6 RENOVATIONS


San Mateo County Community College District

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ENLARGED PLAN
PLUMBING


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Project Number
07013



ENLARGED PARTIAL PLAN

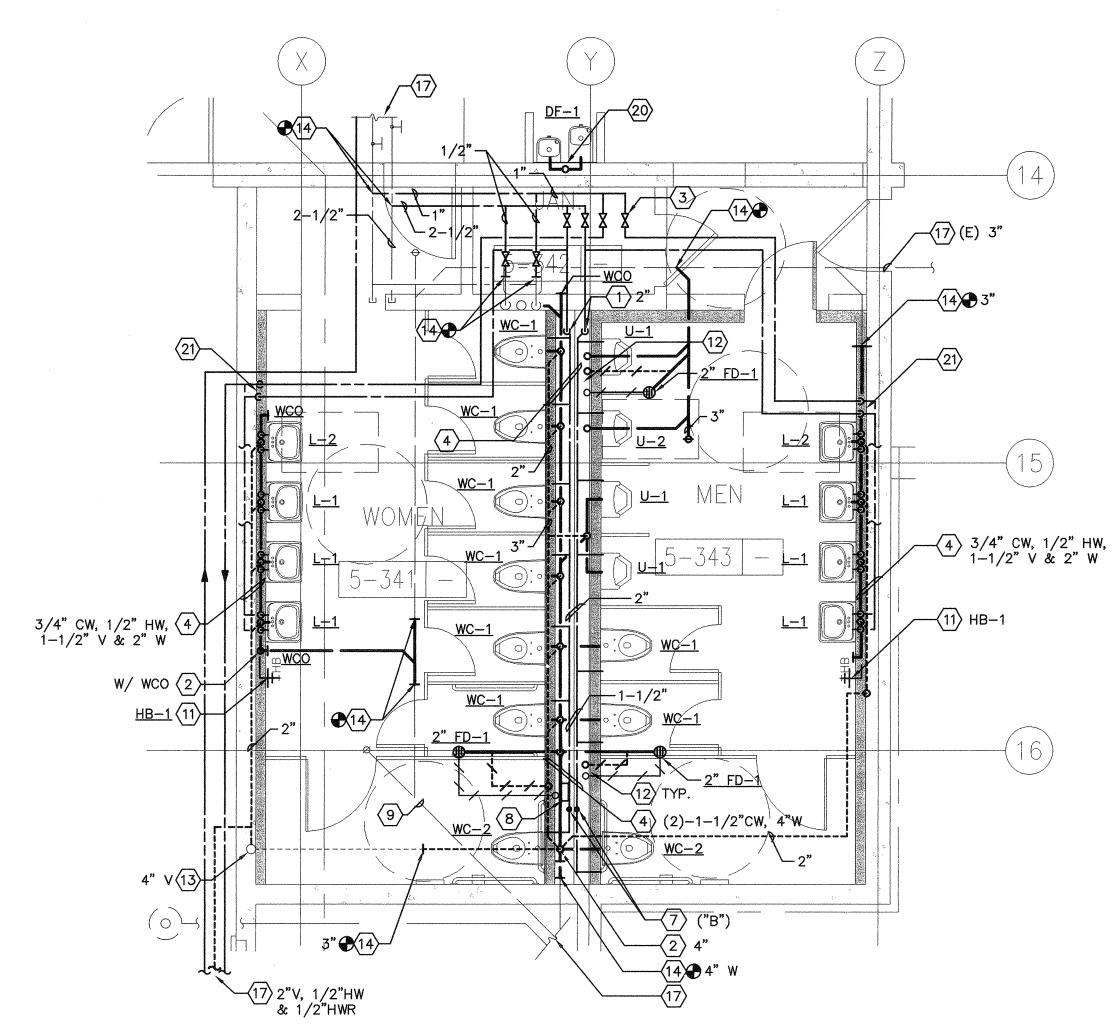3 (WOMEN'S RM 5-341 & MEN'S RM 5-343)

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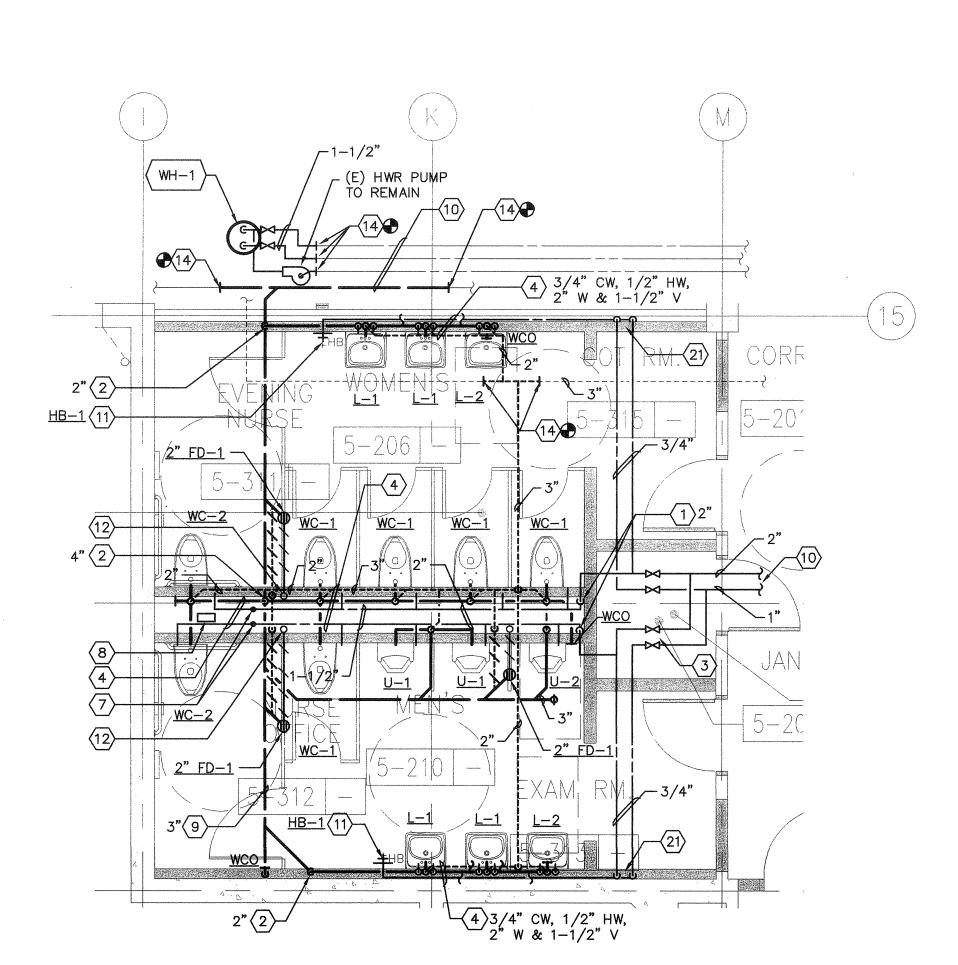


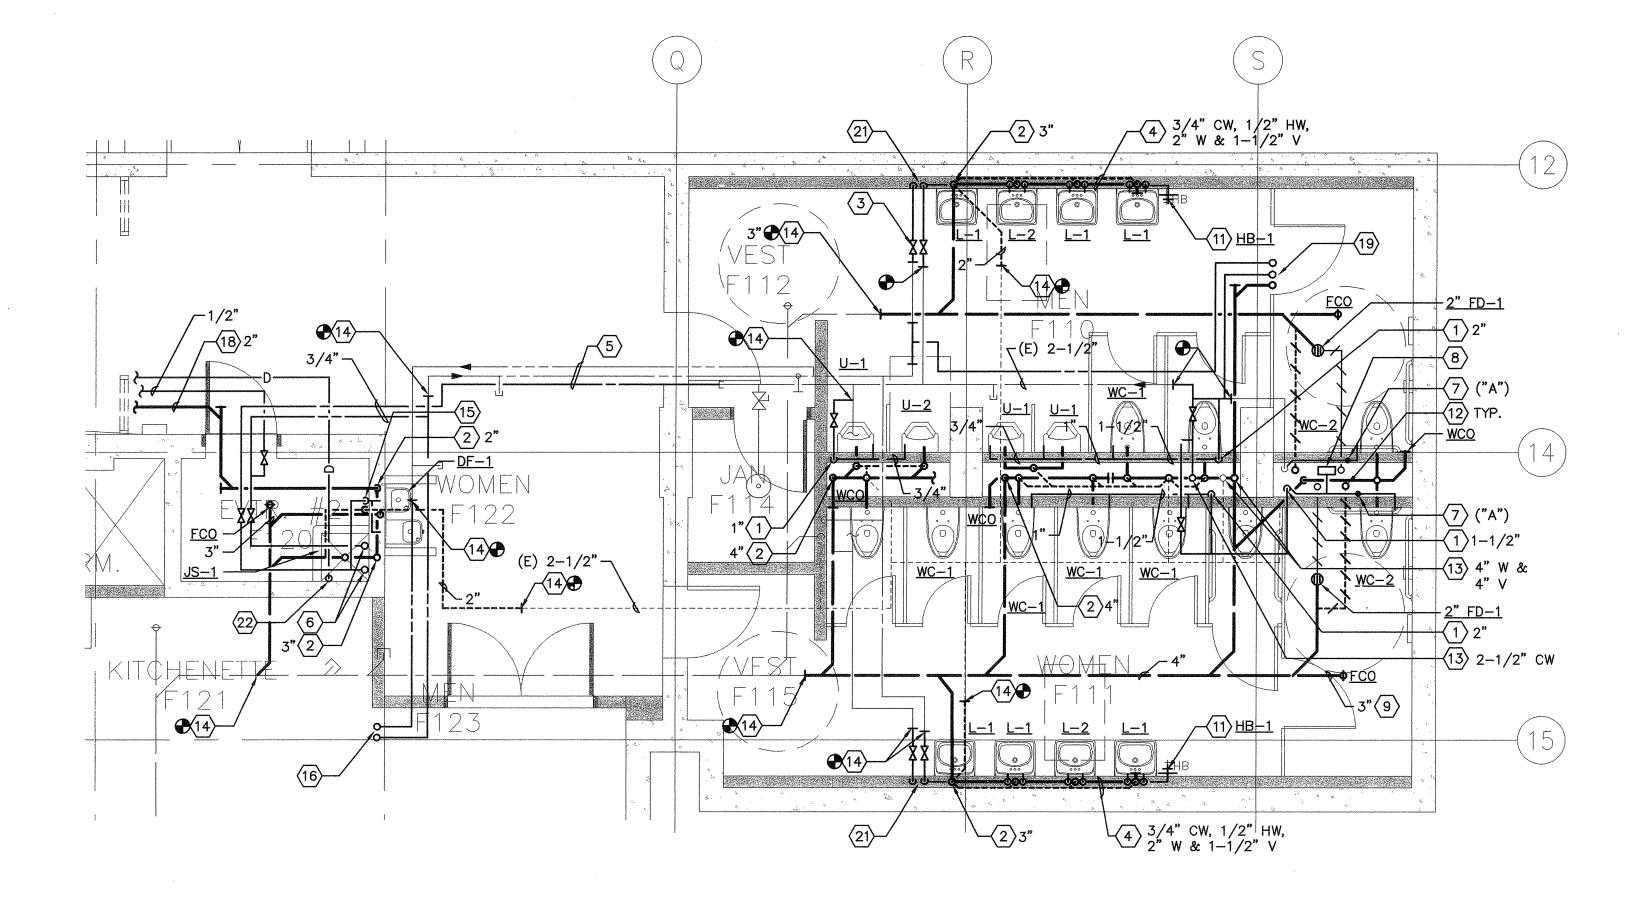ENLARGED PARTIAL PLAN

1 (MEN'S RM 5-121 & WOMEN'S RM 5-122)

0 2' 4' 8'

SCALE: 1/4"=1'-0"



ENLARGED PARTIAL PLAN

2 (WOMEN'S RM 5-206 & MEN'S RM 5-210)

0 2' 4' 8'

SCALE: 1/4"=1'-0"

#### SHEET KEYNOTES

- 1 CW DN.
- 2 W DN.
- 3 LINE SIZE SHUT-OFF VALVES.
- 4 PIPING ABOVE FINISHED FLOOR INSIDE WALL/CHASE.
- 5 PIPING ABOVE FINISHED CEILING.
- 6 3/4" CW & 3/4" HW UP & DN.
- 7 PROVIDE WHA (SIZE/PDI STANDARD) W/ AP.
- $\overline{\langle 8 \rangle}$  PROVIDE 1/2" CW, SOV TO TPV-1 @ +16" AFF FOR FD/FS.
- 9 PIPING BELOW FLOOR.
- (10) REFER TO P2.2 FOR CONTINUATION.
- (11) INSTALL 3/4" HB @ +18" AFF.
- (12) 1-1/2" V UP & 1/2" TP DN.
- (E) PIPING/RISER TO REMAIN.
- POINT OF CONNECTION, (N) WORK TO (E) WORK.
  FIELD VERIFY EXACT SIZE AND LOCATION OF (E) WORK
  PRIOR INSTALLING (N) WORK.
- PROVIDE 1/2" CW W/ SOV TO DF.
- 1-1/2" HW & 3/4" HWR UP & CONNECT TO (E).
- REFER TO P2.3 FOR CONT.
- (18) INSTALL PIPE WITH A MINIMUM SLOPE OF 2%.
- (19) 1/2" CW & 1/2" HW UP & 2" W DN FROM ABOVE. (20) MODIFY FROM (E) PIPING & PROVIDE 1/2" CW W/ SOV, 2" W & 1-1/2" V TO DF.
- (21) 3/4" CW & 3/4" HW DN.
- 22 3/4" CD PIPING DN & TERMINATE 2" ABOVE JS-1.



architecture planning interiors

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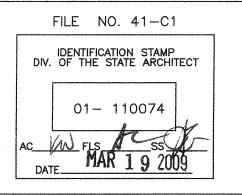
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BIDDING (BID #86593)

CONSTRUCTION



#### BUILDINGS 5 & 6 RENOVATIONS

San Mateo County Community College District

DSA BACK-CHECK

CAÑADA COLLEGE 4200 Farm Hill Boulevard Redwood City, CA 94061

ENLARGED PLAN PLUMBING

07013

Date
01/22/09

Scale
AS NOTED

Project Number

	PLUMBING EQUIPMENT SCHEDULE	
SYMBOL	DESCRIPTION	ELECTRICAL
CP-1 W/	CIRCULATING PUMP: MANUFACTURER BELL & GOSSETT,	120 V
(HW-2)	MODEL NBF-8 S/P, 2.0 GPM, 7' OF HEAD	1 ø
		1 AMP
		60 Hz
WH-1	ULTRA SUPERSTOR MODEL SSU-119C WITH INTERNAL DOUBLE WALL HEAT EXCHANGER,	
W/ ET-1	119 GALLONS STORAGE, INPUT 180°F,	
	OUTPUT = 490 GPH AT 140°F OF HOT WATER. 210 LBS.	
WH-2	ULTRA SUPERSTOR MODEL SSU-80DW WITH INTERNAL DOUBLE WALL HEAT EXCHANGER	
W/ ET-2	80 GALLONS STORAGE, INPUT 180°F,	other total
	OUTPUT = 138 GPH AT 140°F OF HOT WATER. 141 LBS.	
WHA-1	WATER HAMMER ARRESTER	<del></del>
	ZURN SHOKTROLS Z1700 SERIES	
GI-1	GREASE INTERCEPTOR, 1000 GAL. CONCRETE TANK UTILITY VAULT	
	MODEL 4484—GA.	
BV-1	BALANCING VALVE - NIBCO MODEL - 1/2" FIG. T 1710.	·
ET-1 &	"AMTROL" - THERM-X-TROL # ST-25V	
ET-2		
BFP-1	BACKFLOW PREVENTER — "WILKINS" MODEL 950 XLTS 1"Ø	· · · · · · · · · · · · · · · · · · ·

				ECTION	
SYMBOL DF-1	DESCRIPTION  DRINKING FOUNTAIN: WALL HUNG, STAINLESS STEEL, DUAL HEIGHT,	1-1/2"	<b>V</b> 1-1/2"	<b>CW</b> 1/2"	HV
ADA	ADA COMPLIANT, FLEXI—GUARD SAFETY BUBBLER, FRONT PUSH BUTTON, SELF—CLOSING VALVE, AUTOMATIC STREAM REGULATION VANDAL—RESISTANT BOTTOM PLATE. HAWS 1119, MOUNTING PLATE 6700.4 FITTINGS: 1-1/2 IN. TAIL PIECE, SCREWDRIVER STOP, TUBING SUPPLY. SUPPORT CARRIER: MODEL 6800.				
FD-1	FLOOR DRAIN: CAST IRON BODY WITH ADJUSTABLE ROUND POLISHED NICKEL BRONZE STRAINER. STANDARD SCREWS. TRAP PRIMER CONNECTION. J.R. SMITH 2005-A	2"	1-1/2*		
FD-2	FLOOR DRAIN: CAST IRON BODY WITH ADJUSTABLE ROUND TOP ANTI-FLOOD RIM, NICKEL BRONZE STRAINER HEAD AND RECESSED STRAINER, LOOSE GRATE. STANDARD SCREWS. TRAP PRIMER CONNECTION. J.R. SMITH 2005-F37	2"	1-1/2*		
HB-1	HOSE BIBB: WALL FAUCET, INSIDE USE, WITH E27JKCP INTEGRAL VACUUM BREAKER, POLISHED CHROME, TEE HANDLE, CHICAGO-293-CP			3/4"	
JS-1	JANITOR SINK: FLOOR MOUNTED, 28 IN. X 28 IN., CORNER TYPE, ACID—RESISTANT, ENAMELED CAST IRON, [RIM GUARDS.] KOHLER K—6710 "WHITBY" FAUCET: HOSE—END SPOUT TYPE WITH INTEGRAL VACUUM BREAKER, ADJUSTABLE ARMS WITH INTEGRAL STOPS, AND WALL BRACE. CHROME. CHICAGO 897—CP	3"	1-1/2*	1/2"	1/2
L-1	LAVATORY: WALL HUNG, VITREOUS CHINA, 20-3/4 IN. BY 18-3/4 IN., FRONT OVERFLOW, ANTI-BACKSPLASH.  KOHLER K-2032 "GREENWICH" WITH 4 IN. CENTER FAUCET HOLES. FITTINGS: 1-1/4 IN. BY 1-1/2 IN. P-TRAP. SUPPLIES AND STOPS.  CARRIER: FLOOR MOUNTED WITH CONCEALED ARMS,  J.R. SMITH AS APPLICABLE.  FAUCET: METERING/SELF-CLOSING TYPE, 4 IN. CENTERS,  ADJUSTABLE SLOW CLOSING, TEMPERATURE LIMIT STOP, IN-LINE CHECK/SCREEN ASSEMBLIES, 0.5 GPM AERATOR,  GRID STRAINER, CHROME.  SYMMONS S-60-1-H WITH POP-UP DRAIN INSTEAD OF GRID STRAINER	1-1/2*	1-1/2"	1/2"	1/2
L-2 ADA	SAME AS L-1 EXCEPT FOR ADA COMPLIANT & PROVIDE INSULATION KIT TO P-TRAP AND SUPPLIES. SEE SPECIFICATIONS.	1-1/2"	1-1/2"	1/2"	1/:
REC-1	ROOF CEPTOR, DURA-COATED CAST IRON BODY  ZURN MODEL-Z-122	3"			
S-1 ADA	SINK: JUST MODEL SL-ADA-2122-A-GR,  18 GAUGE TYPE 304 18-8 STAINLESS  21" FRONT TO BACK x 22" LEFT TO RIGHT x 6" DEPTH,  WITH FAUCET AND BUBBLE LEDGE.  FAUCET: CHICAGO 786-SWCP, DECK-MOUNTED,  WITH GN2B RIGID/SWING GOOSENECK SPOUT, 317 WRIST BLADE	2"	1-1/2"	1/2**	1/2
S-2 ADA	EXAM SINK: JUST MODEL SL-ADA-2217-A-GR, 18 GAUGE TYPE 304 18-8 STAINLESS STEEL, INSIDE DIMENSION: 16" FRONT-TO-BACK x 14" LEFT TO RIGHT x 6-1/2" DEEP WITH FAUCET AND BUBBLE LEDGE.  FAUCET: CHICAGO 626; DECK MOUNTED SINGLE WATER INLET, WITH GN2A GOOSENECK SPOUT WITH LAMINAR FLOW OUTLET; CHICAGO-625-SLO COMBINATION PEDAL VALVE WITH 628XSLO NAIAD ADJUSTABLE SELF-CLOSING CARTRIDGE.  DRAIN: JUST J-35-SSF, STAINLESS STEEL FLAT GRID DRAIN.				
TPV-1	TRAP PRIMER MIFAB TRAP SEAL PRIMER MODEL MR-500 SERIES				
U-1	URINAL: SIPHON JET, VITREOUS CHINA, WALL MOUNTED, HIGH EFF. URINAL SYSTEM 3/4 IN. TOP SPUD.  ZURN Z5798  FLUSH VALVE: 0.125 GAL. PER FLUSH, TOP SPUD.  (INFRARED SENSOR/BATTERY)  CARRIER: FLOOR MOUNTED.  J.R. SMITH 0600 SERIES URINAL SUPPORT WITH SUPPORTING STUDS  AND BOTTOM BEARING PLATE.	2"	1-1/2"	3/4"	
U-2	SAME AS U-1 EXCEPT ADA COMPLIANT	2"	1-1/2"	3/4"	
WC-1	WATER CLOSET: WALL HUNG, SIPHON JET ACTION, VITREOUS CHINA, ELONGATED BOWL, 1–1/2 IN. TOP SPUD FOR EXPOSED FLUSH VALVE, BOLT CAPS. MOUNTING HEIGHT STANDARD. KOHLER K-4330 "KINGSTON" SEAT: OPEN FRONT, COMMERCIAL WEIGHT HEAVY-DUTY PLASTIC, STAINLESS STEEL CHECK HINGE, WHITE, WITHOUT COVER. CHURCH 9500C. FLUSH VALVE: 1.6 GAL. PER FLUSH DOWN/1.1 GAL. PER FLUSH UP, TOP SPUD. SLOAN WES-111 (MANUAL OPERATION) CARRIER: J.R. SMITH 0200 SERIES OR EQUAL.	4"	2"	1-1/2"	
WC-2 ADA	WATER CLOSET: WALL HUNG, SIPHON JET ACTION, VITREOUS CHINA, ELONGATED BOWL, 1-1/2 IN. TOP SPUD FOR EXPOSED FLUSH VALVE, BOLT CAPS. MOUNTING HEIGHT ADA COMPLIANT. KOHLER K-4330 "KINGSTON" SEAT: OPEN FRONT, COMMERCIAL WEIGHT HEAVY-DUTY PLASTIC, STAINLESS STEEL CHECK HINGE, WHITE, WITHOUT COVER. CHURCH 9500C. FLUSH VALVE: 1.6 GAL. PER FLUSH DOWN/1.1 GAL. PER FLUSH UP, TOP SPUD. SLOAN WES-111 (MANUAL OPERATION) CARRIER: J.R. SMITH 0200 SERIES OR EQUAL.	4**	2"	1-1/2"	
<u> </u>	WOODFORD TRIMLINE WALL HYDRANT MODEL B75, CONCEALED BOX TYPE. INTEGRAL ANTI—SIPHON VACUUM BREAKER, 3/4" MALE HOSE THREAD, 3/4" FEMALE INLET PIPE	<del>                                     </del>	<b>~~~</b>	<del>                                     </del>	~



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FILE NO. 41—C1

IDENTIFICATION STAMP
DIV. OF THE STATE ARCHITECT

O1— 110074

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#### BUILDINGS 5 & 6 RENOVATIONS

San Mateo County Community College District

**BID ADDENDA** 


CAÑADA COLLEGE 4200 Farm Hill Boulevard Redwood City, CA 94061

PLUMBING FIXTURE SCHEDULE

Date
08/29/08

Scale
AS NOTED

Project Number

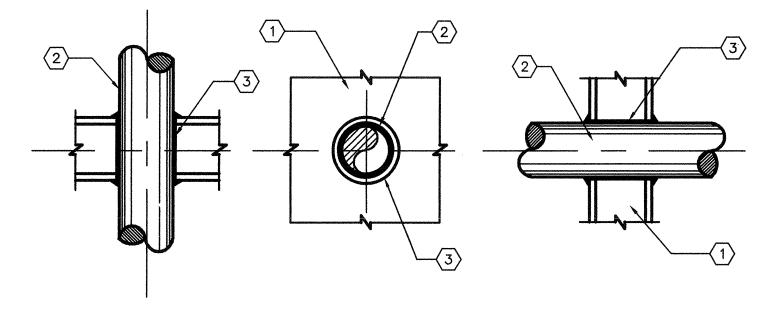


PACK SPACE BETWEEN PIPING AND PENETRATION OPENING WITH MATERIAL APPROVED BY UNDERWRITERS LABORATORIES FOR THROUGH PENETRATION FIRE STOP SYSTEMS. MATERIALS, METHODS, AND INSTALLATION SHALL BE IN ACCORDANCE WITH UL APPROVED LISTING AND SHALL BE DESIGNED TO ACT AS A FIRESTOP AS WELL AS A COLD SMOKE, NOXIOUS GAS AND WATER SEALANT. SUBMIT LISTING NUMBERS AND DETAILS FROM UL FIRE RESISTANT DIRECTORY FOR ALL SUCH SYSTEMS TO BE USED. INSULATE PIPES 3 FEET TO EITHER SIDE OF PENETRATION WITH MATERIAL SPECIFIED IN THE UL FIRE RESISTANCE DIRECTORY IF REQUIRED TO OBTAIN THE T— AND F— RATINGS.

- (1) WALL AND FLOOR
- 2 PIPE OR INSULATED PIPE
- FIRE BARRIER "3M PRODUCTS INC." FIRE BARRIER CAULK CP25 WB+, CP 25WB, CP 25 N/S AND S/L, FIRE BARRIER 2000+, 2000 AND 2003 SILICONE SEALANTS, MOLDARIE PLITTY


USE FOLLOWING APPLICABLE UL SYSTEMS FOR THE CONSTRUCTION TYPES LISTED.

CONSTRUCTION TYPE	THROUGH PENETRATION FIRESTOP SYSTEM NUMBERS
CONCRETE FLOORS	CAJ1007 (F-2, 3, 4 HR; T-0 HR), CAJ1010 (F-2 HR; T-0 HR), CAJ1012 (F-1 HR; T-0 HR), CAJ1017 (F-2, 3 HR; T-0 HR), CAJ1021 (F-3 HR; T-0, 1.5 HR), CAJ1027 (F-3 HR; T-0 HR), CAJ1044 (F-2, 3, 4 HR; T-0 HR), CAJ1058 (F-3 HR; T-3 HR), CAJ1063 (F-3 HR; T-0.5 HR), CAJ1112 (F-2 HR; T-0 HR), CAJ1175 (F-2 HR; T-0 HR), CAJ5001 (F-1.5, 2, 3 HR; T-0, 0.5, 0.75, 1 HR), CAJ5002 (F-2, 3 HR; T-0, 0.5, 1 HR), CAJ5003 (F-2 HR; T-0.5, 1 HR), CAJ5024 (F-2, 3 HR; T-1, 1.5 HR), CAJ5060 (F-2, 3 HR; T-0, 0.75, 1, 1.5 HR), CBJ1020 (F-4 HR; T-0, 0.75, 1.5 HR)
CONCRETE OR MASONRY WALLS	CAJ1001 (F-3 HR; T-0 HR), CAJ1017 (F-2, 3 HR; T-0 HR), CAJ1021 (F-3 HR; T-0, 1.5 HR), CAJ1027 (F-3 HR; T-0 HR), CAJ1044 (F-2, 3, 4 HR; T-0 HR), CAJ1058 (F-3 HR; T-0 HR), CAJ1063 (F-3 HR; T-0.5 HR), CAJ1112 (F-2 HR; T-0 HR), CAJ1175 (F-2 HR; T-0 HR), CAJ5001 (F-1.5, 2, 3 HR; T-0, 0.5, 0.75, 1 HR), CAJ5002 (F-2, 3 HR; T-0, 0.5, 1 HR), CAJ5003 (F-2 HR; T-0.5, 1 HR), CAJ5024 (F-2, 3 HR; T-1, 1.5 HR), CAJ5060 (F-2, 3 HR; T-0, 0.75, 1, 1.5 HR), CBJ1020 (F-4 HR; T-0, 0.75, 1.5 HR)
GYPSUM WALLBOARD/ STUD WALLS	WL1001 (F-1, 2, 3, 4 HR; T-0, 1, 2, 3, 4 HR), WL1002 (F-1, 2 HR; T-0 HR), WL1003 (F-1, 2 HR; T-0 HR), WL2002 (F-1, 1.5, 2 HR, T-0.75, 1, 1.5, 2 HR), WL2003 (F-1, 2 HR; T-1, 2 HR), WL2004 (F-2 HR; T-0.75, 1.5, 2 HR), WL2005 (F-1, 2 HR; T-0, 0.75, 1, 1.5, 2 HR), WL5001 (F-1, 2 HR; T-1, 1.5 HR), WL5002 (F-1, 2 HR; T-1, 2 HR)


## PIPE PENETRATION 7 THRU FIRE RATED BARRIER DETAIL

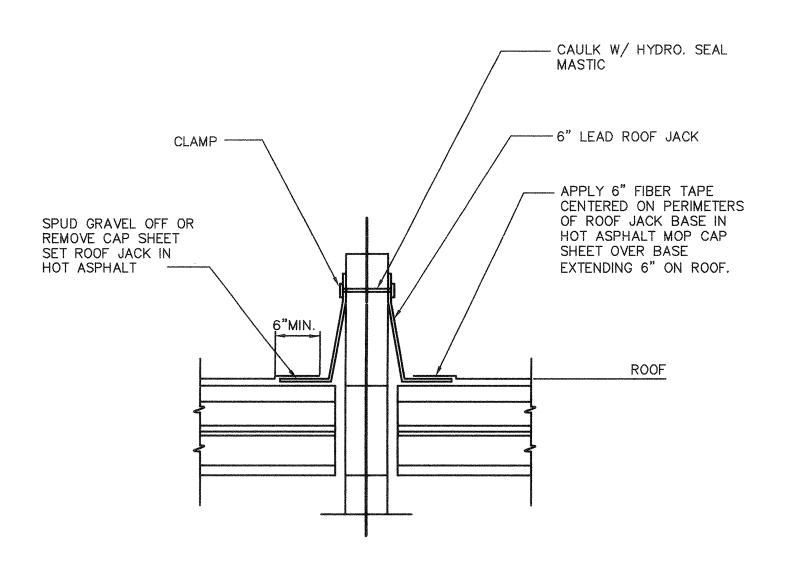

8 TYPICAL PIPE/VENT THRU ROOF DETAIL
NO SCALE

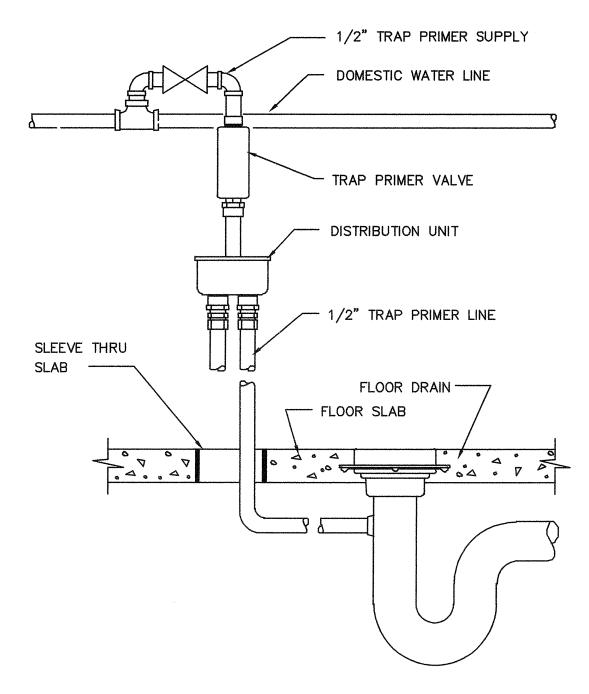


4 TRAP SEAL PRIMER DETAIL

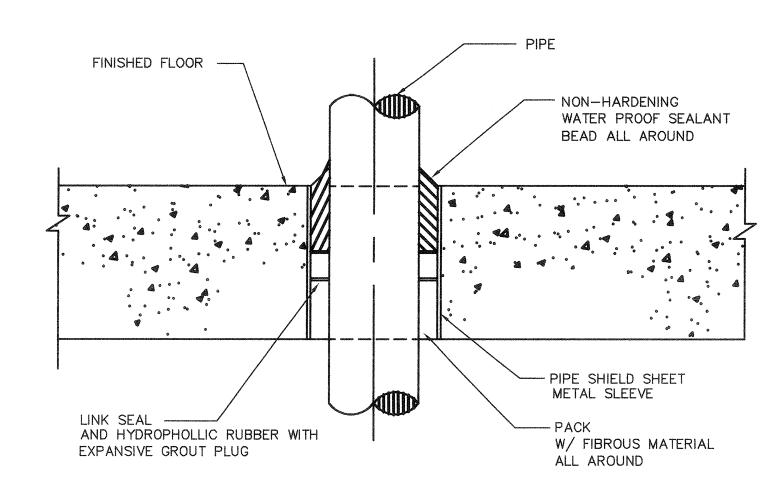


TYPICAL PIPE PENETRATION


5 THRU FLOOR SLAB ON GRADE DETAIL

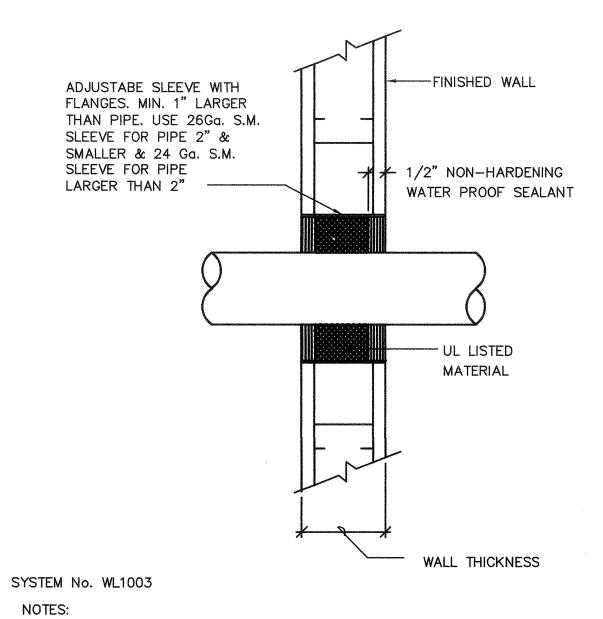


- STEEL SLEEVE CYLINDRICAL SLEEVE FABRICATED FROM MIN 0.019" THICK (No28 GAUGE) GALV SHEET STEEL AND HAVING A MIN. 2" LAP ALONG THE LONGTITUDIAL SEAM. LENGHT OF STEEL SLEEVE TO BE EQUAL TO THICKNESS OF WALL PLUS 1" TO 4" SUCH THAT, WHEN INSTALLED, THE ENDS OF THE SLEEVE WILL PROJECT APPROX 1/2" TO 2" BEYOND THE SURFACE OF THE WALL ON BOTH SIDES OF THE WALL
- PACKING MATERIAL MIN 1" THICKNESS OF MINERAL—WOOL BATT INSULATION FIRMLY PACKED INTO STEEL SLEEVE ON BOTH SIDES OF THE WALL ASSEMBLY AS PERMANENT FORMS. PACKING MATERIAL TO BE RECESSED MIN. 1/2" FROM END OF STEEL SLEEVE (FLUSH WITH OR RECESSED INTO GYPSUM WALLBOARD SURFACE) ON BOTH SIDES OF WALL ASSEMBLY.

6 TYPICAL WALL PENETRATION DETAIL (BARE PIPE)
NO SCALE

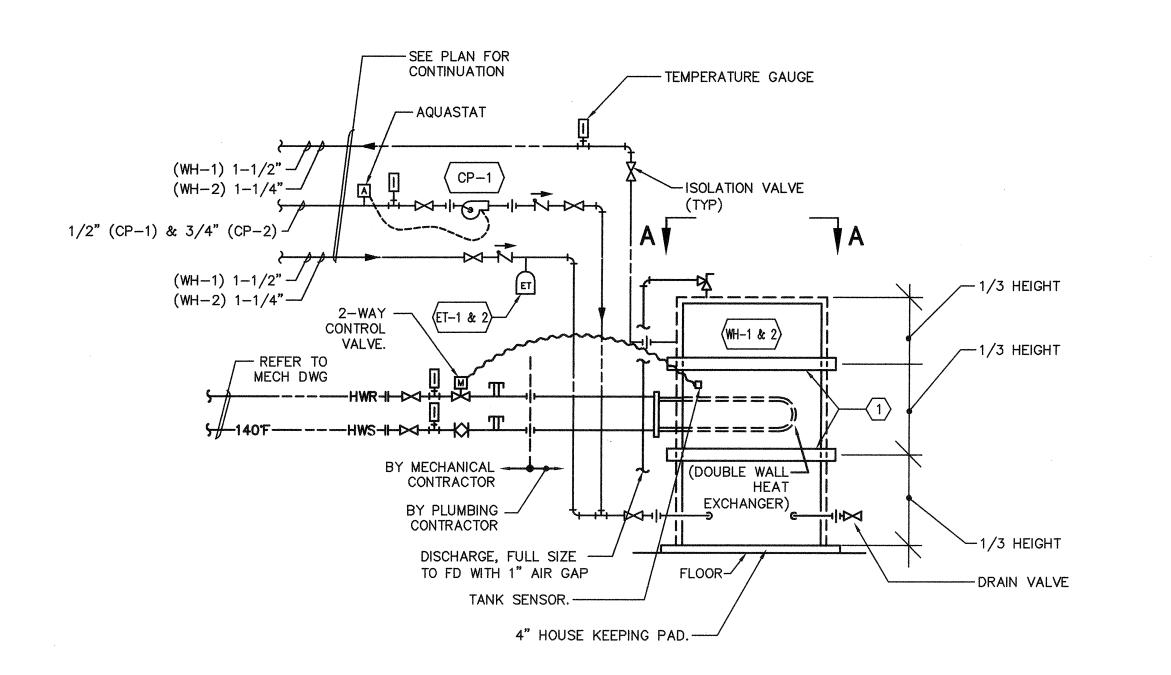

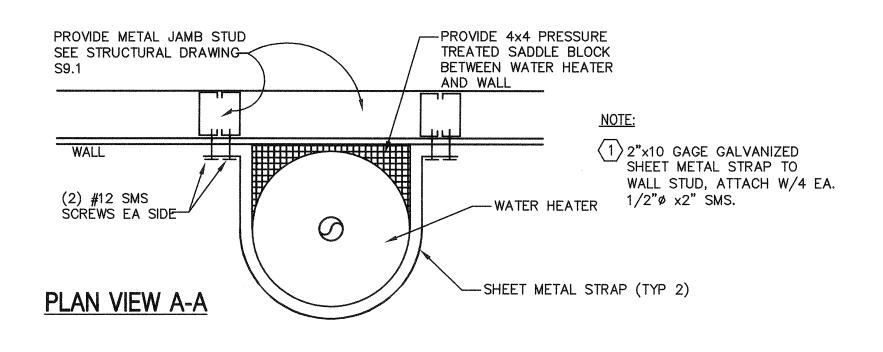


1 WATER HEATER DETAIL
NO SCALE

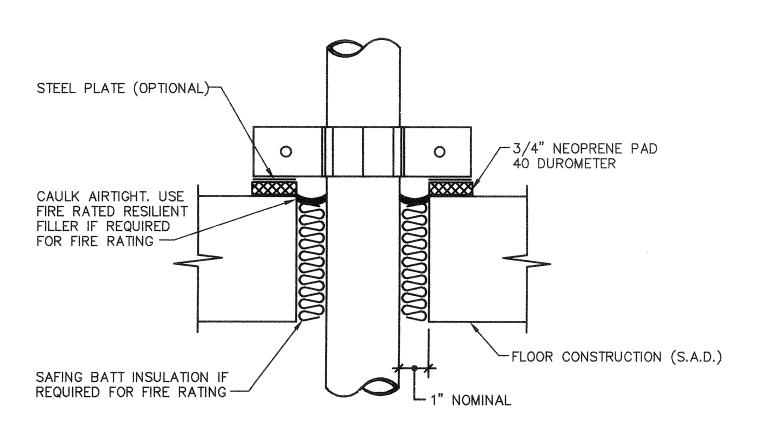

NOTE: IF PIPE IS SUSPENDED FROM OR DIRECTLY ATTACHED TO STRUCTURE OR OTHER BUILDING ELEMENTS, USE 1/2" THICK, 40-DUROMETER NEOPRENE AS SLEEVE BETWEEN PIPE AND PIPE COLLAR. MAXIMUM WEIGHT OF 400LBS.

### 2 PIPE ISOLATION AT FLOOR PENETRATION NO SCALE

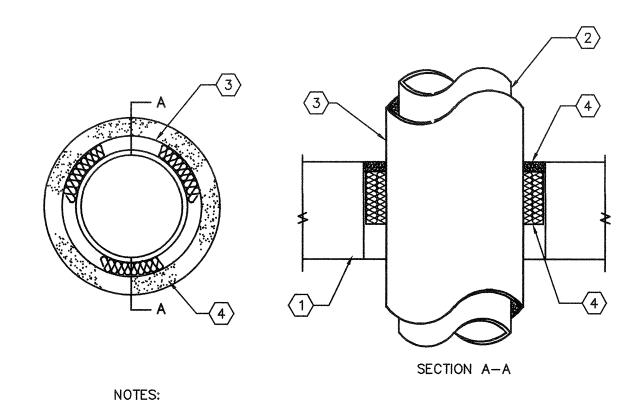


- ~
- 1 FLOOR ASSEMBLY.
- 2 PIPE.
   3 FIRESTOP SYSTEM PER ASTME814/UL1479.
   4 PENETRATION OPENING PER ANNULAR SPACE REQUIREMENTS FOR SELECTED SYSTEM.

TYPICAL PIPE 3 PENETRATION THRU FLOOR DETAIL



architecture planning interiors

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#### BUILDINGS 5 & 6 RENOVATIONS

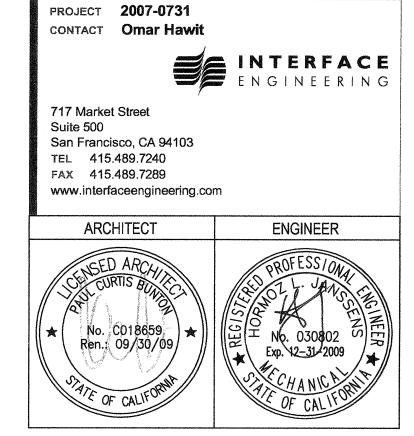San Mateo County Community College District


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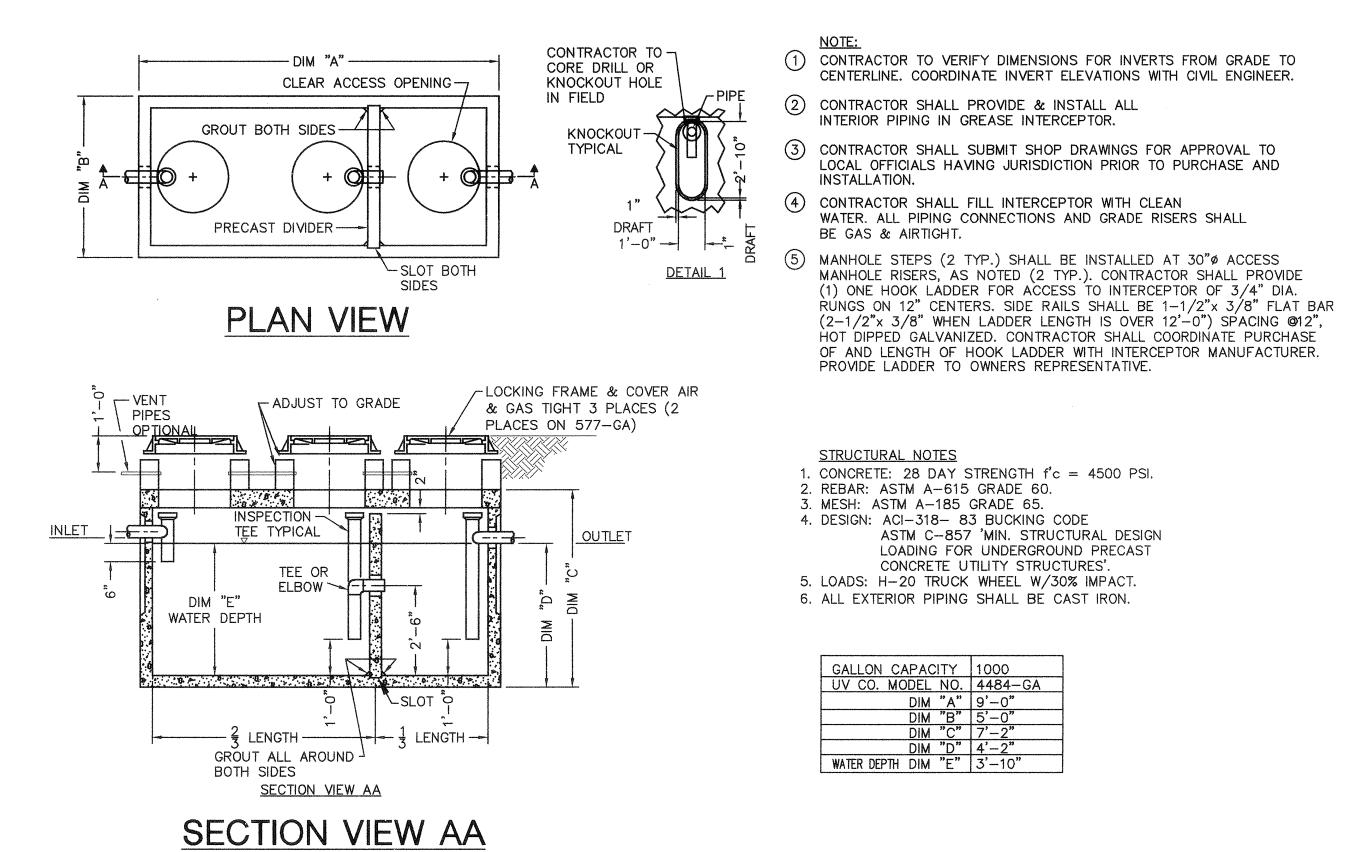
PLUMBING DETAILS

07013

Date 01/22/09	Drawing Number
Scale AS NOTED	P6.1
Project Number	



# TYPICAL PIPE WALL 1 PENETRATION DETAIL (INSULATED PIPE)

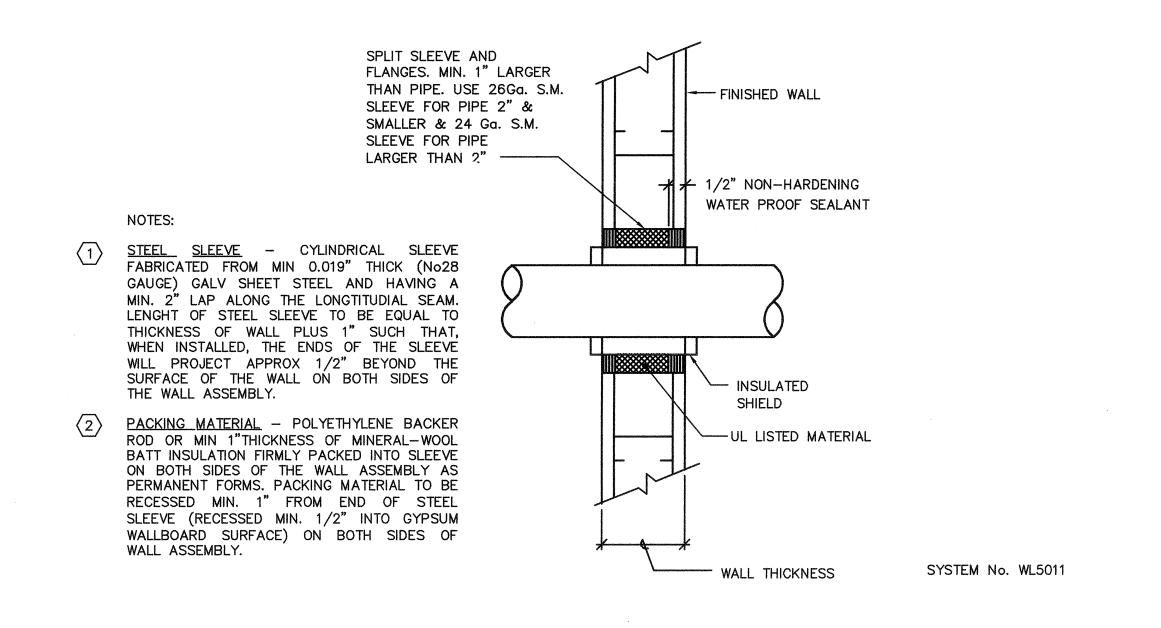

2 GREASE INTERCEPTOR (GI-1)
NO SCALE



architecture p la n n i n g i n t e r i o r s

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#### BUILDINGS 5 & 6 RENOVATIONS

San Mateo County Community
College District

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Date 01/22/09	Drawing Number
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