


LOADCENTERS 1 AND 2


DIMENSIONS SHOWN ARE APPROXIMATE, USE SHOP DRAWINGS FOR CONSTRUCTION

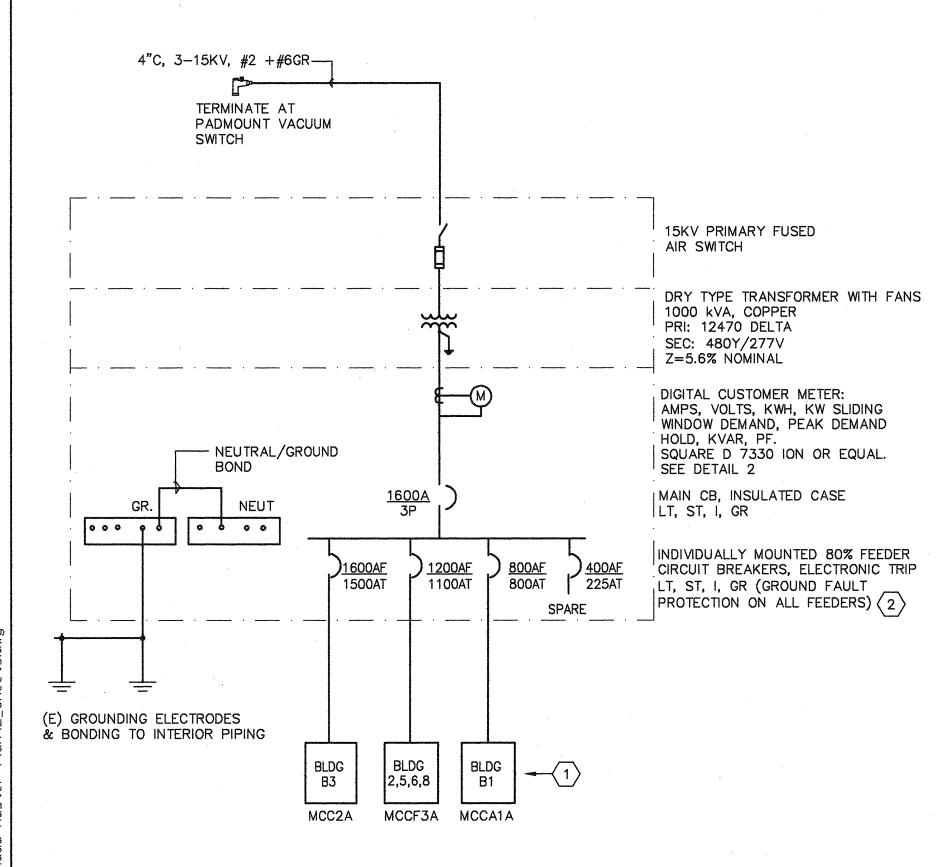

4 LOADCENTER 1, 1-LINE DIAGRAM


LOADCENTER REPLACEMENT GENERAL NOTES

- 1. INFORMATION SHOWN FOR (E) LOADCENTERS IS BASED ON AVAILABLE RECORDS THAT MAY NOT BE ACCURATE. VÉRIFY SETTINGS, RATINGS, AND CONDUCTOR SIZES IN FIELD. NOTIFY PROJECT MANAGER IF CONNECTIONS OR CIRCUITS ARE DISCOVERED THAT ARE NOT SHOWN ON THE DRAWINGS.
- 2. EXTEND (E) CONDUCTORS TO REACH (N) FEEDER CIRCUIT BREAKERS WITH COMPRESSION SLEEVES INSULATED WITH HEATSHRINK OR COLD SHRINK TUBING. EXTEND (E) ALUMINUM CONDUCTORS WITH COPPER CONDUCTORS USING APPROVED AL/CU SLEEVES. USE ANTI-OXIDE COMPOUND ON ALUMINUM CONDUCTORS ACCORDING TO MANUFACTURER'S INSTRUCTIONS.
- 3. TEST ALL (N) CIRCUIT BREAKERS AT THE SETTINGS PROVIDED BY THE ENGINEER. GROUND FÀULT TRIP TESTING INCLUDED MAIN AND FEEDERS.

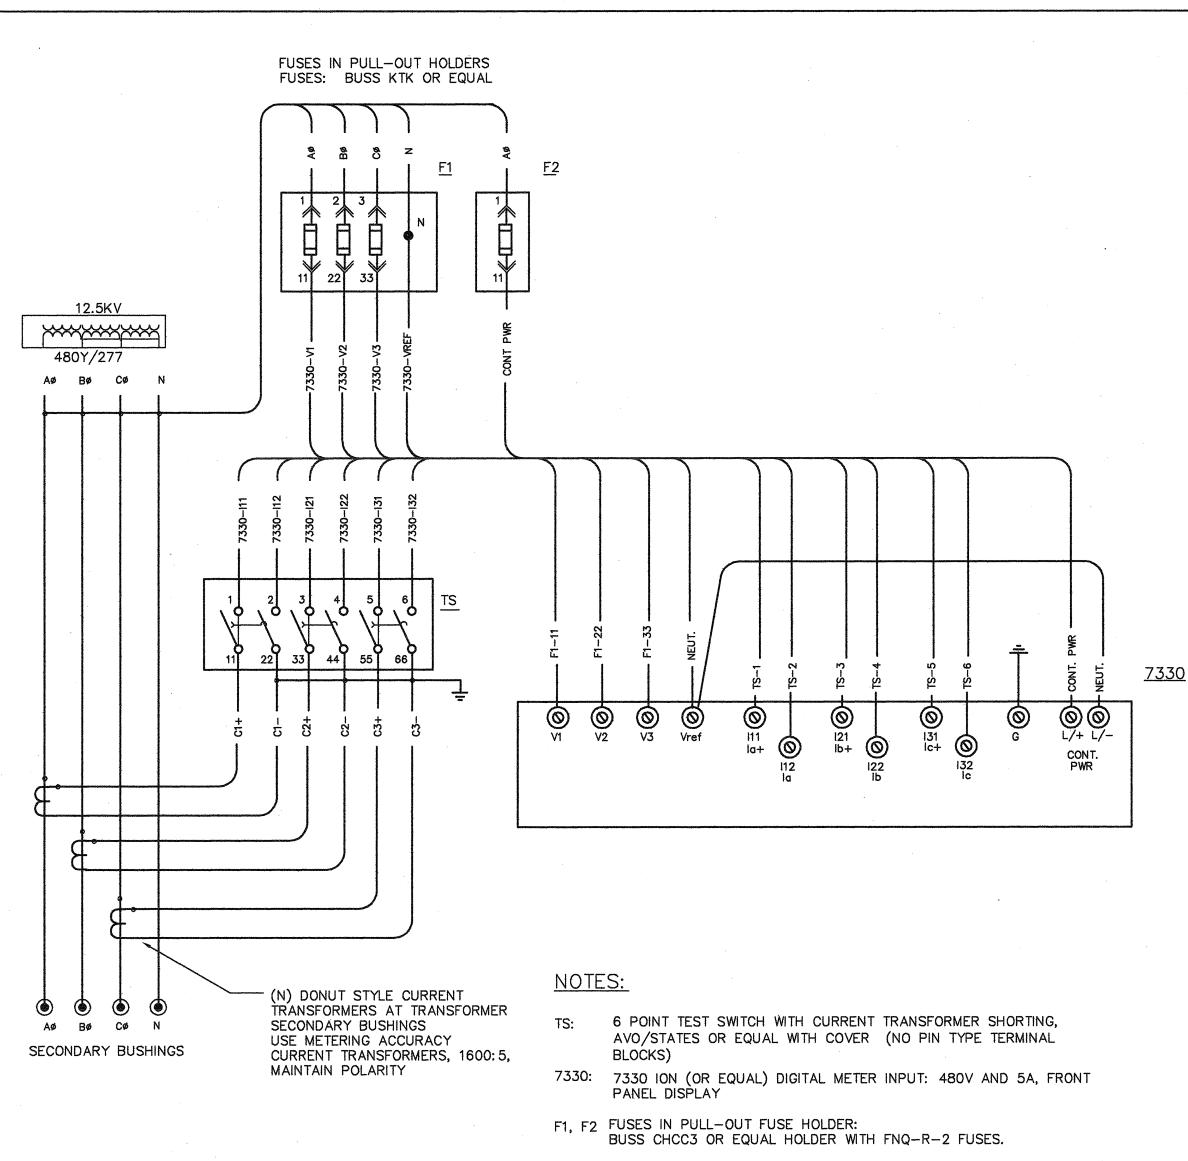


USE #14 COPPER, TYPE SIS SWITCHBOARD WIRE TERMINATED WITH CRIMP TYPE RING TERMINALS

METER WIRING

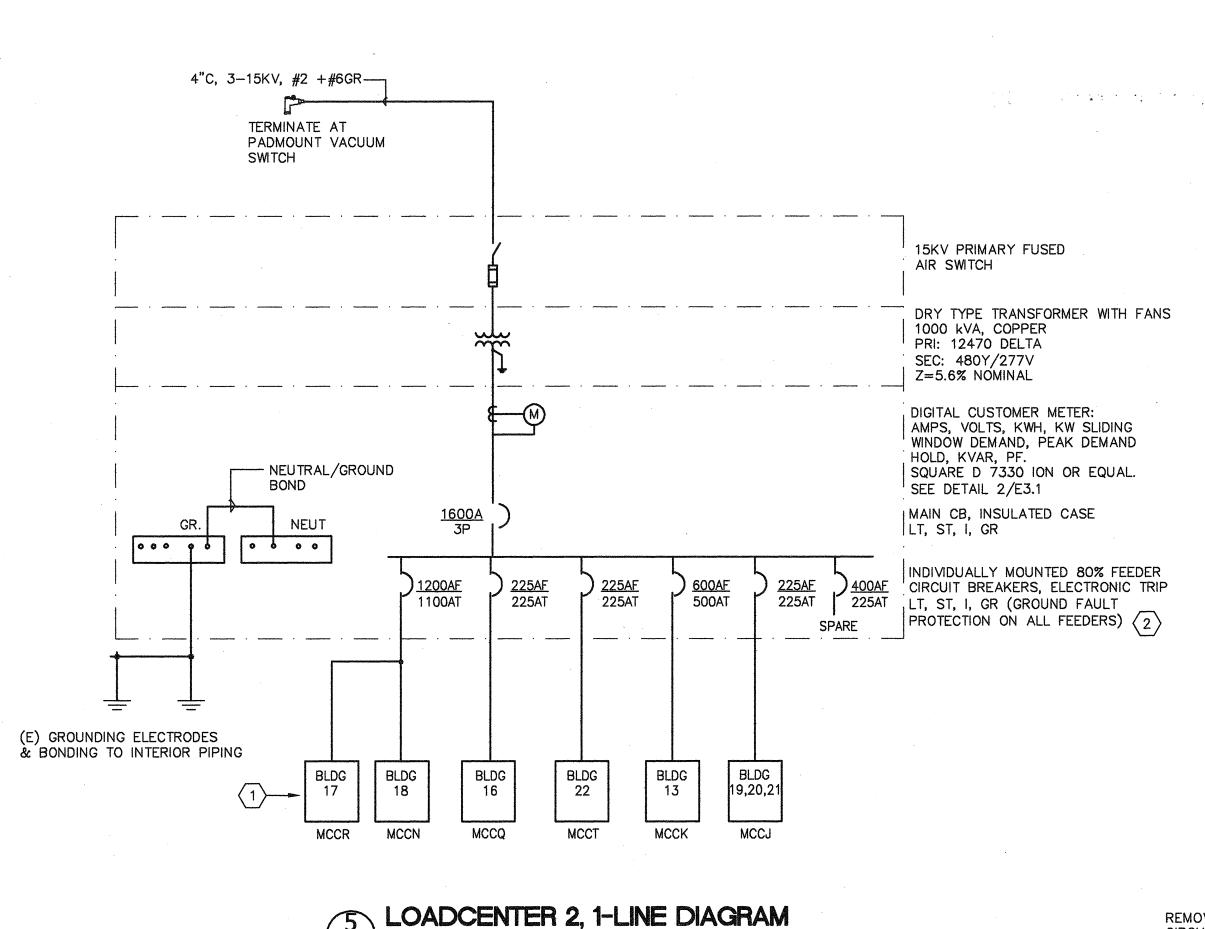


LOADCENTER REPLACEMENT SHEET NOTES


- (TYP FOR MOTOR CONTROL CENTERS AND PANELBOARDS FED FROM LOADCENTERS) VERIFY AT EACH FEEDER THAT THERE ARE NO NEUTRAL TO GROUND BONDING JUMPERS OR OTHER NEUTRAL TO GROUND CONNECTIONS AT THE FAR END. REMOVE ANY THAT ARE FOUND. VERIFY THAT ANY GROUNDING ELECTRODE CONDUCTORS ARE CONNECTED TO THE GROUND BUS ONLY.
- ALL FEEDERS ARE SHOWN IN RECORDS AS 480Y/277V. PROVIDE NEUTRAL CONDUCTOR CURRENT SENSOR FOR EACH FEEDER CIRCUIT BREAKER.

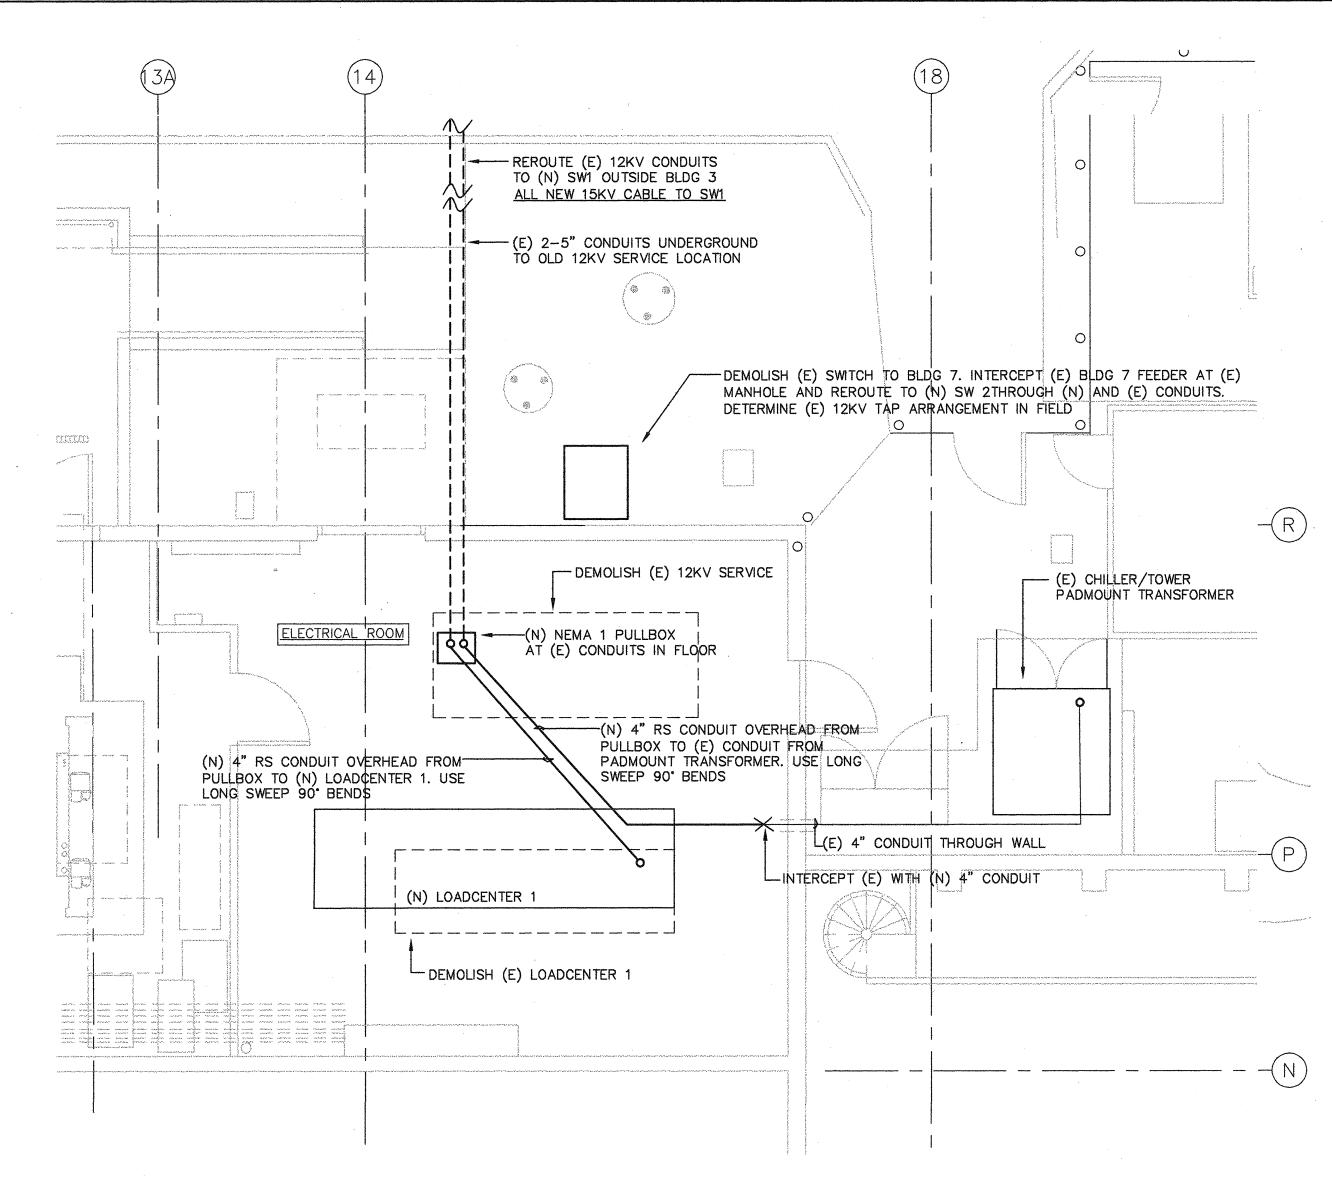

3 BUILDING 3 ELECTRICAL PLAN

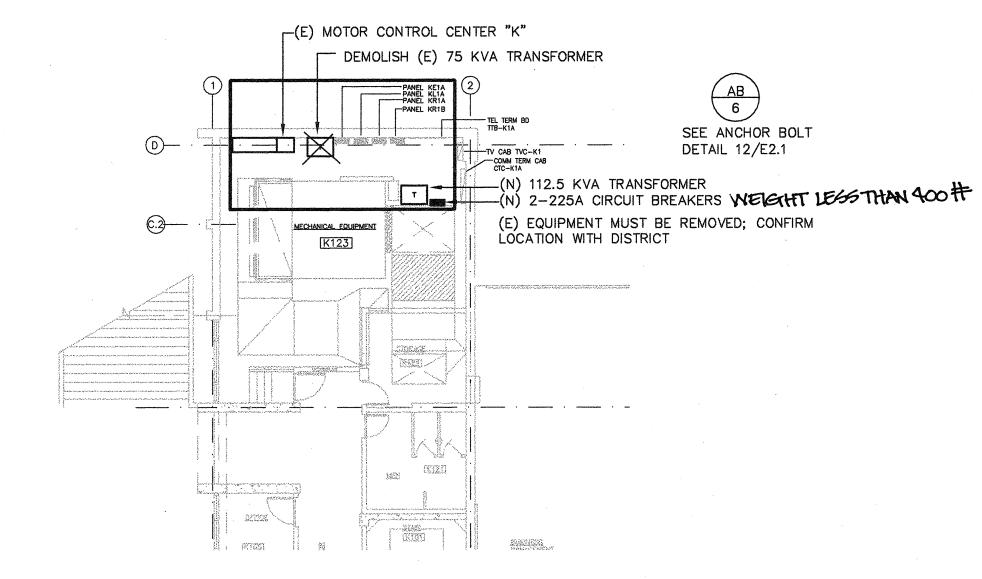


LOCATION PLAN, BLDG. 13

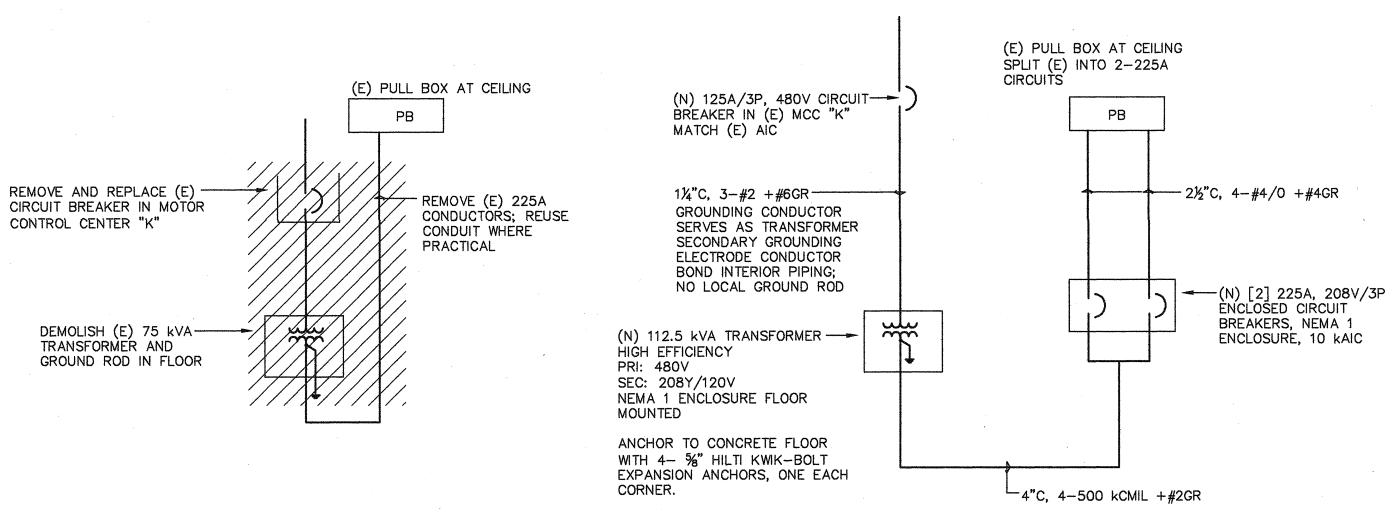

DEMOLITION

NEW CONSTRUCTION



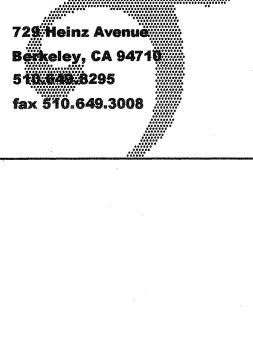



JEFF SULTAN, P.E. ELECTRICAL ENGINEER 2081 Camino de los Robles Menlo Park, CA 94025 (650) 854-7585 jeff@jmspower.net

IDENTIFICATION STAMP DIVISION OF THE STATE ARCHITECT APPLICATION NUMBER 01-111618

CALIFORNIA STATE FIRE MARSHAL APPROVED APPROVAL OF THIS PLAN DOES NOT AUTHORIZE OR APPROVE ANY OMISSION OR DEVIATION FROM APPLICABLE REGULATIONS. FINAL APPROVAL IS SUBJECT TO FIELD INSPECTION. ONE SET OF APPROVI PLANS SHALL BE AVAILABLE ON THE PROJECT SITE AT ALL TIMES.

CAÑADA **COLLEGE**

Electrical Infrastructure Replacement Project

4200 Farm Hill Blvd Redwood City, CA 94061

BID SET

SHEET TITLE ELECTRICAL DETAILS

REVISIONS NO. DATE DESCRIPTION

DATE January 14, 2011 DRAWN JS CHECKED MM SCALE AS NOTED JOB NO. 2921.01

SHEET NUMBER

E3.1