WRNSSTUDIO AUDIOVISUAL TITLE SHEET **501 SECOND STREE** 4TH FLOOR, STE. 402 DRAWING INDEX AUDIOVISUAL GENERAL NOTES SAN FRANCISCO APPLIES TO ALL SHEETS **CALIFORNIA 94107** 415.489.2224 TEL ISSUE LOG 415.358.9100 FAX WWW.WRNSSTUDIO.COM PROJECT OVERALL: CEILING BOX 1. THE PURPOSE OF THIS SHEET IS TO ILLUSTRATE AND DEFINE TYPICAL GRAPHIC SYMBOLS, AND SYSTEMS OF GRAPHIC SYMBOLS, FLOOR BOX WHICH MAY OCCUR ON THE AUDIOVISUAL DRAWINGS. THE ILLUSTRATION OF A SYMBOL, OR SYSTEM OF SYMBOLS, ON THIS SHEET DOES NOT NECESSARILY INDICATE THAT THE BUILDING ITEM OF THE DESCRIBED SYSTEM BY THE SYMBOL IS USED AS SHEET SHEET PART OF THIS PROJECT. REFER TO THE PLANS, ELEVATIONS, SECTIONS, SCHEDULES, DETAILS, AND SPECIFICATIONS TO NUMBER TITLE Steinberg Architects POKE-THRU DETERMINE THE SCOPE OF THE WORK. BACKCAN FOR CEILING MOUNTED LOUDSPEAKER 2. THE WORK - INCLUDING MATERIALS, METHODS, ASSEMBLIES, ETC - MUST COMPLY WITH THE MINIMUM REQUIREMENTS OF THE TA-001 | AUDIOVISIUAL SYMBOLS LIST AND DRAWING INDEX X | X | X | X | X | X | X | - | GOVERNING LAWS, ORDINANCES, AND REGULATIONS OF ALL FEDERAL, STATE, DISTRICT, AND LOCAL AUTHORITIES HAVING - | - | x | x | x | x | x TA-002 BACKBOX SCHEDULE AND NOTES JURISDICTION OVER THE PROJECT, AS WELL AS THOSE GREATER REQUIREMENTS INDICATED BY THE CONTRACT DOCUMENTS. NO PART OF THE CONTRACT DOCUMENTS MAY BE CONSTRUED TO REQUIRE OR PERMIT WORK CONTRARY TO A GOVERNING LAW, ORDINANCE, OR REGULATION. TA-011 AUDIOVISUAL RISER DIAGRAMS CEILING MOUUNTED PROJECTION SCREEN 3. THE AUDIOVISUAL DRAWINGS ARE PART OF A LARGER SET OF DRAWINGS WHICH, WHEN COMPLETE, CONSISTS OF DRAWINGS TA-101 LEVEL 1 AUDIOVISUAL OVERALL FLOOR PLAN LISTED BY THE "INDEX OF DRAWINGS". THE WORK DESCRIBED BY THE DRAWINGS OF ANY ONE DISCIPLINE MAY BE AFFECTED CONDUIT STUB ABOVE CEILING BY THE WORK AND REQUIREMENTS DESCRIBED ON DRAWINGS OF ANOTHER DISCIPLINE AND MAY REQUIRE REFERENCE TO THE TA-102 LEVEL 2 AUDIOVISUAL OVERALL FLOOR PLAN DRAWINGS OF ANOTHER DISCIPLINE. PARTIAL SETS OF DRAWINGS ARE INCOMPLETE AND SHOULD NOT BE DISTRIBUTED OR TA-103 LEVEL 3 AUDIOVISUAL OVERALL FLOOR PLAN UTILIZED BY THE CONTRACTOR. MANAGE, SUPERVISE, REVIEW, AND COORDINATE THE WORK OF SUB-CONTRACTORS, TRADES, |-|-|-|X NOTE: SEE BACKBOX SCHEDULE FOR DEVICE TYPE AND SIZE. AND SUPPLIERS WITH THE REQUIREMENTS OF THE CONTRACT DOCUMENTS BEFORE COMMENCING CONSTRUCTION AND TO TA-103A LEVEL 3 AUDIOVISUAL OVERALL FLOOR PLAN ASSURE THAT PARTIES ARE AWARE OF REQUIREMENTS, REGARDLESS OF WHERE THE REQUIREMENTS OCCUR IN THE CONTRACT DOCUMENTS, WHICH MIGHT AFFECT THE WORK OF THAT PARTY. TA-201 LEVEL 1 AUDIOVISUAL OVERALL R C P EVENT ANNUNCIATION SYSTEM LOUDSPEAKER, CEILING MOUNTED. TA-202 | LEVEL 2 AUDIOVISUAL OVERALL R C P 4. THE ARCHITECTURAL DRAWINGS ESTABLISH AND COORDINATE THE FINISHED APPEARANCE AND EXACT LOCATION OF EXPOSED -|x|x|x|x|x|-ELEMENTS OF THE WORK OF TRADES, INCLUDING THAT WORK THAT IS ILLUSTRATED PRIMARILY ON THESE DRAWINGS. TA-203 LEVEL 3 AUDIOVISUAL OVERALL R C P - | x | x | x | x | x | x LOCATIONS SHOWN ON THESE DRAWINGS ARE DIAGRAMMATIC, UNLESS OTHERWISE NOTED ON THE ARCHITECTURAL DRAWINGS. EVENT ANNUNCIATION SYSTEM LOUDSPEAKER, WALL MOUNTED. 5. MAINTAIN A COPY OF THE SPECIFICATIONS AND DRAWINGS AT THE JOB SITE. PRESENT THE SPECIFICATIONS AND DRAWINGS TA-401 SECTIONS AND ELEVATIONS -|-|x|x|x|x| UPON REQUEST. MAINTAIN DAILY MARKUPS OF ACTUAL INSTALLATION AND PRESENT FOR REVIEW UPON REQUEST. NOTE: DAISY-CHAIN SIGNAL CABLE BACK TO IDF ROOM. TA-501 AUDIOVISUAL DETAILS 6. REFER TO WRITTEN SPECIFICATIONS FOR PROJECT SCOPE, GENERAL REQUIREMENTS, PRODUCT SPECIFICATIONS, AND INSTALLATION REQUIREMENTS. TA-502 AUDIOVISUAL DETAILS |-|-|-|x|-510-337-2804 FAX 7. PROVIDE NECESSARY EQUIPMENT AND ACCESSORIES FOR A FULLY FUNCTIONAL SYSTEM THAT MEETS INTENDED DESIGN WHETHER www.teecom.com EXPRESSLY SPECIFIED OR NOT. ISSUES/REVISIONS 8. PROVIDE MATERIALS AND EQUIPMENT LISTED BY UNDERWRITERS LABORATORIES FOR THE PURPOSE USED AND BEARING THEIR 100% SCHEMATIC DESIGN SUBMITTAL 04/28/08 50% DESIGN DEVELOPMENT SUBMITTAL 06/13/08 9. PRIOR TO PERFORMING WORK, IMMEDIATELY NOTIFY THE OWNER, OR OWNER'S REPRESENTATIVE, IN WRITING OF OBSERVATIONS OR CONDITIONS THAT ARE DISCOVERED THAT WOULD PREVENT INSTALLATION ACCORDING TO DRAWINGS AND SPECIFICATIONS. 100% DESIGN DEVELOPMENT SUBMITTAL 07/28/08 DSA INCREMENT #1: 10. BRING A SET OF MARKED UP PLANS TO WEEKLY CONSTRUCTION MEETINGS FOR OWNER'S, OR OWNER'S REPRESENTATIVE'S, SITE DEMOLITION, EXCAVATION, APPROVAL PRIOR TO PRODUCTION OF AS-BUILT DRAWINGS FOR RECORD DOCUMENTATION. ROUGH GRADING & UTILITIES 11. REMOVE ABANDONED CABLING AND LEFT OVER CONDUIT, WIRE, SCRAPS, ETC. AND LEAVE PREMISES CLEAN AND FREE OF INCREMENT 2 80% REVIEW 10/10/08 TRASH OR DEBRIS RESULTING FROM WORK. DSA INCREMENT #2: 11/11/08 STRUCTURE & GFRC PANELS **AUDIOVISUAL PATHWAYS:** 11/11/08 DSA INCREMENT #3 50% REVIEW 12. INSTALL EQUIPMENT, DEVICES, AND PATHWAYS, SUCH AS CABLE TRAY, RUNWAY, CONDUITS, CABLE HANGERS, AND PULLBOXES, DSA INCREMENT #1: BACK CHECK ETC., ACCORDING TO STATE AND LOCAL CODES FOR SEISMIC BRACING. DSA INCREMENT #3: 90% REVIEW 13. CONDUIT ROUTING, WHERE SHOWN ON DRAWINGS, IS DIAGRAMMATIC IN NATURE. FIELD DETERMINE CONDUIT ROUTES TO SUIT FIELD CONDITIONS WHILE CONFORMING TO SPECIFICATIONS. PREPARE SHOP DRAWINGS SHOWING EXACT CONDUIT ROUTES, DSA INCREMENT #3: INDICATING PENETRATION TYPES (e.g., FRAMED WALL, CONCRETE WALL, ETC.). COORDINATE REQUIREMENTS OF OTHER TRADES. FENANT IMPROVEMENT & ROOFING SYSTEM 14. CONFORM TO CONDUIT INSTALLATION INSTRUCTIONS OF TIA/EIA-568 AND BICSI TDMM. DSA INCREMENT #2: BACKCHECK 15. ROUTE CONDUIT, CABLE TRAYS, AND OTHER PATHWAYS PERPENDICULAR OR PARALLEL TO BUILDING LINES. DSA INCREMENT #3: BACKCHECK 05/12/09 PROJECT RECORD SET 01/31/11 16. CONDUITS WITH LESS THEN 2" INSIDE DIAMETER WILL HAVE A 90-DEGREE BEND RADIUS OF NO LESS THAN 6 TIMES THE INSIDE DIAMETER. CONDUITS WITH A 2" OR GREATER INSIDE DIAMETER WILL HAVE A 90-DEGREE BEND RADIUS OF NO LESS THAN 10 TIMES THE INSIDE DIAMETER. 17. CONDUIT RUNS SHALL NOT EXCEED 180 DEGREES OR TWO 90-DEGREE BENDS WITHOUT AN APPROPRIATE NEMA RATED PULL BOX OR/AND INCREASE CONDUIT BY ONE TRADE SIZE FOR EACH ADDITIONAL BEND, UNLESS LAST BEND IS WITHIN 12 INCHES OF THE CONDUIT END. 18. WHEN ROUTING CONDUIT IN CONCRETE, MAINTAIN A GRADUATED BEND RADIUS TO MAINTAIN CONDUIT CAPACITY. THE USE OF 90-DEGREE 'ELBOW' FITTINGS IS EXPRESSLY PROHIBITED UNLESS PRIOR AUTHORIZATION IS RECEIVED FROM OWNER, OR OWNER'S REPRESENTATIVE, IN WRITING. 19. PROPERLY FIRE SEAL CONDUIT AND RACEWAY PENETRATIONS THROUGH FIRE RATED WALLS AND FLOORS TO MAINTAIN THE FIRE SEPARATION RATING. PROVIDE FIRE SEALING ASSEMBLIES THAT ARE UL LISTED FOR THE APPLICATION. COORDINATE PROJECT REQUIREMENTS WITH LOCAL FIRE MARSHALL PRIOR TO INSTALLATION. 20. PROVIDE EXPANSION/DEFLECTION FITTINGS FOR CONDUITS AT STRUCTURAL EXPANSION JOINT CROSSINGS. RECORD SET CONVENTIONS 21. PROVIDE PLASTIC BUSHINGS ON EXPOSED ENDS OF CONDUIT AND SLEEVES, WHETHER VISIBLE OR NOT. 22. PROVIDE EMT 4" TRADE SIZE CONDUITS FOR BACKBONE PATHWAYS WITH 40" MINIMUM BEND RADIUS FITTINGS, UON. 23. PROVIDE MINIMUM OF 1-1/4 INCH SIZE CONDUIT FOR HORIZONTAL DISTRIBUTION AND AUDIOVISUAL DEVICES. ELECTRICAL SHEET NOTE 24. PROVIDE DEDICATED CONDUIT STUB PER AUDIOVISUAL DEVICE BOX. DAISY-CHAINING DEVICE BOXES IS PROHIBITED. GENERAL CONTRACTOR SHEET NOTE 25. CONDULET ("LB", ETC.) FITTINGS ARE EXPRESSLY PROHIBITED FOR BACKBONE AND HORIZONTAL SYSTEM PATHWAYS. MECHANICAL CONTRACTOR SHEET NOTE 26. PROVIDE A PULL STRING IN EMPTY/UNUSED HORIZONTAL DISTRIBUTION CONDUITS AND CONDUITS SERVING AUDIOVISUAL DEVICES S-1 SECURITY SHEET NOTE SUITABLE FOR A 200 LB PULL TENSION MINIMUM. T-1 TELECOM SHEET NOTE 27. PROVIDE DEDICATED SUPPORTS (e.g., CLIPS & WIRES) FOR CABLE SUPPORT HANGERS (OR SIMILAR PATHWAY COMPONENTS) INTENDED FOR AUDIOVISUAL CABLES. DO NOT SHARE SUPPORTS WITH OTHER TRADES/SYSTEMS. AUDIOVISUAL SHEET NOTE $\langle 1 \rangle$ CONDUIT IDENTIFICATION TAG. ISSUE LOG KEY: AUDIOVISUAL CABLING & DEVICES: NUMBERED SHEET NOTE (APPLIES TO DRAWING CONTAINING NOTES ONLY). ' X ' ISSUED AS PART OF A SET 28. DO NOT TIE CABLES TO OTHER STRUCTURES NOT INTENDED FOR THIS SPECIFIC USE. DO NOT TIE CABLES TO CABLE TRAY. EQUIPMENT IDENTIFICATION TAG. ' - ' NOT A PART OF ISSUED SET 29. ROUTE AUDIOVISUAL CABLES PERPENDICULAR OR PARALLEL TO BUILDING LINES. ROUTE AUDIOVISUAL CABLES NO LESS THAN (001) DOOR NUMBER 12 INCHES FROM ANY POWER SOURCE OR FLORESCENT LIGHTING FIXTURE, AND NO LESS THAN 4 FEET FROM ANY TRANSFORMER OR MOTOR. TELECOMMUNICATION CONDUIT BANK TAG. REFER TO SCHEDULE. ABBREVIATIONS 30. PROVIDE AUDIOVISUAL CONDUITS FOR CABLING ROUTED THROUGH NON-ACCESSIBLE CEILING SPACE (e.g., 'HARD LID' CEILING), UON. SIZE CONDUITS TO MAINTAIN A FILL CAPACITY NO LESS THAN 40% PLUS 50% SPARE CAPACITY. 31. INSTALL AUDIOVISUAL DEVICES AT HEIGHTS NOTED ON SYMBOLS LIST AND DEVICE SCHEDULE, UNLESS OTHERWISE SHOWN ON DETAIL REFERENCE THE DRAWINGS STATED IN SPECIFICATIONS. MOUNTING HEIGHTS ARE FROM FINISHED FLOOR TO THE CENTERLINE OF THE TA0.00 AFF ABOVE FINISHED FLOOR MSW MULTI-MEDIA SWITCHER DEVICE. REFER TO ARCHITECTURAL ELEVATION DRAWINGS FOR ADDITIONAL INFORMATION OR EXACT LOCATIONS OF WALL/CEILING/FLOOR MOUNTED DEVICES. AFT AM/FM TUNER MTX MATRIX SWITCHER —— SHEET NUMBER (TA=AUDIOVISUAL) — DETAIL DESIGNATION AMP AUDIO AMPLIFIER NET NETWORK WIRELESS ACCESS POINT 32. PROVIDE A 24" MINIMUM SEPARATION BETWEEN 'BACK-TO-BACK' TELECOMMUNICATION POWER OR SIGNAL DEVICES IN FRAMED ANT ANTENNA NIC NOT IN CONTRACT ELEVATION REFERENCE APB AUDIO PATCH BAY NTS NOT TO SCALE 33. GROUP AND DRESS EXPOSED AUDIOVISUAL CABLE GROUPS USING VELCRO TIES, UON. ATC AUDIO CONFERENCE UNIT OFE OWNER FURNISHED EQUIPMENT — SHEET NUMBER (TA=AUDIOVISUAL) AVC AUDIOVISUAL CONTRACTOR OFOI OWNER FURNISHED OWNER INSTALLED —— DETAIL DESIGNATION SKYLINE COLLEGE AVS AUDIO/VIDEO SWITCHER OPJ OVERHEAD PROJECTOR SECTION REFERENCE BFC BELOW FINISHED CEILING PJS PROJECTION SCREEN CIP2 DESIGN-BUILD CAS CASSETTE DECK PSU POWER SUPPLY — SHEET NUMBER (TA=AUDIOVISUAL) **BUILDING 4N** CCD CLOSED CAPTIONING DECODER RGB HI-RES COMPUTER SIGNAL — DETAIL DESIGNATION CCP CD/CASSETTE PLAYER SCN SCAN CONVERTER CDP COMPACT DISC PLAYER SCR SCALER MATCHLINE REFERENCE CPU CENTRAL PROCESSING UNIT SPJ SLIDE PROJECTOR — CURRENT SHEET —— CONTINUING SHEET CSI CONTROL SYSTEM INTERFACE SPK LOUDSPEAKER CSP CONTROL SYSTEM PROCESSOR SRP SURROUND PROCESSOR SRT SATELLITE RECEIVER TUNER CSS CONTROL SYSTEM SENSOR SW SWITCHER CTLB CONTROL SYSTEM BUSS STRIP TBK TERMINATION BLOCK CTLR CONTROLLER DA DISTRIBUTION AMPLIFIER TBD TO BE DETERMINED DOC VIDEO DOCUMENT CAMERA TDS TREND DATA SERVER TP CONTROL TOUCH PANEL DSP DIGITAL SIGNAL PROCESSOR DTC DATA TELECOMMUNICATION CONTRACTOR TR TELECOMMUNICATION ROOM DVD DIGITAL VIDEO DISC PLAYER TERMINAL STRIP PROJECT NO .: DRAWN BY: ELECTRICAL CONTRACTOR TVT TV/RF TUNER CHECKED BY: APA DATE: 01/31/11 FPD FLAT PANEL DISPLAY UON UNLESS OTHERWISE NOTED SCALE: NONE USB UNIVERSAL SERIAL BUS GC GENERAL CONTRACTOR HDP HIGH-DEF PLAYER SHEET TITLE: VCA VOLTAGE CONTROLLED AMPLIFIER HST HAND/HEAD SET VCR VIDEO CASSETTE RECORDER **AUDIOVISUAL** INTEGRATED AUDIO AMPLIFIER VDC VCR/DVD COMBO SYMBOLS LIST IFP INTERFACE PANEL VDP VIDEO PROCESSOR ISOLATED GROUND VOL VOLUME CONTROL AND DRAWING IRD INFRARED DISPLAY VPJ VIDEO PROJECTOR INDEX JBX JUNCTION BOX VSW VIDEO SWITCHER KVM KEYBOARD/VIDEO/MOUSE WAP WIRELESS ACCESS POINT MIC MICROPHONE WRX WIRELESS RECEIVER MIX MIXER WTP WIRELESS TOUCH PANEL MON MONITOR WTX WIRELESS TRANSMITTER SHEET NO: TA-001

All drawings and written material appearing herein constitute original and unpublished work of the Architect/Engineer and may not be duplicated, used or disclosed without consent of Architect/Engineer.

If this drawing is not 30"x42", then the drawing has been revised from its original size.

Noted scales must be adjusted. This line should be equal to one inch

| YMBOI | DESCRIPTION PATHWAY FEED | COMMENTS | DEVICE BOX | RING | | OVISUAL BAC | COMMENTS FACEPLATE | | NOTES |
|------------------|---|----------|--|--|---|--|--|-------|-----------------------------|
| BCAM | CEILING BOX FOR SKYTRON CAMERA | _ | 1 GANG, 2 1/2" DEEP | - | | IN-CEILING | | | SEE DETAIL 12, SHEET TA-501 |
| | | | | | | | | | OFF DETAIL OF OUTET TA FOA |
| B ^{PJR} | CEILING BOX FOR PROJECTOR | 1.a | 2 GANG, 2 1/2" DEEP | - | 2 | IN-CEILING | 6, 9 - | _ | SEE DETAIL 2, SHEET TA-501 |
| В | AV FLOOR BOX | 1.a | SEE SPECIFICATIONS | - | 2 | IN FLOOR | 4, 7, 8 – | _ | SEE DETAIL 7, SHEET TA-501 |
| PT | AV POKE-THRU | - | SEE SPECIFICATIONS | - | 2 | IN FLOOR | 4, 7, 8 - | _ | SEE DETAIL 8, SHEET TA-501 |
| <u>s</u> | BACKCAN FOR CEILING MOUNTED LOUDSPEAKER | _ | SEE SPECIFICATIONS | - | 3 | IN-CEILING | | _ | SEE DETAIL 1, SHEET TA-501 |
| WB AUD | WALL BOX FOR AUDIO LINES | 1.b | 3 GANG, 2-1/2" DEEP | - | 2 | IN WALL AT OUTLET HEIGHT, UON | | _ | |
| WB CAM | WALL BOX FOR CAMERA | 1.b | 2 GANG, 2-1/2" DEEP | - | 2 | IN WALL AT OUTLET HEIGHT, UON | 9 – | _ | - |
| WB cc | WALL BOX FOR VIDEO INTERFACE | 1.b | 2 GANG, 2-1/2" DEEP | - | 2 | IN WALL AT OUTLET HEIGHT, UON | | _ | SEE DETAIL 12, SHEET TA-501 |
| WB EWB | WALL BOX FOR ELECTRONIC WHITEBOARD | 1.b | 2 GANG, 2 1/2" DEEP | - | 2 | IN WALL AT SWITCH HEIGHT, UON | 9 – | _ | _ |
| WB FPD | WALL BOX FOR FLAT PANEL DISPLAY | 1.a | 2 GANG, 2 1/2" DEEP | - | 2 | IN WALL AT SWITCH HEIGHT, UON | 9 – | _ | SEE DETAIL 5, SHEET TA-501 |
| WB IFP | WALL BOX FOR INTERFACE PLATE | 1.a | 2 GANG, 2-1/2" DEEP | - | 2 | IN WALL AT SWITCH HEIGHT, UON | 9 – | _ | |
| WB PSC | WALL BOX FOR PROJECTION SCREEN CONTROLLER | 1.a | 1 GANG, 2 1/2" DEEP | - | 2 | IN WALL AT SWITCH HEIGHT, UON | | _ | |
| WB VC | WALL BOX FOR VOLUME CONTROL | 1.a | 1 GANG, 2 1/2" DEEP | - | 2 | IN WALL AT SWITCH HEIGHT, UON | | _ | _ |
| WB WC | WALL BOX FOR CAMERA WALL CONTROL | 1.b | CUSTOM BOX FROM SKYTRON | - | 2 | IN WALL AT SWITCH HEIGHT, UON | 4 – | _ | SEE DETAIL 12, SHEET TA-501 |
| | | ···· | ······································ | ~~~~~~~~~~~~~~~~~~~~~~~~~~~~~~~~~~~~~~ | | | ~~~~~~~~~~~~~~~~~~~~~~~~~~~~~~~~~~~~~~ | ····· | |
| WB CP | WALL BOX FOR CONTROL PANEL | - | TO BE DETERMINED | - | _ | IN WALL AT SWITCH HEIGHT, UON | - - | _ | |
| WB SC | WALL BOX FOR SCREEN CONTROL | 1.b | 1 GANG, 2 1/2" DEEP | - | 2 | ON WALL ABOVE CEILING, ADJACENT TO PROJECTION SCREEN | | - | - |
| €B)FPD | CEILING BOX FOR (FUTURE) FLAT PANEL DISPLAY | _ | 2 GANG, 2 1/2" DEEP | - | 2 | IN-CEILING | 6, 9 – | _ | _ |

NUMBERED COMMENTS

- 1. ELECTRICAL CONTRACTOR SHALL PROVIDE:
- a. DEVICE BOX AND CONTINUOUS CONDUIT FROM BOX TO TERMINAL PANEL (WB-TP) OR FLOOR BOX (FB-INT)
- b. CONDUIT STUB WITH PULL STRING FROM CEILING SPACE DOWN WALL TO DEVICE BOX
- c. CONDUIT TO DAISY-CHAIN FROM BOX TO BOX
- 2. ELECTRICAL CONTRACTOR SHALL PROVIDE DEVICE BOX AND RING.
- 3. AUDIOVISUAL CONTRACTOR SHALL PROVIDE DEVICE BOX.
- 4. DEVICE SHARED WITH ELECTRICAL. REFER TO ELECTRICAL FOR DEVICE TYPE AND INSTALLATION REQUIREMENTS.
- 5. PROVIDE TWO DUPLEX OUTLETS ADJACENT TO BOX. REFER TO ELECTRICAL DRAWINGS.
- 6. PROVIDE (2) DATA PORTS ON SINGLE GANG PLATE ADJACENT TO BOX.

 7. PROVIDE DURI EX OUTLIET WITHIN BOX REFER TO ELECTRICAL DRAWINGS
- PROVIDE DUPLEX OUTLET WITHIN BOX. REFER TO ELECTRICAL DRAWINGS.
 PROVIDE (2) DATA PORTS ON SINGLE GANG PLATE WITHIN BOX.
- 9. PROVIDE SINGLE DUPLEX OUTLET ADJACENT TO BOX. REFER TO ELECTRICAL DRAWINGS.

GENERAL COMMENTS

- A. CIRCUITS ARE 120 VAC, 60 HZ, 1-PHASE, UNLESS OTHERWISE NOTED.
- B. PROVIDE POWER TO THE AUDIOVISUAL SYSTEMS FROM THE SAME PHASE LEG.
- C. PROVIDE A SEPARATE TRANSFORMER TAP AND SERVICE PANEL TO THE AUDIOVISUAL SYSTEM. DO NOT SHARE POWER WITH LIGHTING AND VARIABLE LOAD DEVICES (I.E.: ELEVATOR MOTORS, WATER HEATERS).
- D. REFER TO FLOOR PLANS FOR DIAGRAMMATIC LAYOUT OF AUDIOVISUAL DEVICES.

WRNSSTUDIOLLP

501 SECOND STREET 4TH FLOOR, STE. 402 SAN FRANCISCO CALIFORNIA 94107 415.489.2224 TEL 415.358.9100 FAX WWW.WRNSSTUDIO.COM

Steinberg Architects







| | www.teecom.com | |
|-----|--|----------|
| NO. | ISSUES/REVISIONS | DATE |
| 1 | 100% SCHEMATIC DESIGN SUBMITTAL | 04/28/08 |
| 2 | 50% DESIGN DEVELOPMENT SUBMITTAL | 06/13/08 |
| 3 | 100% DESIGN DEVELOPMENT SUBMITTAL | 07/28/08 |
| 4 | DSA INCREMENT #1: SITE DEMOLITION, EXCAVATION, ROUGH GRADING & UTILITIES | 09/25/08 |
| 5 | INCREMENT 2 80% REVIEW | 10/10/08 |
| 6 | DSA INCREMENT #2: STRUCTURE & GFRC PANELS | 11/11/08 |
| 7 | DSA INCREMENT #3 50% REVIEW | 11/11/08 |
| 8 | DSA INCREMENT #1: BACK CHECK | 11/19/08 |
| 9 | DSA INCREMENT #3: 90% REVIEW | 12/19/08 |
| 10 | DSA INCREMENT #3: TENANT IMPROVEMENT & ROOFING SYSTEM | 02/09/09 |
| 11 | DSA INCREMENT #2: BACKCHECK | 03/11/09 |
| 12 | DSA INCREMENT #3: BACKCHECK | 05/12/09 |
| 13 | PROJECT RECORD SET | 01/31/11 |

PROJECT RECORD SET

SKYLINE COLLEGE CIP2 DESIGN-BUILD BUILDING 4N

PROJECT NO.: DRAWN BY: WAC

DATE: 01/31/11 CHECKED BY: APA


SCALE: NONE

BACKBOX SCHEDULE

AND NOTES

SHEET NO:

SHEET TITLE:

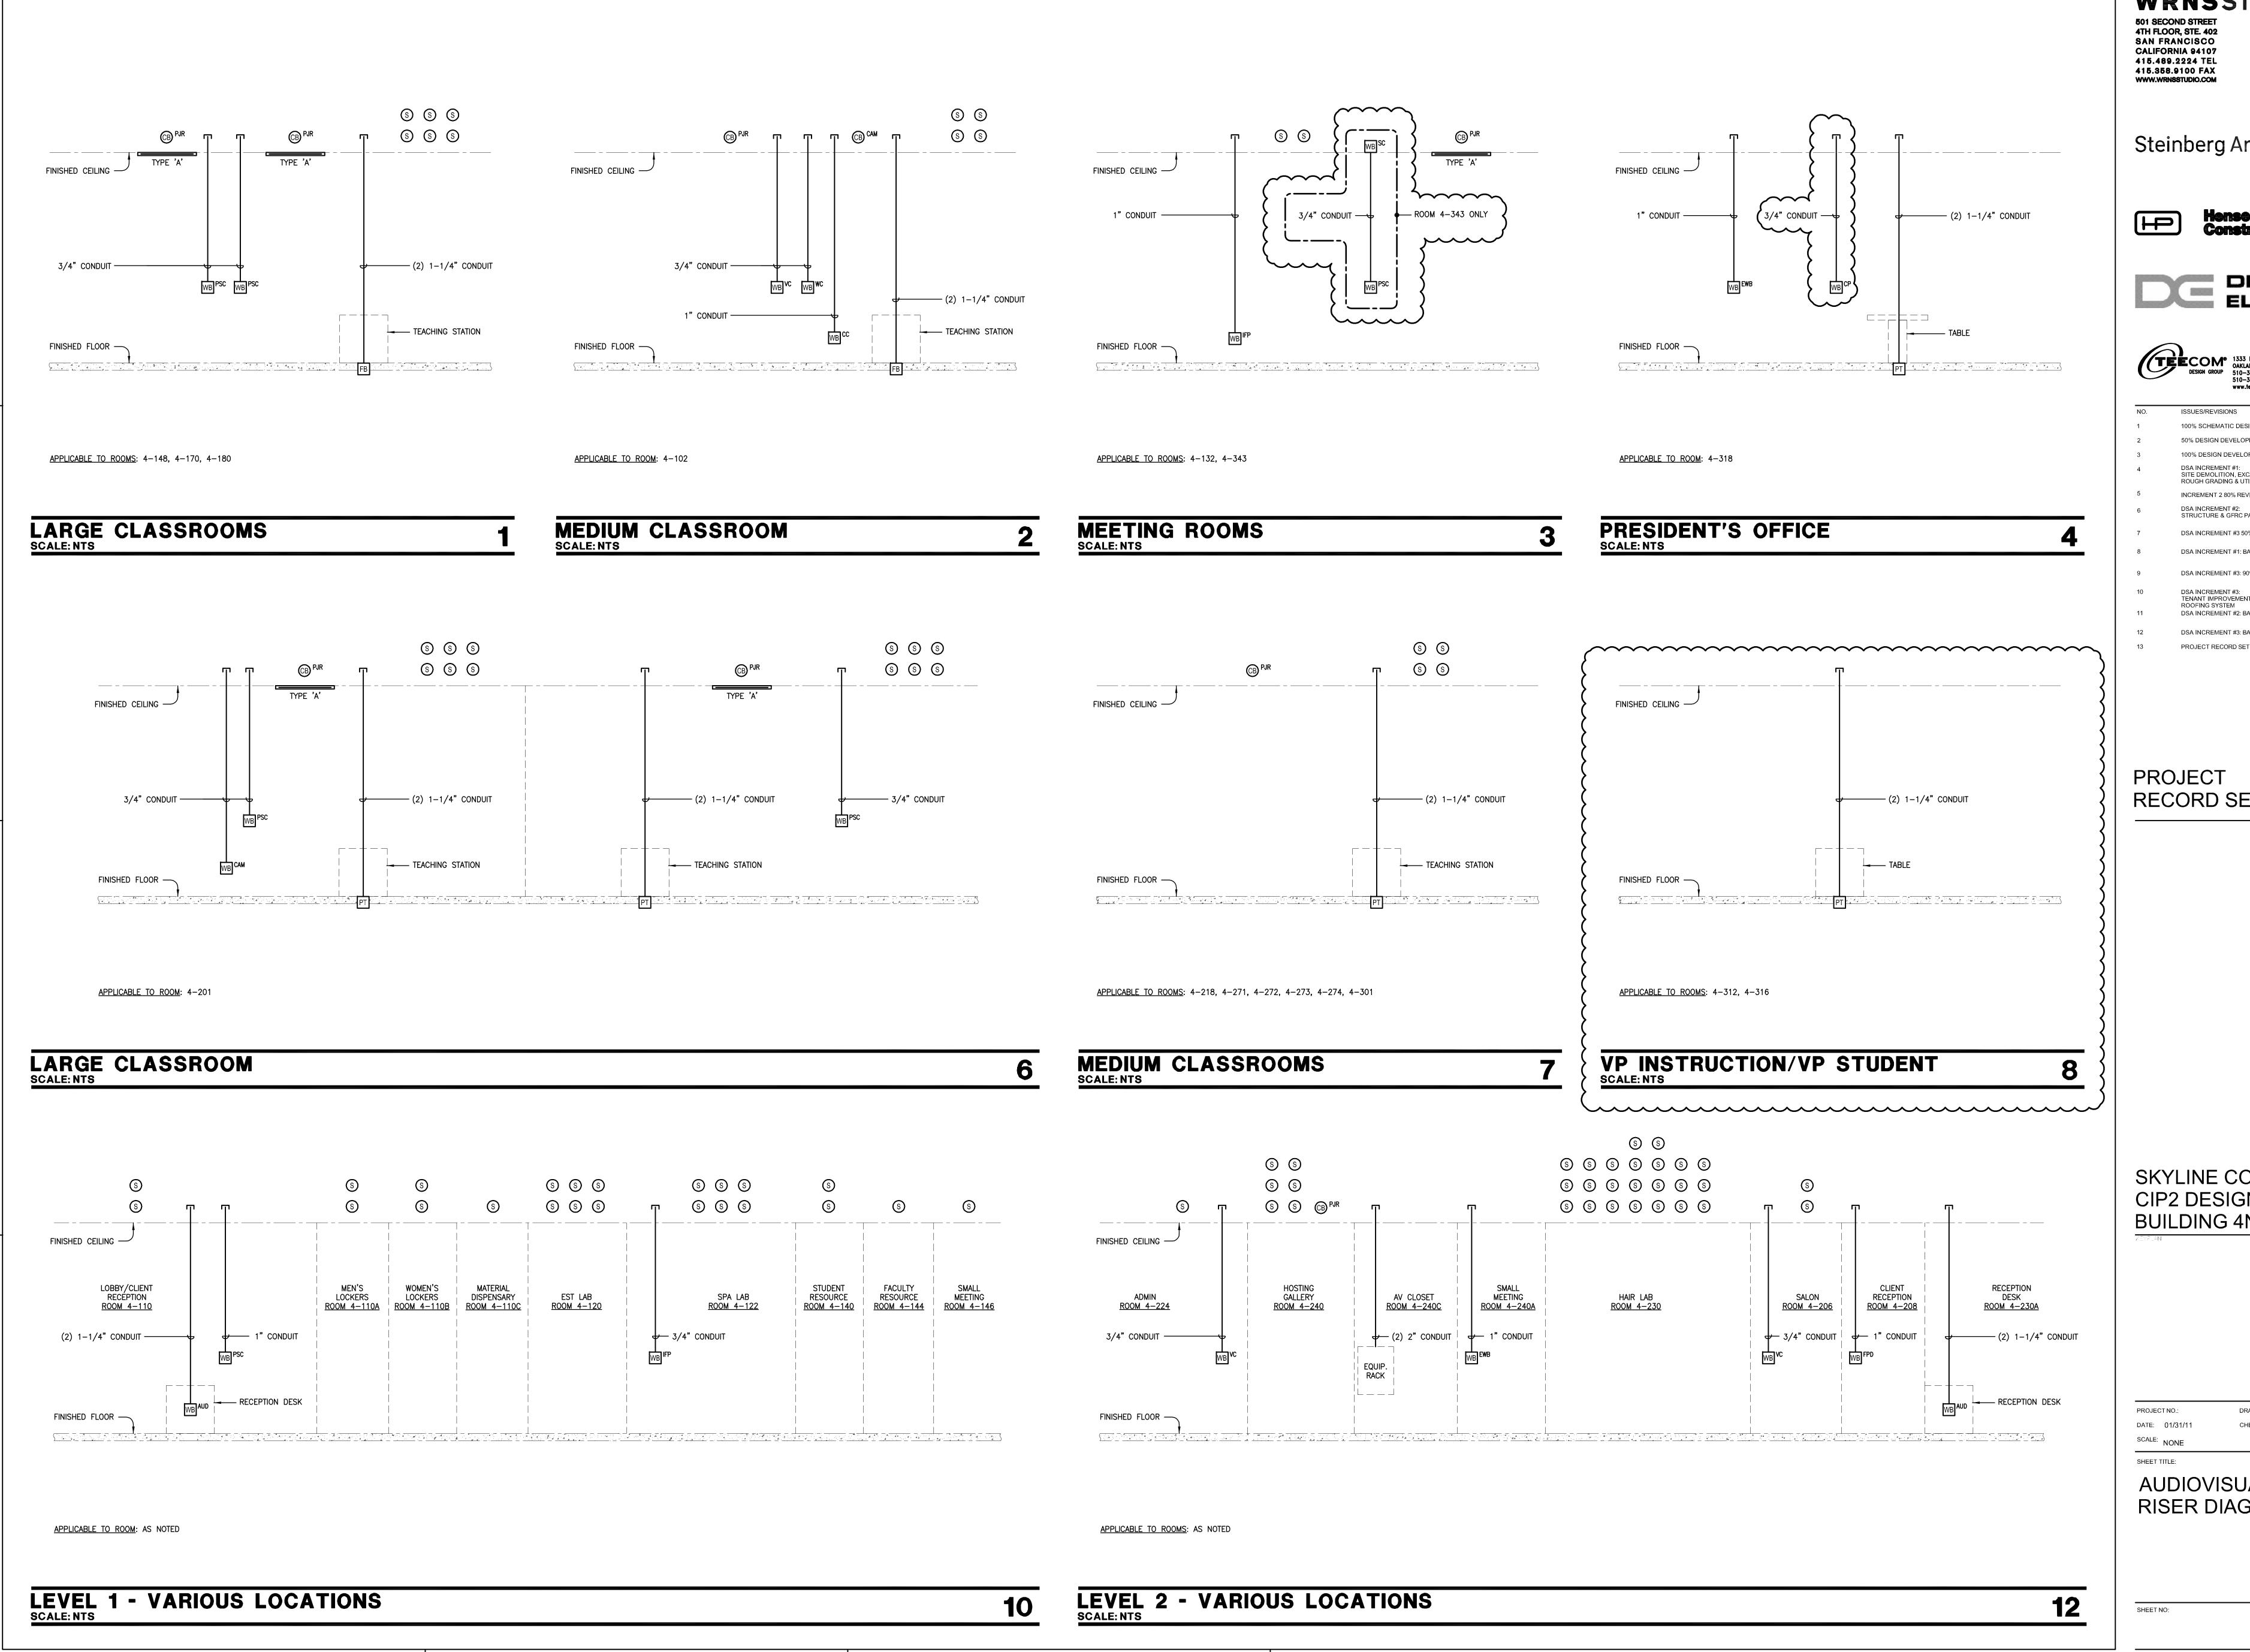

WRNSSTUDIO 501 SECOND STREET 4TH FLOOR, STE. 402 SAN FRANCISCO

CALIFORNIA 94107 415.489.2224 TEL 415.358.9100 FAX WWW.WRNSSTUDIO.COM

Steinberg Architects







| | www.teecom.com | |
|-----|--|----------|
| NO. | ISSUES/REVISIONS | DATE |
| 1 | 100% SCHEMATIC DESIGN SUBMITTAL | 04/28/08 |
| 2 | 50% DESIGN DEVELOPMENT SUBMITTAL | 06/13/08 |
| 3 | 100% DESIGN DEVELOPMENT SUBMITTAL | 07/28/08 |
| 4 | DSA INCREMENT #1: SITE DEMOLITION, EXCAVATION, ROUGH GRADING & UTILITIES | 09/25/08 |
| 5 | INCREMENT 2 80% REVIEW | 10/10/08 |
| 6 | DSA INCREMENT #2: STRUCTURE & GFRC PANELS | 11/11/08 |
| 7 | DSA INCREMENT #3 50% REVIEW | 11/11/08 |
| 8 | DSA INCREMENT #1: BACK CHECK | 11/19/08 |
| 9 | DSA INCREMENT #3: 90% REVIEW | 12/19/08 |
| 10 | DSA INCREMENT #3: TENANT IMPROVEMENT & | 02/09/09 |
| 11 | ROOFING SYSTEM DSA INCREMENT #2: BACKCHECK | 03/11/09 |
| 12 | DSA INCREMENT #3: BACKCHECK | 05/12/09 |
| | | |

PROJECT RECORD SET

SKYLINE COLLEGE CIP2 DESIGN-BUILD **BUILDING 4N**

DATE: 01/31/11 SCALE: NONE

AUDIOVISUAL RISER DIAGRAMS

TA-011

If this drawing is not 30"x42", then the drawing has been revised from its original size. Noted scales must be adjusted. This line should be equal to one inch

All drawings and written material appearing herein constitute original and unpublished work of the Architect/Engineer and may not be duplicated, used or disclosed without consent of Architect/Engineer.

ELECTRICAL:

11.5

ELEVATOR EQUIP. RM

reserration rates fra

F3E3F3 | & || & || F3E3F3F3E3F3

FB WB VC

MECHANICAL ROOM

4-100

MEDIUM CLASSROOM 4-102 CC WB WB WB

N. ELEV

EV01

CORRIDOR

4-191

STAIR

LOBBY CLIENT RECEPTION

4-110

WOMEN'S

LOCKERS

4-110B

LOCKER

CORRIDOR 4-191

STORAGE

4-120A

(12)

ELECTRICAL ROOM

4-104A

E-1 COORDINATE EXACT LOCATION OF WALL BOX WITH OWNER'S REPRESENTATIVE.

A

В

<u>C</u>

- C.6

-C.8

D



501 SECOND STREET 4TH FLOOR, STE. 402 SAN FRANCISCO CALIFORNIA 94107 415.489.2224 TEL 415.358.9100 FAX www.wrnsstudio.com

Steinberg Architects

WRNSSTUDIO








| NO. | ISSUES/REVISIONS | DATE |
|-----|--|----------|
| 1 | 100% SCHEMATIC DESIGN SUBMITTAL | 04/28/08 |
| 2 | 50% DESIGN DEVELOPMENT SUBMITTAL | 06/13/08 |
| 3 | 100% DESIGN DEVELOPMENT SUBMITTAL | 07/28/08 |
| 4 | DSA INCREMENT #1: SITE DEMOLITION, EXCAVATION, ROUGH GRADING & UTILITIES | 09/25/08 |
| 5 | INCREMENT 2 80% REVIEW | 10/10/08 |
| 6 | DSA INCREMENT #2: STRUCTURE & GFRC PANELS | 11/11/08 |
| 7 | DSA INCREMENT #3 50% REVIEW | 11/11/08 |
| 8 | DSA INCREMENT #1: BACK CHECK | 11/19/08 |
| 9 | DSA INCREMENT #3: 90% REVIEW | 12/19/08 |
| 10 | DSA INCREMENT #3: TENANT IMPROVEMENT & | 02/09/09 |
| 11 | ROOFING SYSTEM DSA INCREMENT #2: BACKCHECK | 03/11/09 |
| 12 | DSA INCREMENT #3: BACKCHECK | 05/12/09 |
| | | |

PROJECT **RECORD SET**

PROJECT RECORD SET

SKYLINE COLLEGE CIP2 DESIGN-BUILD **BUILDING 4N**

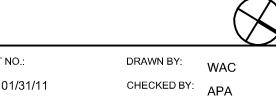

PROJECT NO.: DATE: 01/31/11 SCALE: 3/32" = 1'-0" SHEET TITLE:

LEVEL 1 AUDIOVISUAL OVERALL **FLOOR PLAN**

SHEET NO:

TA-101

0 2 4 8 16 FT

If this drawing is not 30"x42", then the drawing has been revised from its original size. Noted scales must be adjusted. This line should be equal to one inch

All drawings and written material appearing herein constitute original and unpublished work of the Architect/Engineer and may not be duplicated, used or disclosed without consent of Architect/Engineer.

WBIFP+18" AFF

STAFF RSTRM

FACULTY RESOURCE

4-144

ENTRY LOBBY

ELEVATOR EQUIP. RM

4-154

4-156

CORRIDOR 4-194

STUDENT RESOURCE

4-140

SMALL MEETING 4-146

LARGE

4-148

4-150

LARGE

CLASSROOM 4-180

S. ELEV

TDA ______

MEN'S RSTRM 4-152

В

B.2

<u>C</u>

C.5

E

F

G

HHW S&R CLOSET

4-196

_ 4-142 _

MEETING

4-132

FACULTY CORRIDOR

4-134 4-192 4-192

FACULTY OFFICE

JANITOR 4-138

4-191

LAUNDRY

[----] [4-122 | [-----]

SPA EST STORAGE 4-130

MATERIAL

DISPENSARY

VESTIBULE

4-195

ELECTRICAL:

E-1 COORDINATE EXACT LOCATION OF WALL BOX WITH OWNER'S REPRESENTATIVE.



WRNSSTUDIO 501 SECOND STREET 4TH FLOOR, STE. 402 SAN FRANCISCO **CALIFORNIA 94107** 415.489.2224 TEL 415.358.9100 FAX WWW.WRNSSTUDIO.COM

Steinberg Architects








| NO. | ISSUES/REVISIONS | DATE |
|-----|--|----------|
| 1 | 100% SCHEMATIC DESIGN SUBMITTAL | 04/28/08 |
| 2 | 50% DESIGN DEVELOPMENT SUBMITTAL | 06/13/08 |
| 3 | 100% DESIGN DEVELOPMENT SUBMITTAL | 07/28/08 |
| 4 | DSA INCREMENT #1: SITE DEMOLITION, EXCAVATION, ROUGH GRADING & UTILITIES | 09/25/08 |
| 5 | INCREMENT 2 80% REVIEW | 10/10/08 |
| 6 | DSA INCREMENT #2: STRUCTURE & GFRC PANELS | 11/11/08 |
| 7 | DSA INCREMENT #3 50% REVIEW | 11/11/08 |
| 8 | DSA INCREMENT #1: BACK CHECK | 11/19/08 |
| 9 | DSA INCREMENT #3: 90% REVIEW | 12/19/08 |
| 10 | DSA INCREMENT #3: TENANT IMPROVEMENT & | 02/09/09 |
| 11 | ROOFING SYSTEM DSA INCREMENT #2: BACKCHECK | 03/11/09 |
| 12 | DSA INCREMENT #3: BACKCHECK | 05/12/09 |
| 13 | PROJECT RECORD SET | 01/31/11 |
| | | |

PROJECT RECORD SET


SKYLINE COLLEGE CIP2 DESIGN-BUILD **BUILDING 4N**

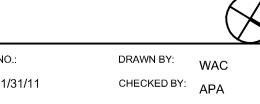

PROJECT NO.: DATE: 01/31/11 SCALE: 3/32" = 1'-0" SHEET TITLE:

LEVEL 2 AUDIOVISUAL **OVERALL** FLOOR PLAN

SHEET NO:

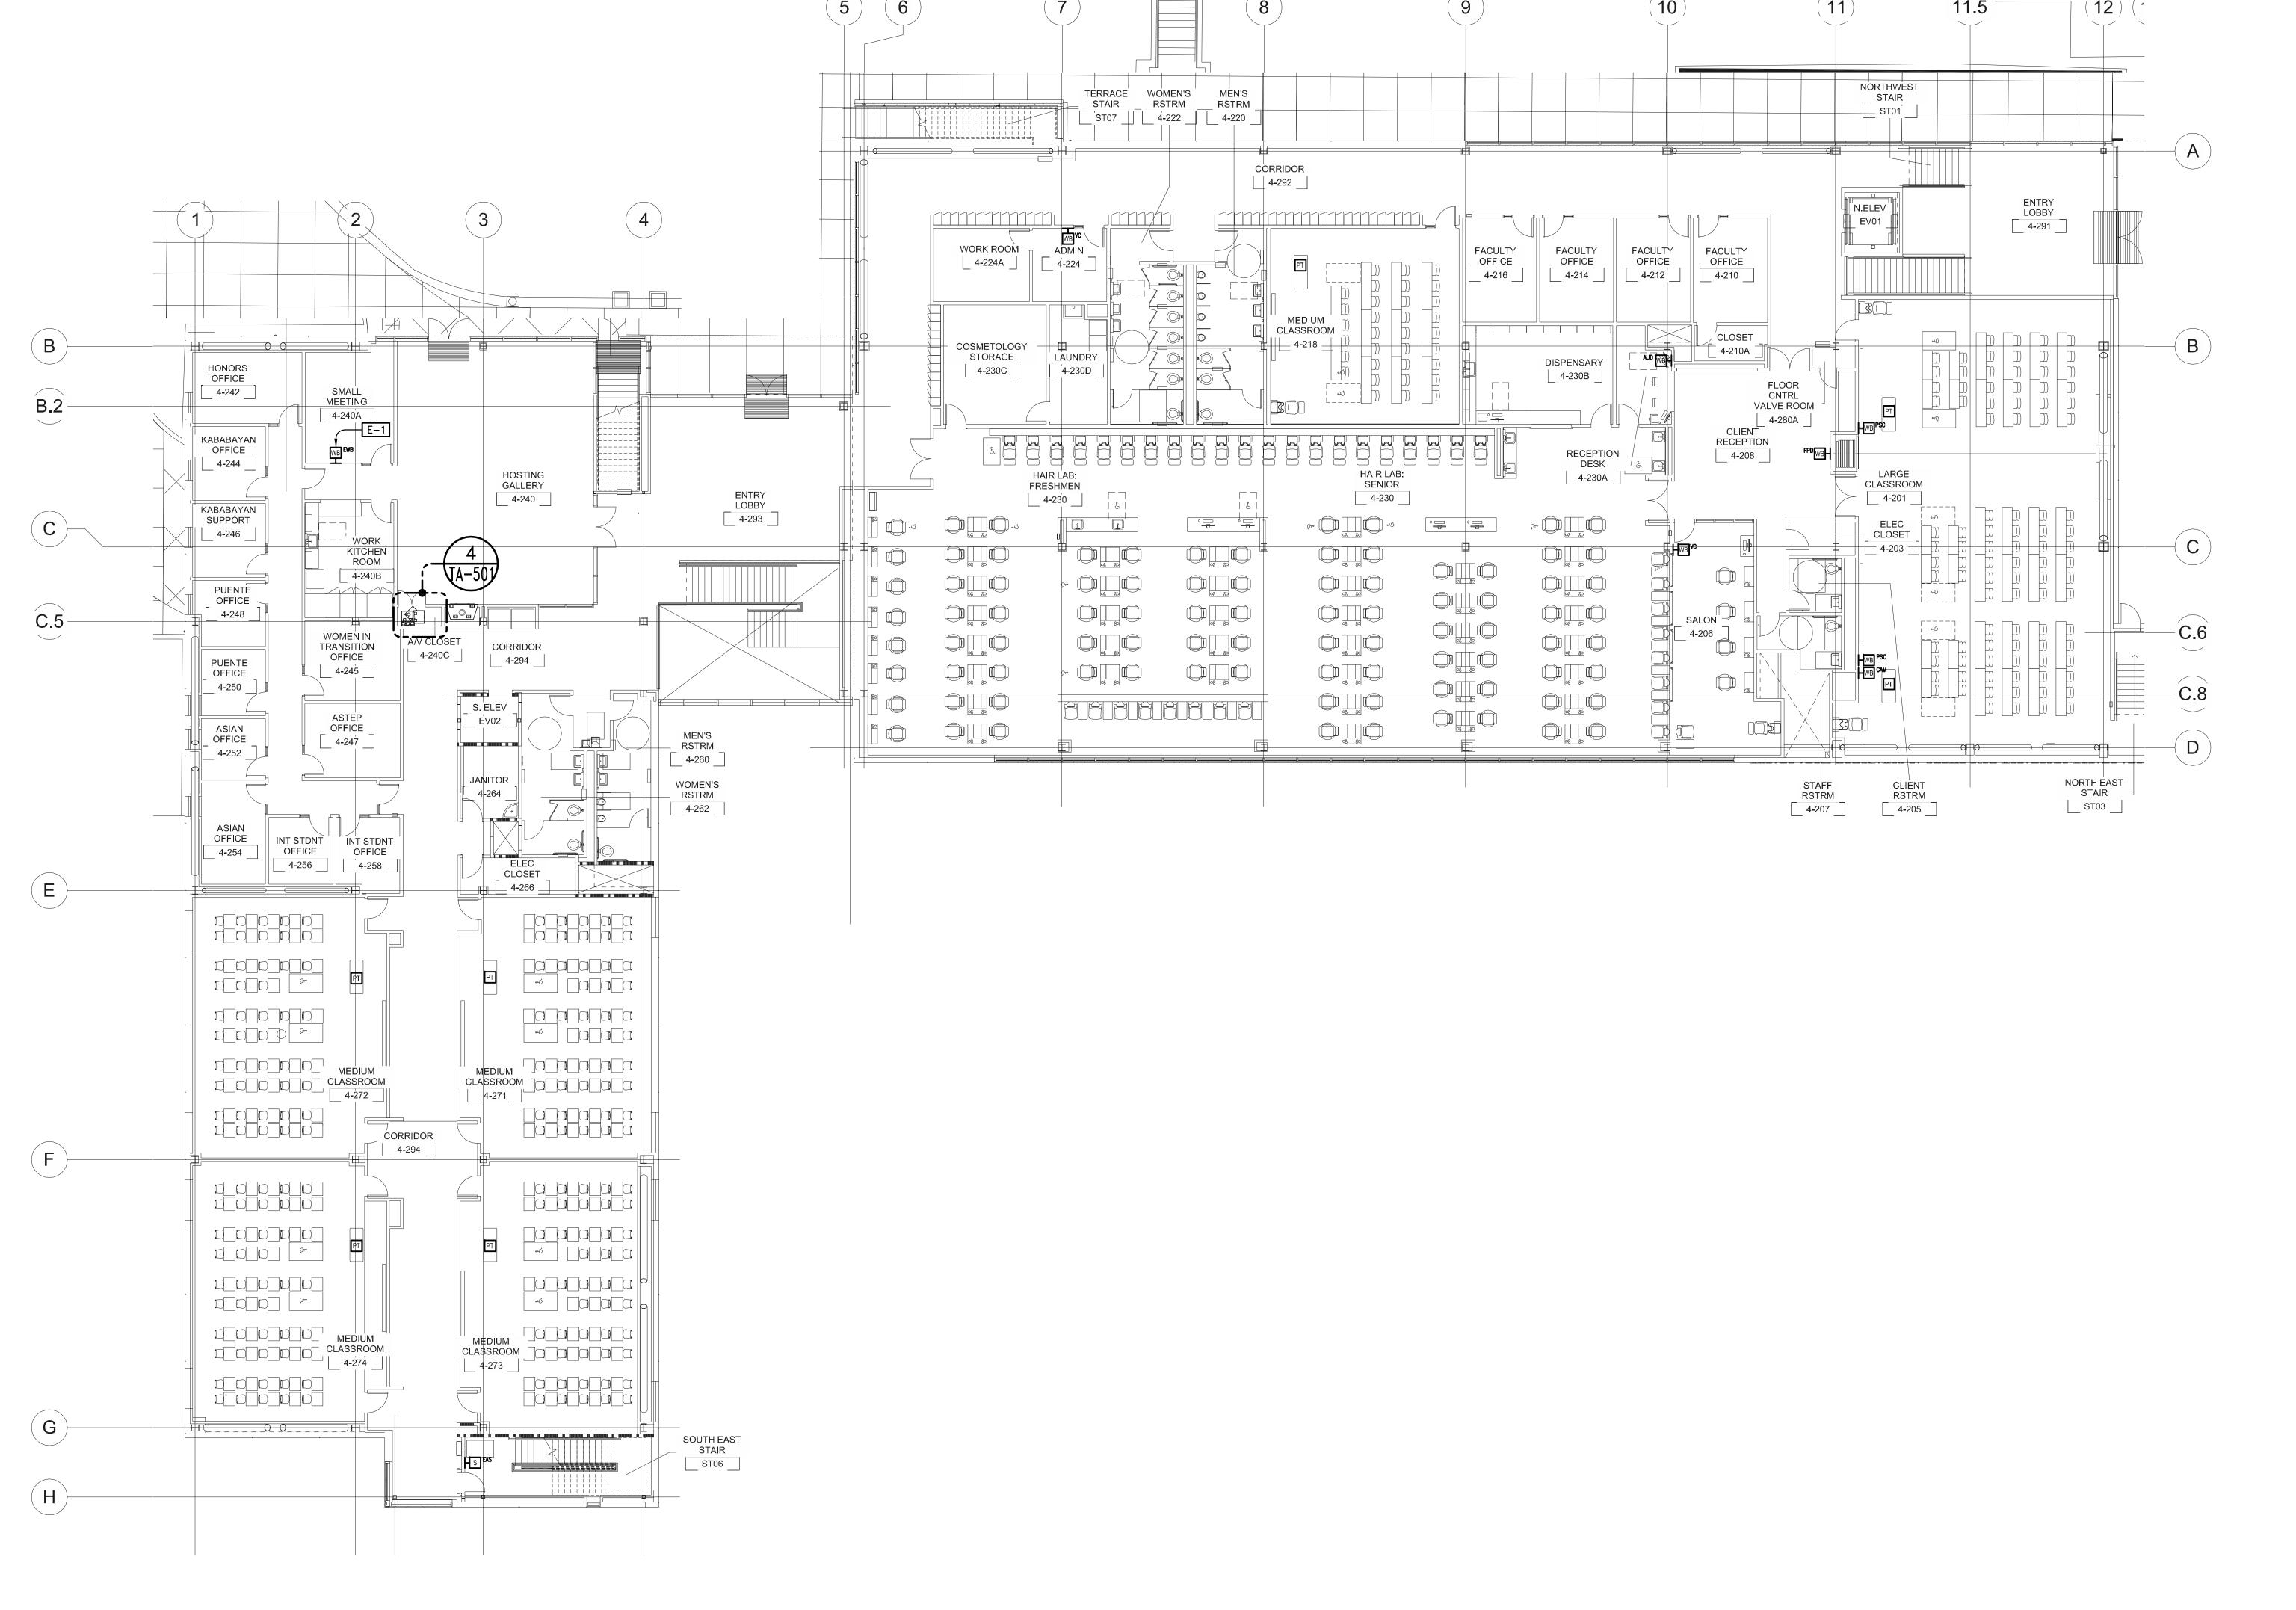

ELECTRICAL:

11.5

()00 ()00 ()00

CLASSROOM

WOMEN'S RSTRM

В

<u>C</u>

C.5 –

E

F

G

PRESIDENT'S OFFICE 4 2 8

4-320

OFFICE _______4-322 ____

CBO OFFICE ____4-324 ___

CBO STAFF

CBO STAFF 4-330

CBO STAFF
___4-332 ___

CBO OFFICE

4-334

MECHANICAL ROOM 4-342

4-328

PT FPD WB

BUS REC STORE

4-326

WORKROOM/ KITCHEN

4-327

MAINTENANCE STORAGE

STAFF
OFFICE

4-314

STAFF
OFFICE

4-311A

JANITOR 4-302

STAFF OFFICE 4-325

> STAFF OFFICE 4-329

4-392

STORAGE 4-329C

> ADMIN RECORD STORAGE

4-341

MEETING

STAIR ST06

ELECT CLOSET ELEVATOR LOBBY 4-391

4-325A

4-325B

4-329A

OFFICE 4-329B

E-1 COORDINATE EXACT LOCATION OF WALL BOX WITH OWNER'S REPRESENTATIVE.

(12) (13)

(C)

-C.6

C.8

D



WRNSSTUDIO

501 SECOND STREET
4TH FLOOR, STE. 402
SAN FRANCISCO
CALIFORNIA 94107
415.489.2224 TEL
415.358.9100 FAX
WWW.WRNSSTUDIO.COM

Steinberg Architects








| NO. | ISSUES/REVISIONS | DATE |
|-----|--|----------|
| | | |
| 1 | 100% SCHEMATIC DESIGN SUBMITTAL | 04/28/08 |
| 2 | 50% DESIGN DEVELOPMENT SUBMITTAL | 06/13/08 |
| 3 | 100% DESIGN DEVELOPMENT SUBMITTAL | 07/28/08 |
| 4 | DSA INCREMENT #1: SITE DEMOLITION, EXCAVATION, ROUGH GRADING & UTILITIES | 09/25/08 |
| 5 | INCREMENT 2 80% REVIEW | 10/10/08 |
| 6 | DSA INCREMENT #2: STRUCTURE & GFRC PANELS | 11/11/08 |
| 7 | DSA INCREMENT #3 50% REVIEW | 11/11/08 |
| 8 | DSA INCREMENT #1: BACK CHECK | 11/19/08 |
| 9 | DSA INCREMENT #3: 90% REVIEW | 12/19/08 |
| 10 | DSA INCREMENT #3: TENANT IMPROVEMENT & ROOFING SYSTEM | 02/09/09 |
| 11 | DSA INCREMENT #2: BACKCHECK | 03/11/09 |
| 12 | DSA INCREMENT #3: BACKCHECK | 05/12/09 |
| 13 | PROJECT RECORD SET | 01/31/11 |
| | | |

PROJECT RECORD SET

SKYLINE COLLEGE CIP2 DESIGN-BUILD BUILDING 4N

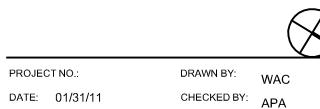

DATE: 01/31/11

SCALE: 3/32" = 1'-0"


SHEET TITLE:

LEVEL 3 AUDIOVISUAL OVERALL FLOOR PLAN

SHEET NO:

TA-103

0 2 4 8 16 FT

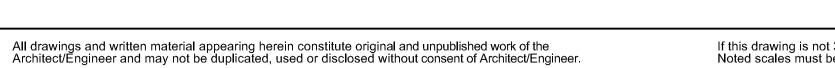

If this drawing is not 30"x42", then the drawing has been revised from its original size. Noted scales must be adjusted. This line should be equal to one inch


SYMBOL LIST

AUDIOVISUAL:

PT AV POKE-THRU, 6" ROUND, (2) 1-1/4" CONDUIT STUBBED UP TO ACCESSIBLE CEILING

WB FPD WALL BOX FOR FLAT PANEL DISPLAY, 2—GANG, CENTER OF BOX AT 52" AFF, (1) 1—1/4" CONDUIT STUBBED UP TO ACCESSIBLE CEILING. PROVIDE DATA AND ADJACENT TO BOX.

WB IFP WALL BOX FOR INTERFACE PLATE, 3—GANG, CENTER OF BOX AT 18" AFF, (2) 1—1/4" CONDUIT STUBBED UP TO ACCESSIBLE CEILING. PROVIDE DATA AND ADJACENT TO BOX.

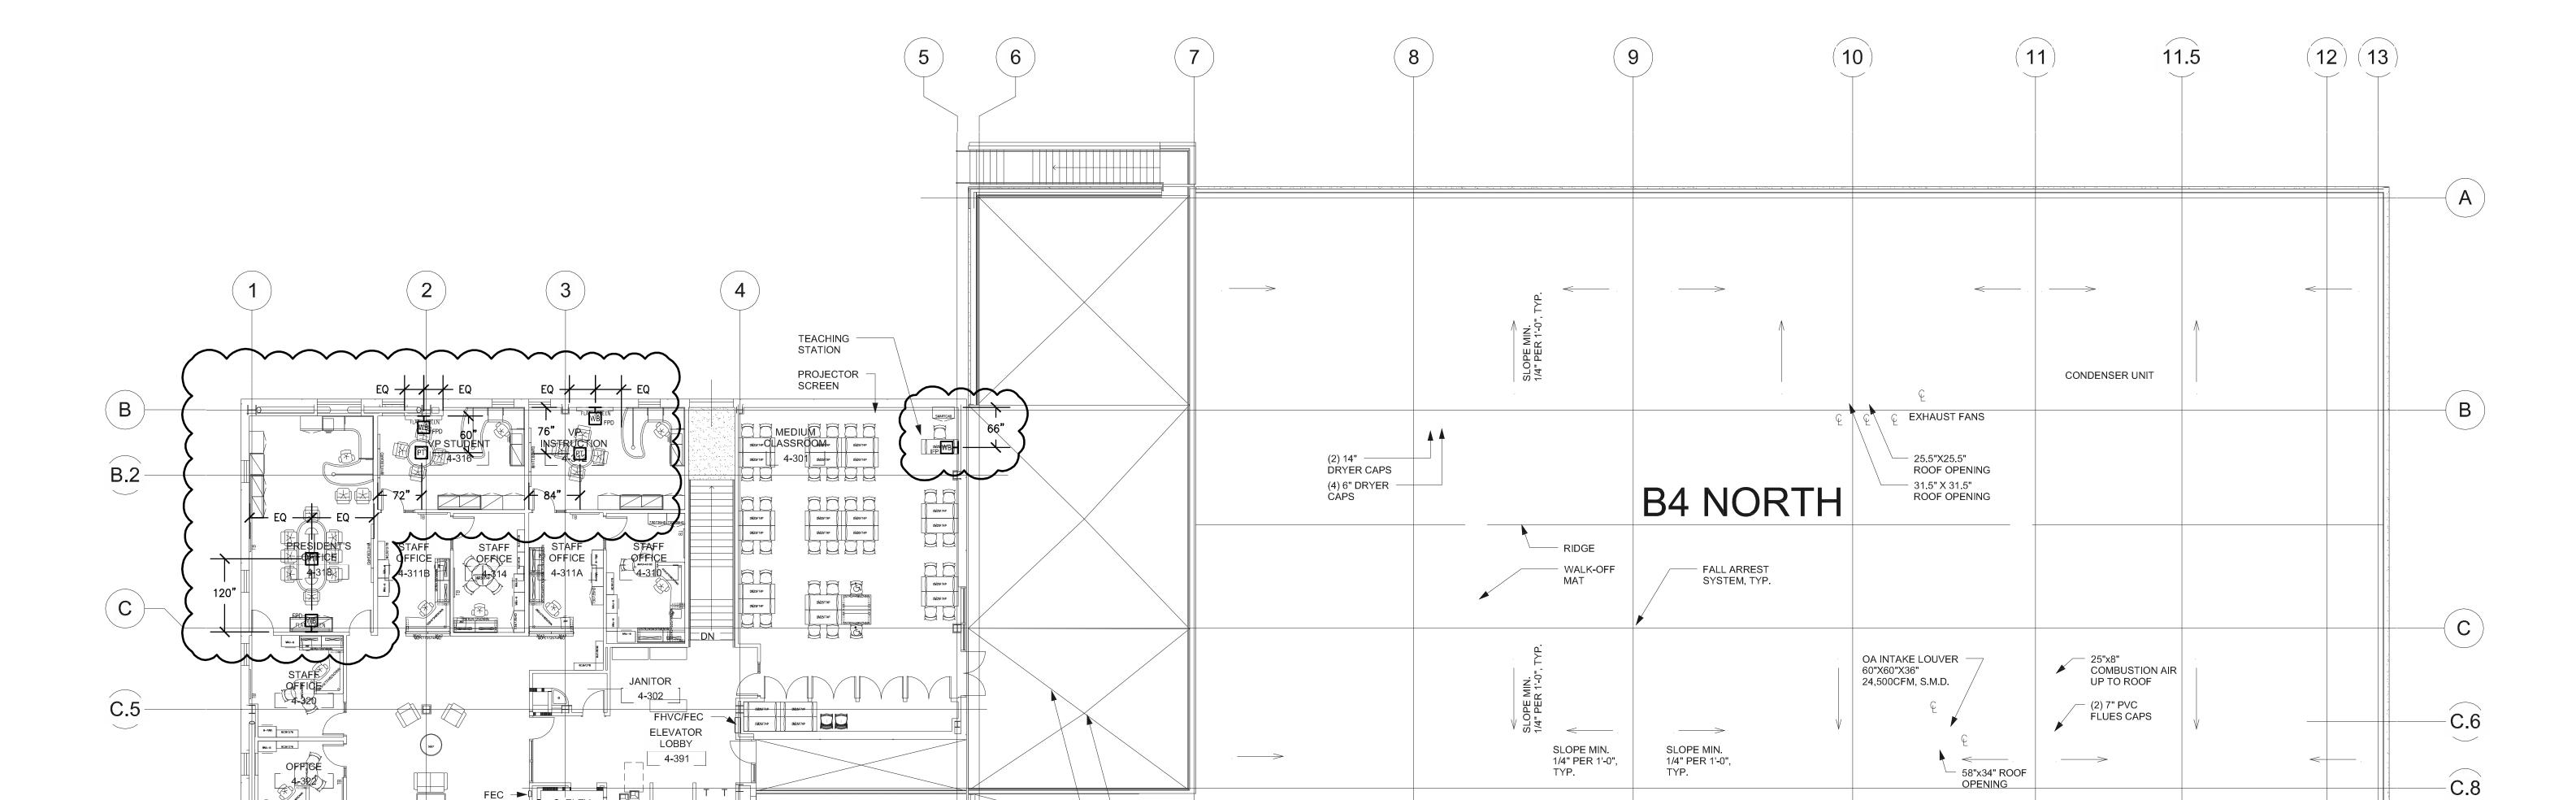

DECK DRAIN TYP.

 SLOPED DECK BELOW PEDESTAL PAVERS;

WOMEN'S RSTRM

ELECT - CLOSET

E

 $\left(\mathsf{G}\right)$

CBO STAFF

MECHANICAL ROOM 4-342 JANITOR 4-340

REFUGE

STAIR ST06 ROOF DRAIN
OVERFLOW
DRAIN TYP.

WRNSSTUDIO LLP

501 SECOND STREET 4TH FLOOR, STE. 402 SAN FRANCISCO CALIFORNIA 94107 415.489.2224 TEL 415.358.9100 FAX WWW.WRNSSTUDIO.COM

Steinberg Architects








| NO. | ISSUES/REVISIONS | DATE |
|-----|--|----------|
| 1 | 100% SCHEMATIC DESIGN SUBMITTAL | 04/28/08 |
| 2 | 50% DESIGN DEVELOPMENT SUBMITTAL | 06/13/08 |
| 3 | 100% DESIGN DEVELOPMENT SUBMITTAL | 07/28/08 |
| 4 | DSA INCREMENT #1: SITE DEMOLITION, EXCAVATION, ROUGH GRADING & UTILITIES | 09/25/08 |
| 5 | INCREMENT 2 80% REVIEW | 10/10/08 |
| 6 | DSA INCREMENT #2: STRUCTURE & GFRC PANELS | 11/11/08 |
| 7 | DSA INCREMENT #3 50% REVIEW | 11/11/08 |
| 8 | DSA INCREMENT #1: BACK CHECK | 11/19/08 |
| 9 | DSA INCREMENT #3: 90% REVIEW | 12/19/08 |
| 10 | DSA INCREMENT #3: TENANT IMPROVEMENT & ROOFING SYSTEM | 02/09/09 |
| 11 | DSA INCREMENT #2: BACKCHECK | 03/11/09 |
| 12 | DSA INCREMENT #3: BACKCHECK | 05/12/09 |
| 13 | PROJECT RECORD SET | 01/31/11 |

PROJECT RECORD SET

SKYLINE COLLEGE CIP2 DESIGN-BUILD BUILDING 4N

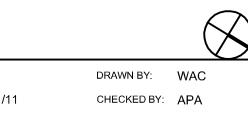

PROJECT NO.: DRAWN

DATE: 01/31/11 CHECK

SCALE: 3/32" = 1'-0"

SHEET TITLE:


LEVEL 3 AUDIOVISUAL OVERALL FLOOR PLAN

SHEET NO:

TA-103A

0 2 4 8 16 FT

D

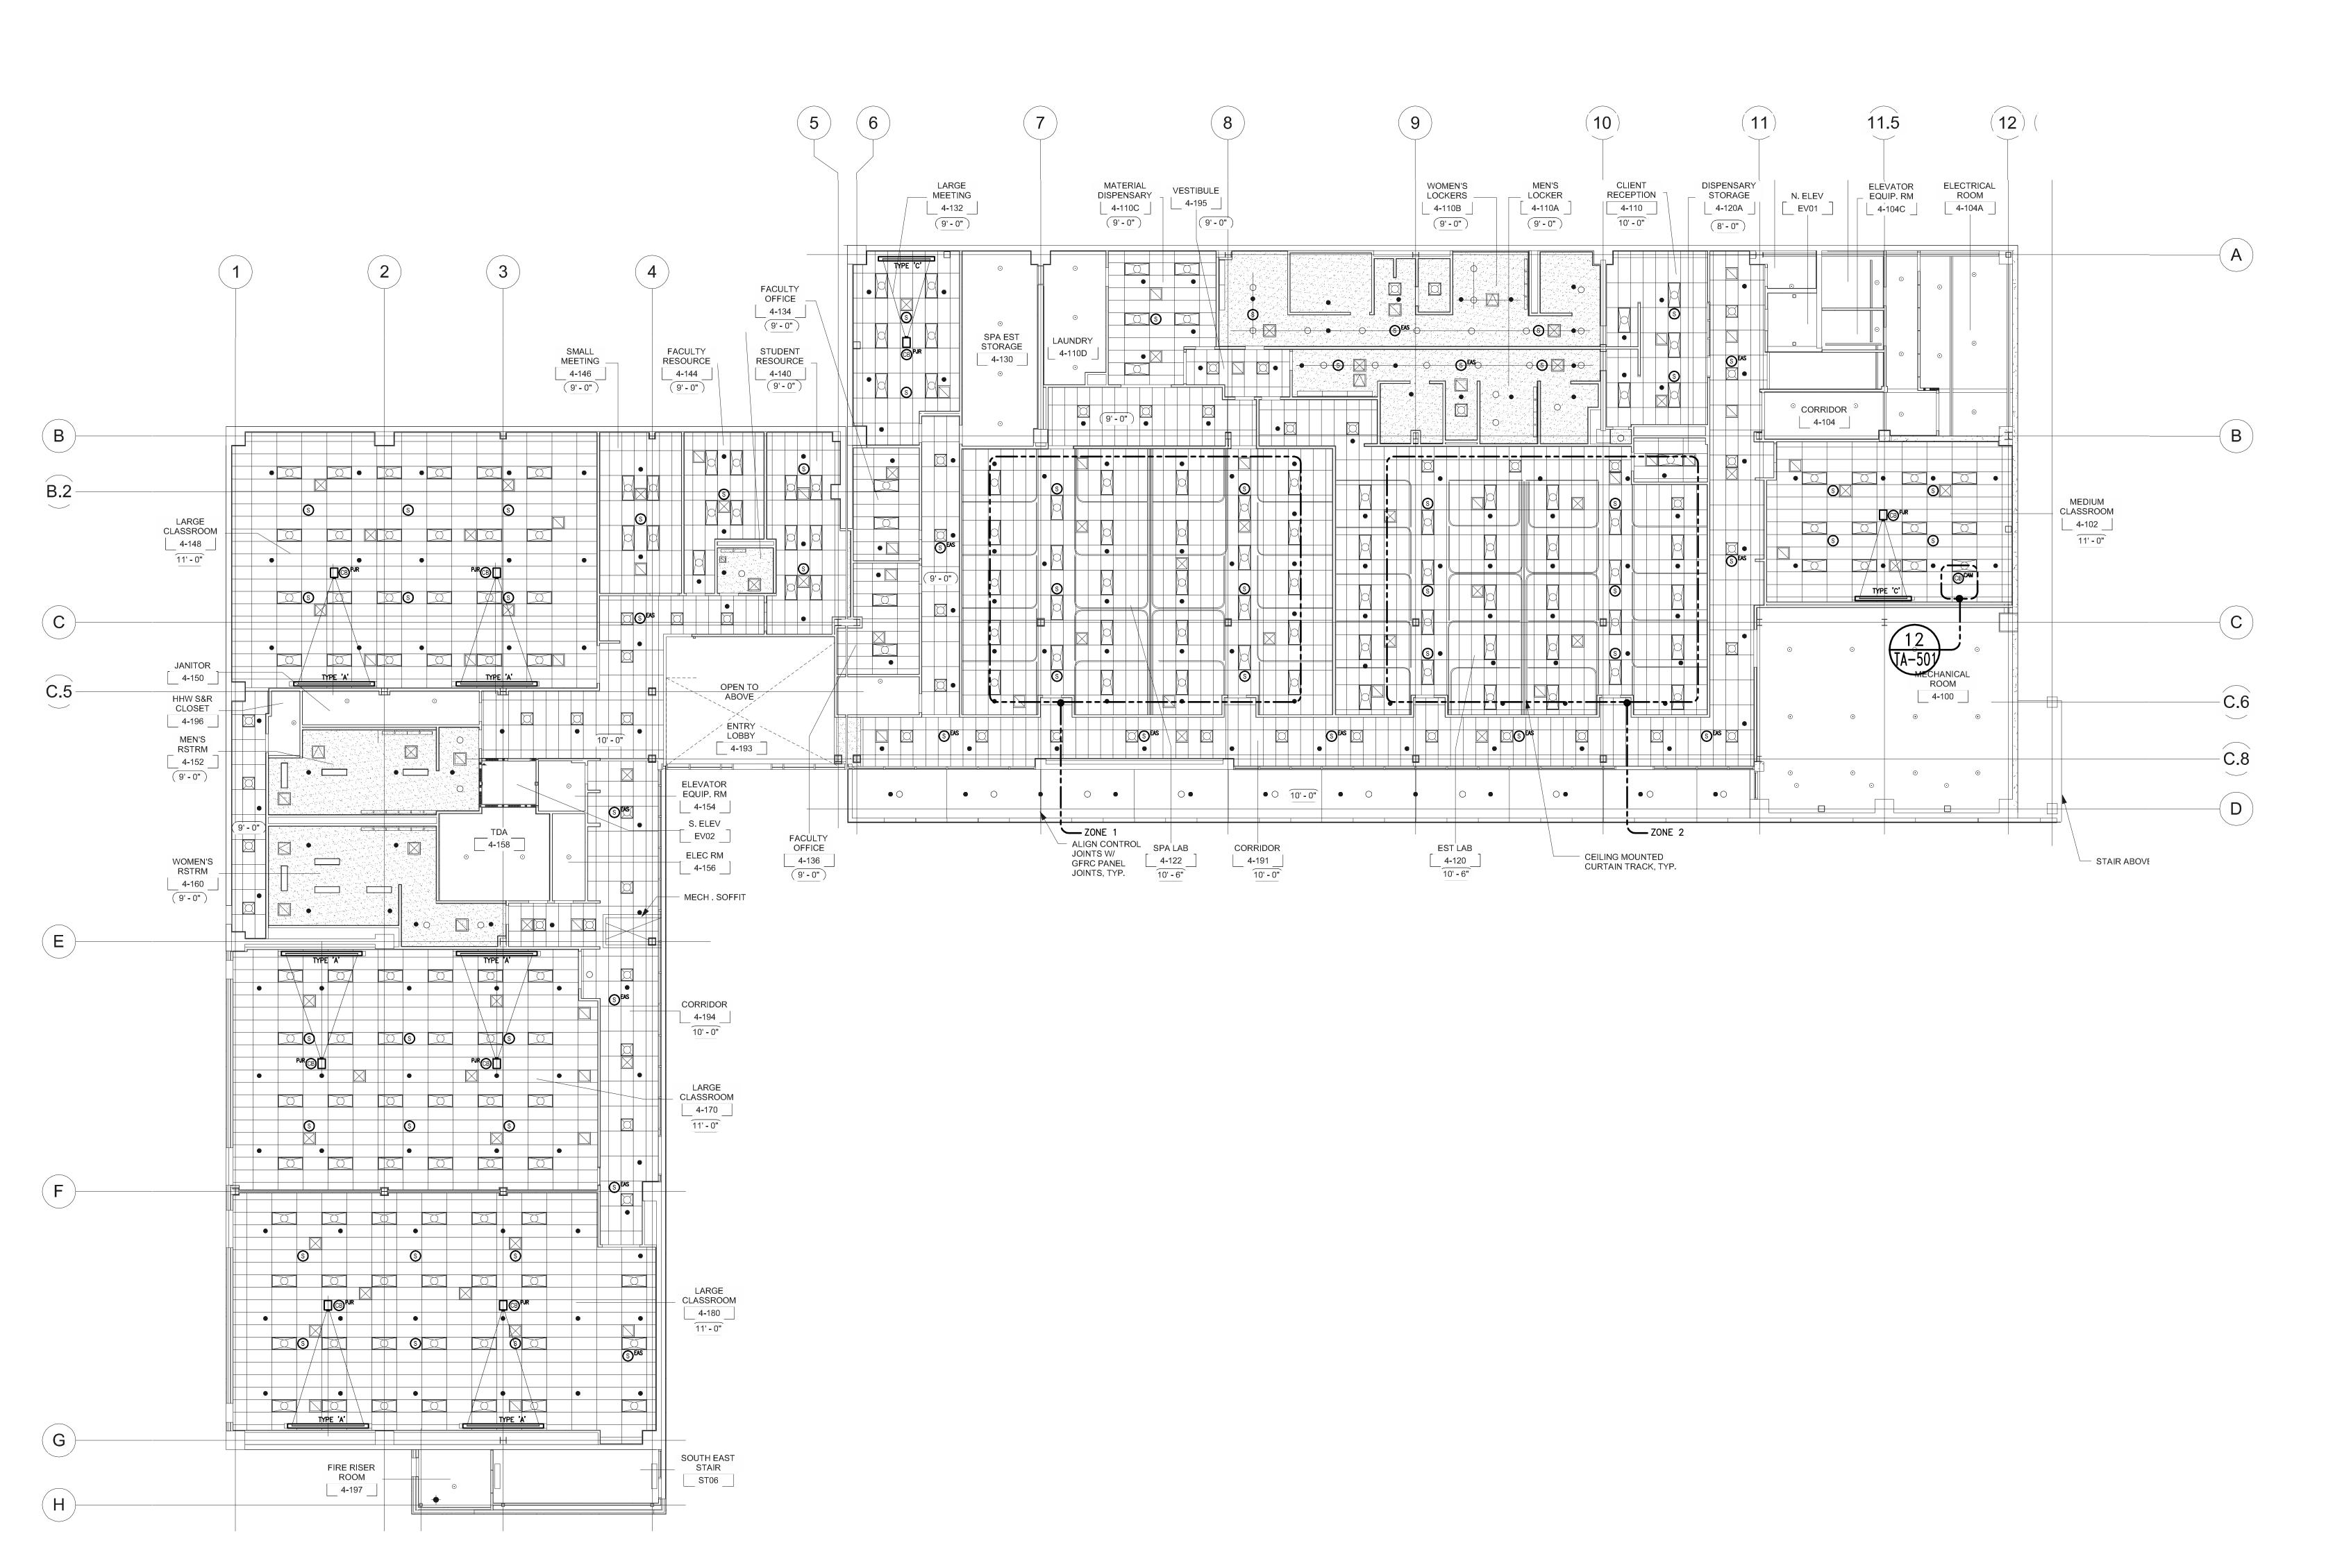

WRNSSTUDIO

501 SECOND STREET 4TH FLOOR, STE. 402 SAN FRANCISCO CALIFORNIA 94107 415.489.2224 TEL 415.358.9100 FAX WWW.WRNSSTUDIO.COM

Steinberg Architects








| NO. | ISSUES/REVISIONS | DATE |
|-----|--|----------|
| 1 | 100% SCHEMATIC DESIGN SUBMITTAL | 04/28/08 |
| 2 | 50% DESIGN DEVELOPMENT SUBMITTAL | 06/13/08 |
| 3 | 100% DESIGN DEVELOPMENT SUBMITTAL | 07/28/08 |
| 4 | DSA INCREMENT #1: SITE DEMOLITION, EXCAVATION, ROUGH GRADING & UTILITIES | 09/25/08 |
| 5 | INCREMENT 2 80% REVIEW | 10/10/08 |
| 6 | DSA INCREMENT #2: STRUCTURE & GFRC PANELS | 11/11/08 |
| 7 | DSA INCREMENT #3 50% REVIEW | 11/11/08 |
| 8 | DSA INCREMENT #1: BACK CHECK | 11/19/08 |
| 9 | DSA INCREMENT #3: 90% REVIEW | 12/19/08 |
| 10 | DSA INCREMENT #3: TENANT IMPROVEMENT & ROOFING SYSTEM | 02/09/09 |
| 11 | DSA INCREMENT #2: BACKCHECK | 03/11/09 |
| 12 | DSA INCREMENT #3: BACKCHECK | 05/12/09 |
| 13 | PROJECT RECORD SET | 01/31/11 |
| | | |

PROJECT RECORD SET

SKYLINE COLLEGE CIP2 DESIGN-BUILD BUILDING 4N

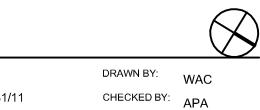

PROJECT NO.: DRAN

DATE: 01/31/11 CHEC

SCALE: 3/32" = 1'-0"

SHEET TITLE:

LEVEL 1 AUDIOVISUAL OVERALL R C P


SHEET NO:

0 2 4 8 16 FT

TA-201

All drawings and written material appearing herein constitute original and unpublished work of the Architect/Engineer and may not be duplicated, used or disclosed without consent of Architect/Engineer.

If this drawing is not 30"x42", then the drawing has been revised from its original size. Noted scales must be adjusted. This line should be equal to one inch

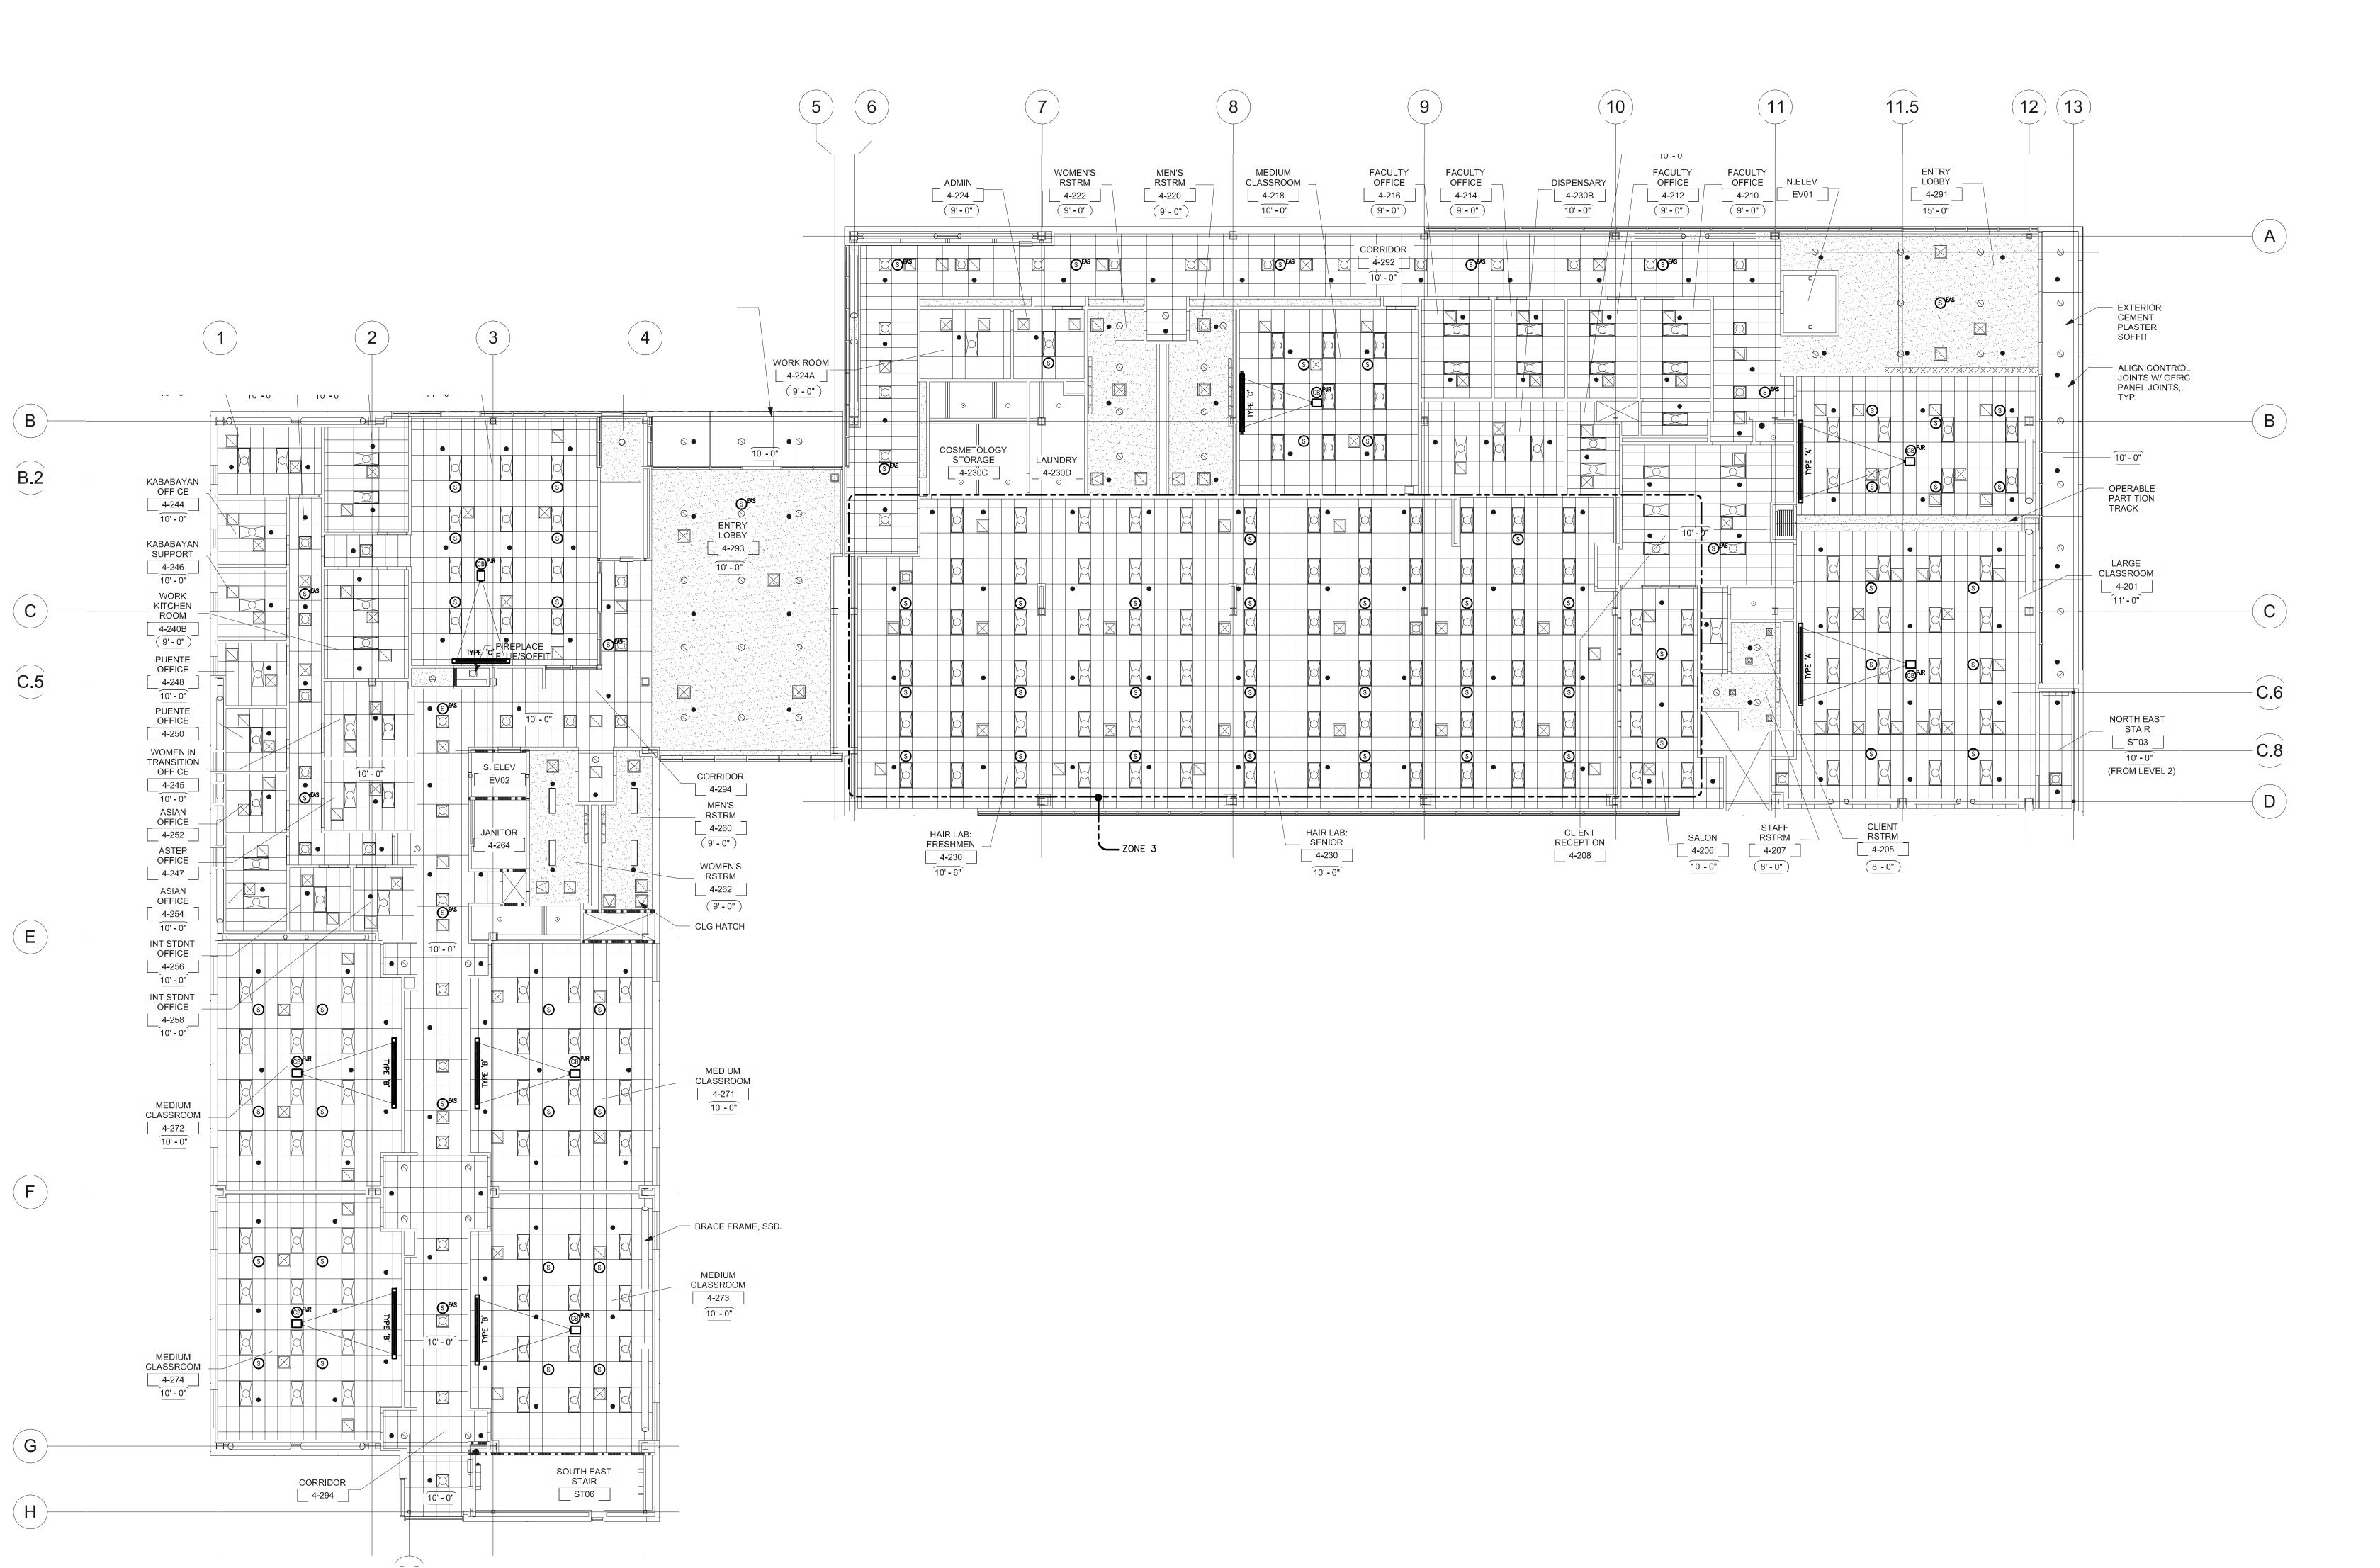

WRNSSTUDIO LLP

501 SECOND STREET 4TH FLOOR, STE. 402 SAN FRANCISCO CALIFORNIA 94107 415.489.2224 TEL 415.358.9100 FAX WWW.WRNSSTUDIO.COM

Steinberg Architects







| NO. | ISSUES/REVISIONS | DATE |
|-----|--|----------|
| 1 | 100% SCHEMATIC DESIGN SUBMITTAL | 04/28/08 |
| 2 | 50% DESIGN DEVELOPMENT SUBMITTAL | 06/13/08 |
| 3 | 100% DESIGN DEVELOPMENT SUBMITTAL | 07/28/08 |
| 4 | DSA INCREMENT #1: SITE DEMOLITION, EXCAVATION, ROUGH GRADING & UTILITIES | 09/25/08 |
| 5 | INCREMENT 2 80% REVIEW | 10/10/08 |
| 6 | DSA INCREMENT #2: STRUCTURE & GFRC PANELS | 11/11/08 |
| 7 | DSA INCREMENT #3 50% REVIEW | 11/11/08 |
| 8 | DSA INCREMENT #1: BACK CHECK | 11/19/08 |
| 9 | DSA INCREMENT #3: 90% REVIEW | 12/19/08 |
| 10 | DSA INCREMENT #3: TENANT IMPROVEMENT & ROOFING SYSTEM | 02/09/09 |
| 11 | DSA INCREMENT #2: BACKCHECK | 03/11/09 |
| 12 | DSA INCREMENT #3: BACKCHECK | 05/12/09 |
| 13 | PROJECT RECORD SET | 01/31/11 |

PROJECT RECORD SET

SKYLINE COLLEGE CIP2 DESIGN-BUILD BUILDING 4N

DRAWN BY: WAC
1/11 CHECKED BY: APA

PROJECT NO.: DRAWN BY: WARD DATE: 01/31/11 CHECKED BY: AF SCALE: 3/32" = 1'-0"

LEVEL 2 AUDIOVISUAL OVERALL R C P

SHEET NO:

0 2 4 8 16 FT

SHEET TITLE:

TA-202

All drawings and written material appearing herein constitute original and unpublished work of the Architect/Engineer and may not be duplicated, used or disclosed without consent of Architect/Engineer.

If this drawing is not 30"x42", then Noted scales must be adjusted. The Noted scales must be adjusted.

If this drawing is not 30"x42", then the drawing has been revised from its original size. Noted scales must be adjusted. This line should be equal to one inch

NUMBERED SHEET NOTES

ELECTRICAL:

E-1 provide conduit pathway to projection screen controller (\biguplus PSC) shown on FLOOR PLAN, SHEET TA-103.

501 SECOND STREET 4TH FLOOR, STE. 402 SAN FRANCISCO CALIFORNIA 94107 415.489.2224 TEL 415.358.9100 FAX www.wrnsstudio.com

Steinberg Architects

WRNSSTUDIO








| NO. | ISSUES/REVISIONS | DATE |
|-----|--|----------|
| 1 | 100% SCHEMATIC DESIGN SUBMITTAL | 04/28/08 |
| 2 | 50% DESIGN DEVELOPMENT SUBMITTAL | 06/13/08 |
| 3 | 100% DESIGN DEVELOPMENT SUBMITTAL | 07/28/08 |
| 4 | DSA INCREMENT #1: SITE DEMOLITION, EXCAVATION, ROUGH GRADING & UTILITIES | 09/25/08 |
| 5 | INCREMENT 2 80% REVIEW | 10/10/08 |
| 6 | DSA INCREMENT #2: STRUCTURE & GFRC PANELS | 11/11/08 |
| 7 | DSA INCREMENT #3 50% REVIEW | 11/11/08 |
| 8 | DSA INCREMENT #1: BACK CHECK | 11/19/08 |
| 9 | DSA INCREMENT #3: 90% REVIEW | 12/19/08 |
| 10 | DSA INCREMENT #3: TENANT IMPROVEMENT & | 02/09/09 |
| 11 | ROOFING SYSTEM DSA INCREMENT #2: BACKCHECK | 03/11/09 |
| 12 | DSA INCREMENT #3: BACKCHECK | 05/12/09 |
| 13 | PROJECT RECORD SET | 01/31/11 |

PROJECT RECORD SET

SKYLINE COLLEGE CIP2 DESIGN-BUILD **BUILDING 4N**

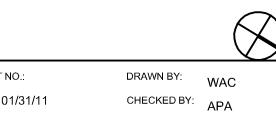

PROJECT NO.: DATE: 01/31/11 SCALE: 3/32" = 1'-0"

SHEET TITLE: LEVEL 3


AUDIOVISUAL OVERALL RCP

SHEET NO:

TA-203

0 2 4 8 16 FT

All drawings and written material appearing herein constitute original and unpublished work of the Architect/Engineer and may not be duplicated, used or disclosed without consent of Architect/Engineer. If this drawing is not 30"x42", then the drawing has been revised from its original size. Noted scales must be adjusted. This line should be equal to one inch

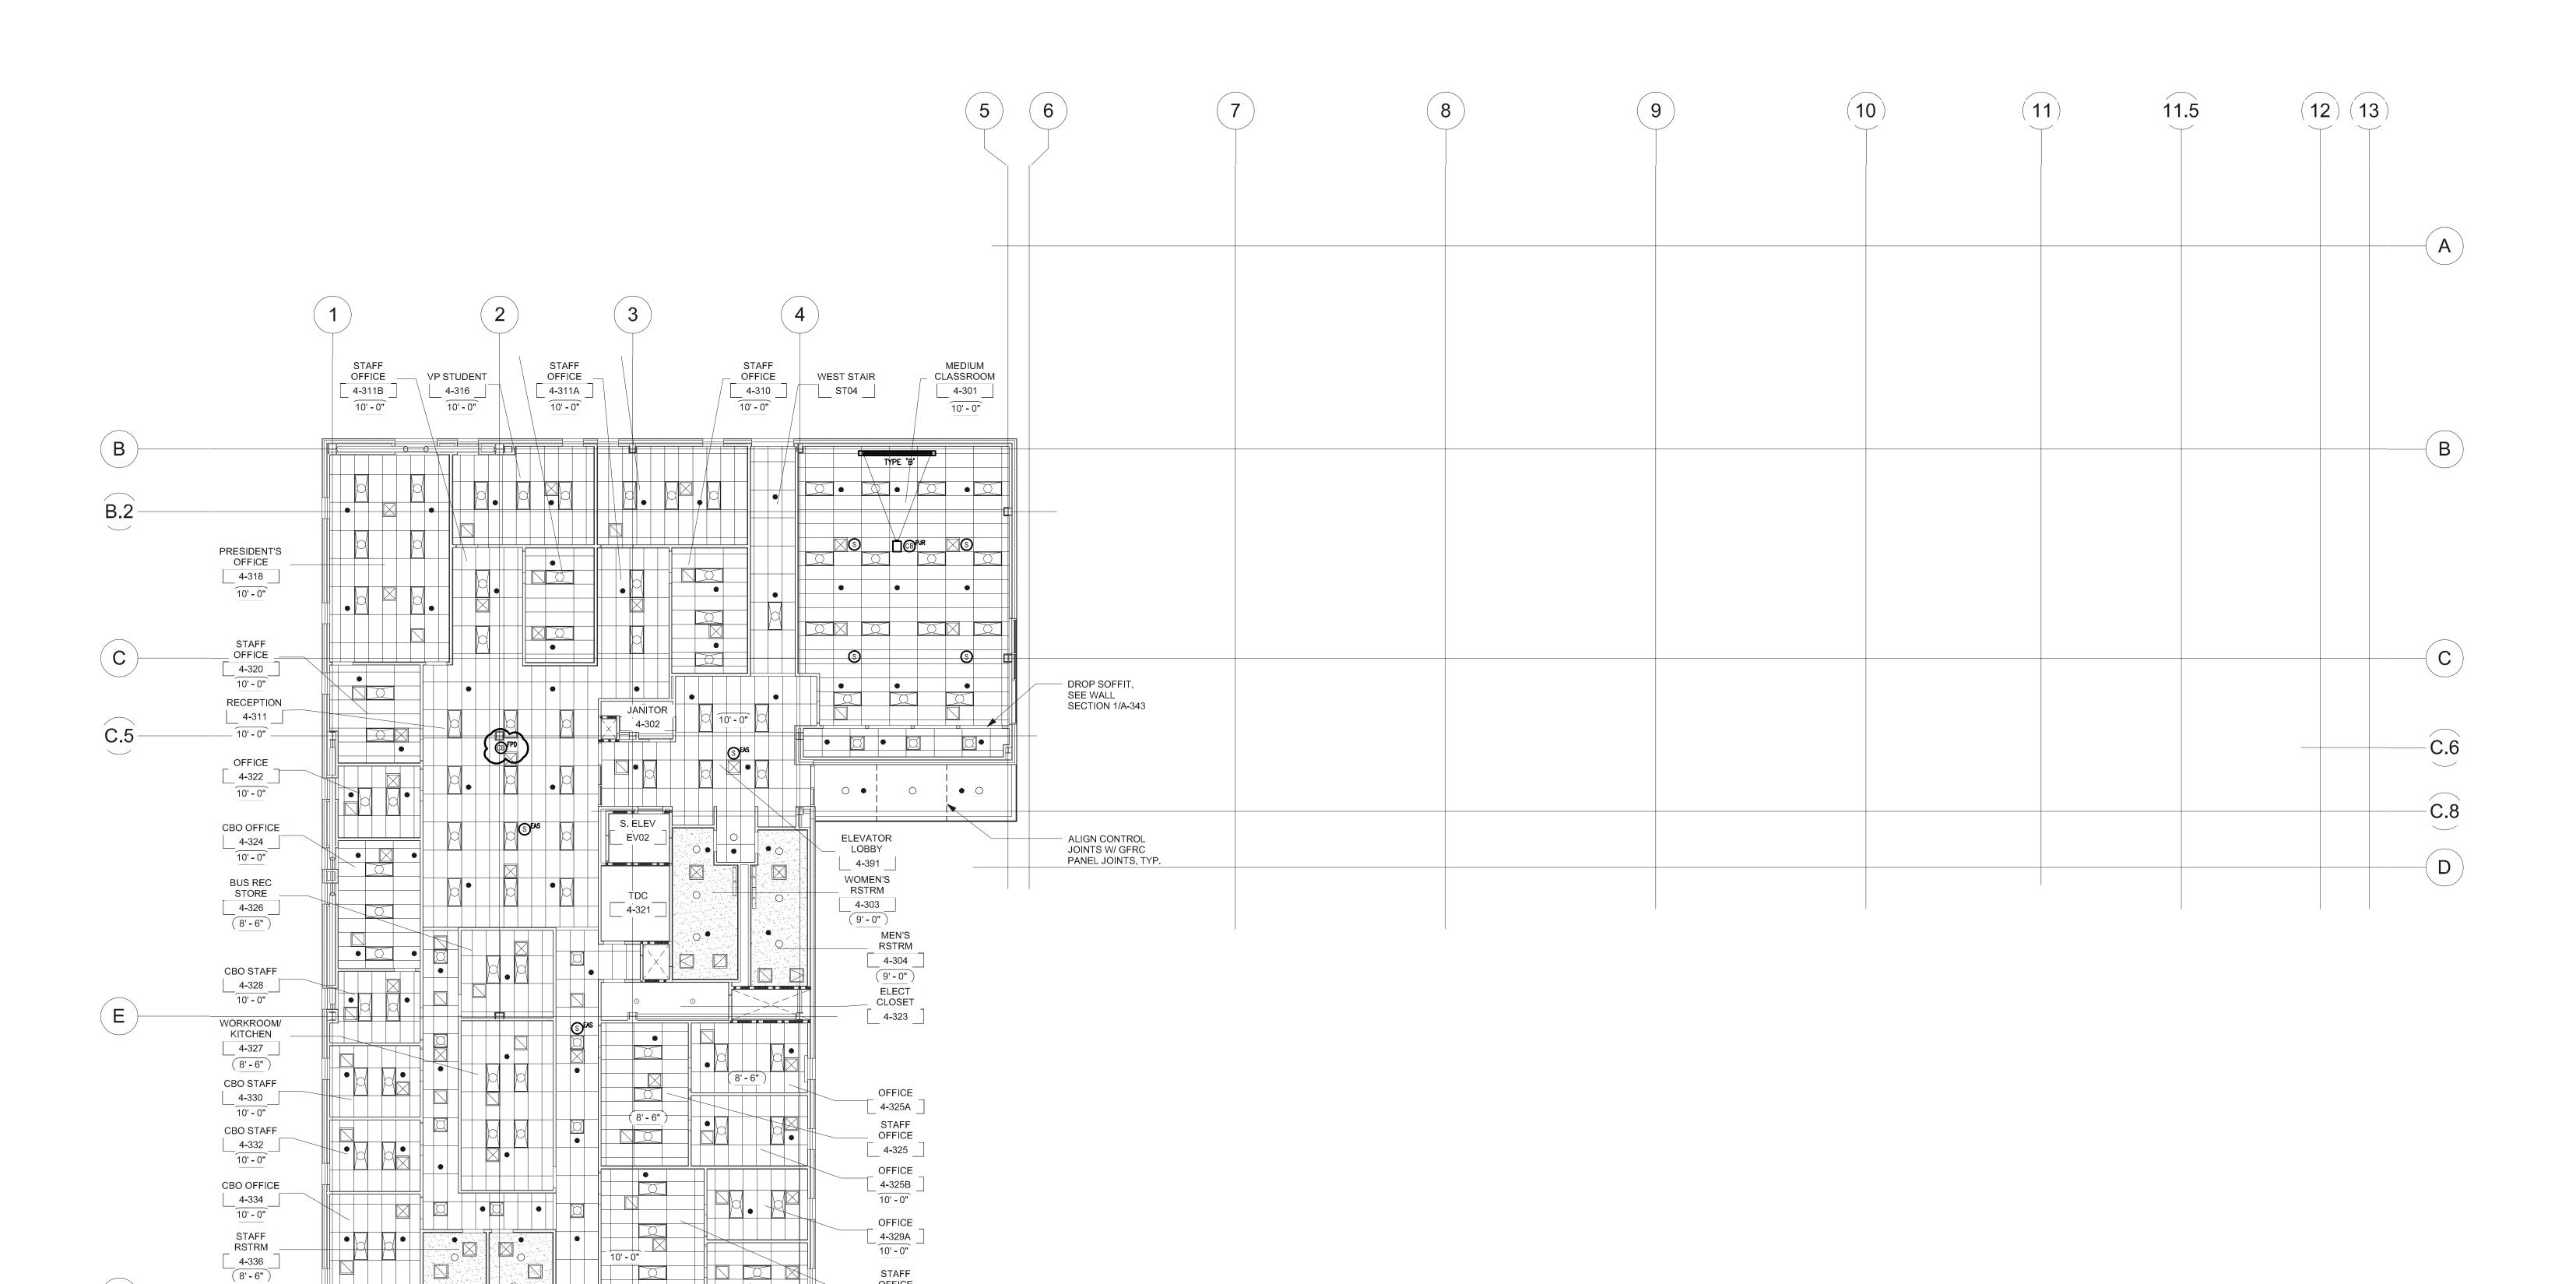

STAFF OFFICE

4-329

4-329B 10' - 0"

ADMIN RECORD STORAGE 4-341

10' - 0"

SMALL _ MEETING 4-343

SOUTH EAST

STAIR

ST06

BRACE FRAME, SSD.

RSTRM

4-338 (8' - 6")

MECHANICAL ROOM 4-342

MAINTENANCE

STORAGE

4-344

JANITOR

CORRIDOR

4-392

GENERAL SHEET NOTES

1. REFER TO ARCHITECTURAL DRAWINGS FOR ADDITIONAL ROOM SECTIONS AND ELEVATIONS

WRNSSTUDIO LLP
501 SECOND STREET


501 SECOND STREET 4TH FLOOR, STE. 402 SAN FRANCISCO CALIFORNIA 94107 415.489.2224 TEL 415.358.9100 FAX WWW.WRNSSTUDIO.COM

Steinberg Architects







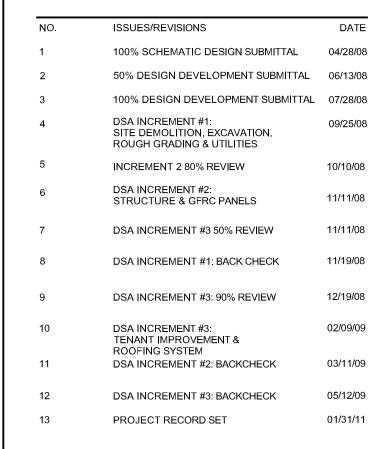

PROJECT RECORD SET

SKYLINE COLLEGE CIP2 DESIGN-BUILD BUILDING 4N

PROJECT NO.: DRAWN BY: WAC

DATE: 01/31/11 CHECKED BY: APA


SCALE: NONE

SECTIONS AND ELEVATIONS

SHEET NO:

SHEET TITLE:

TA-401

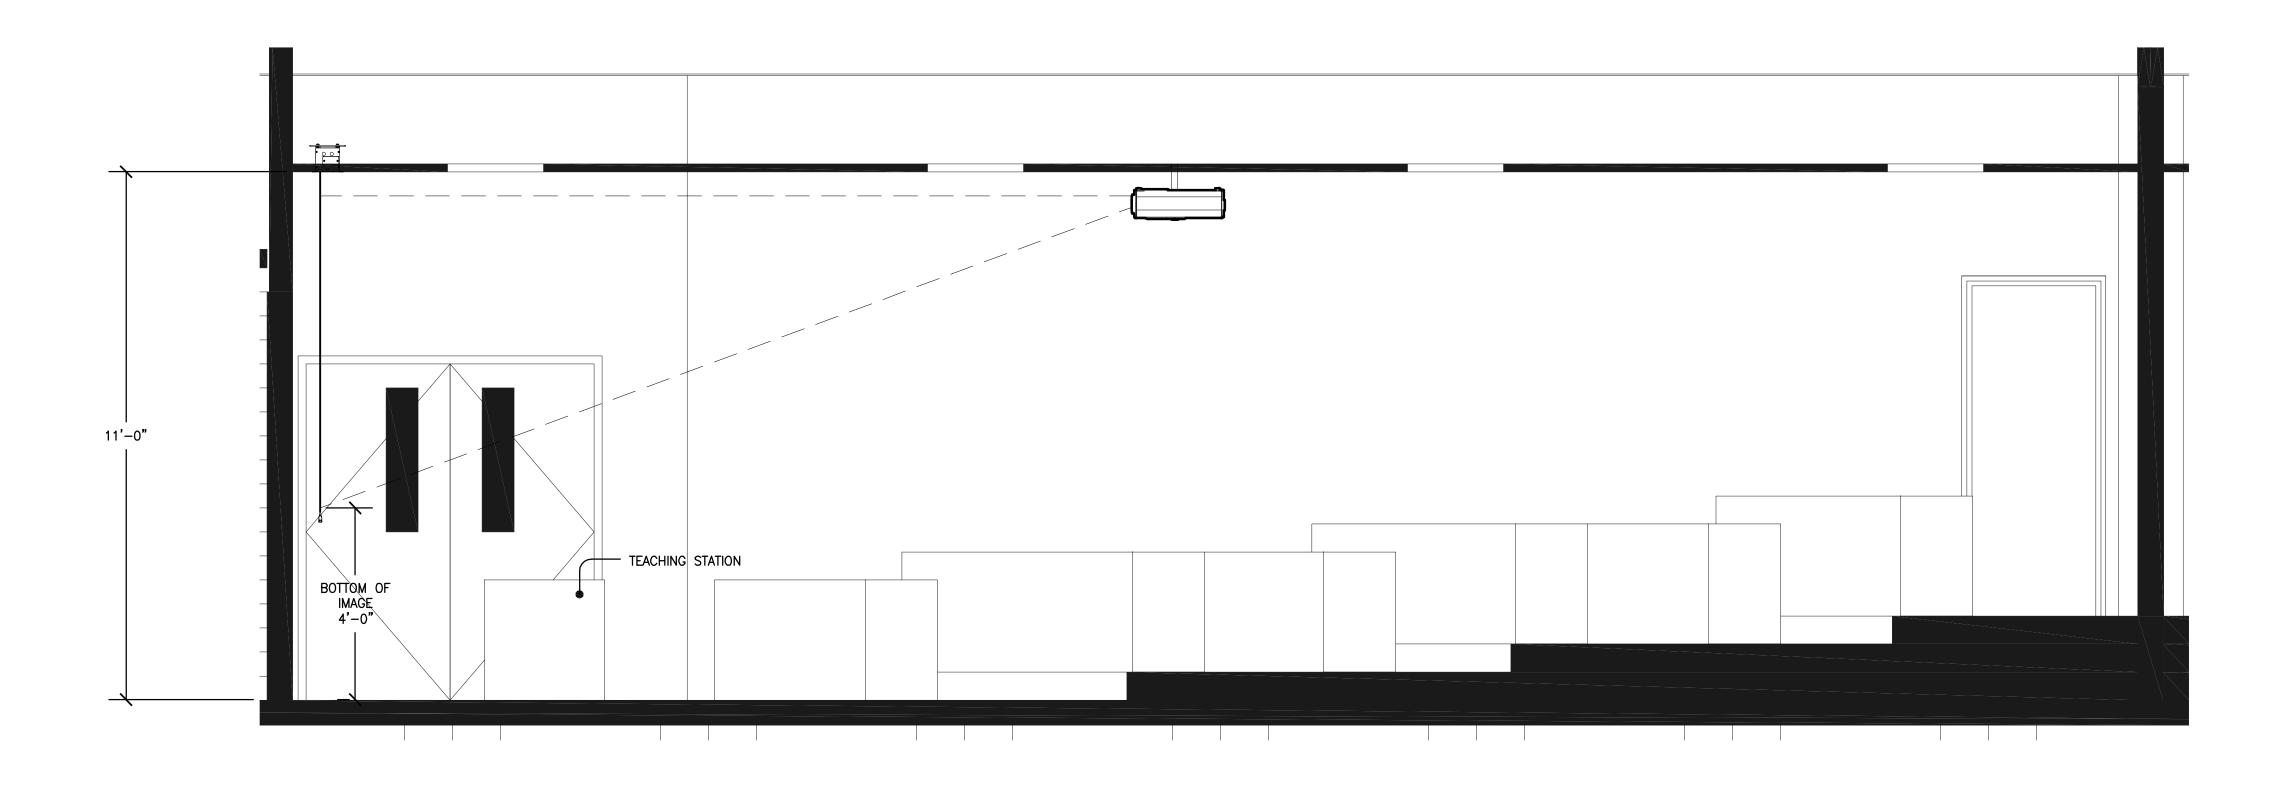


LARGE CLASSROOM - SECTION SCALE: 1/2" = 1'-0"

16-2°

LARGE CLASSROOM - SCREEN ELEVATION SCALE: 1/2" = 1'-0"


All drawings and written material appearing herein constitute original and unpublished work of the Architect/Engineer and may not be duplicated, used or disclosed without consent of Architect/Engineer.

If this drawing is not 30"x42", then the drawing has been revised from its original size. Noted scales must be adjusted. This line should be equal to one inch

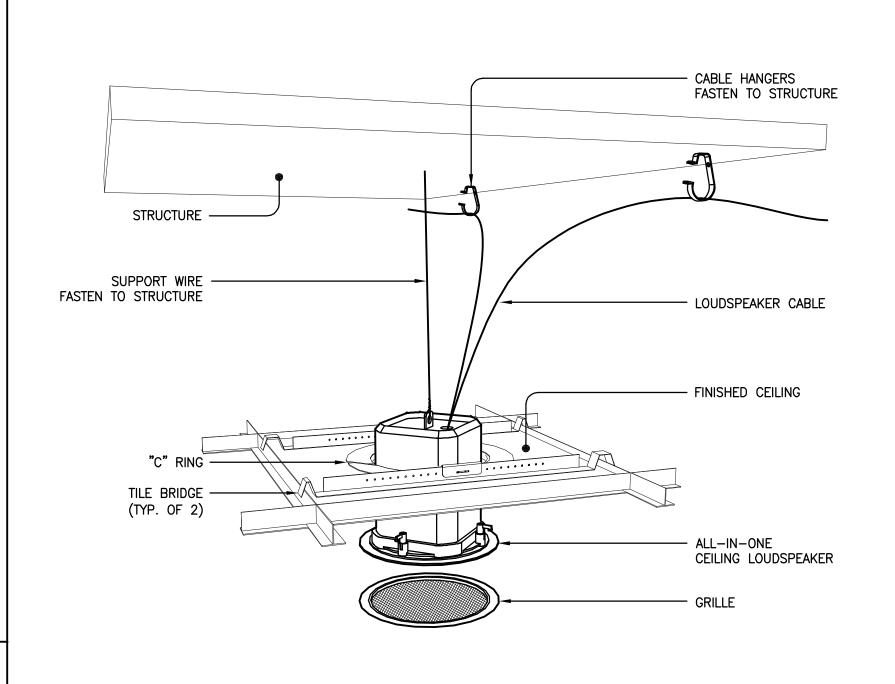

NOTE: SEE SHEET TA-502 FOR STRUCTURAL DETAILS APPLICABLE TO SYMBOL: (S)


CEILING MOUNTED LOUDSPEAKER - ATC 1 SCALE: NTS

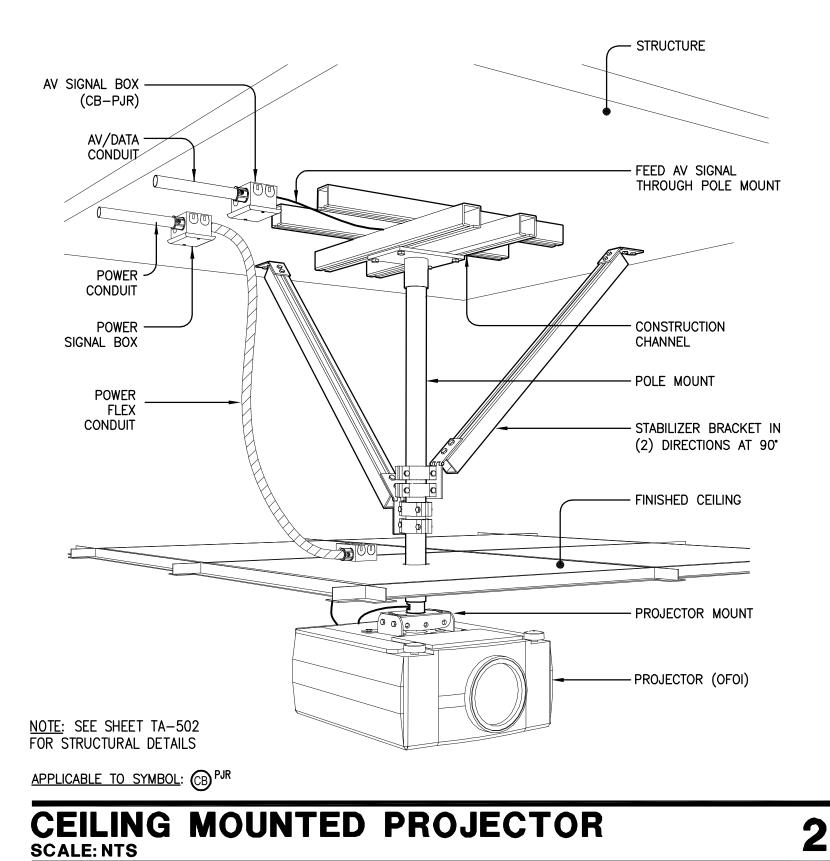

— ATTACH
PROJECTION SCREEN
TO STRUCTURE STRUCTURE POWER CONDUIT - FINISHED CEILING POWER SIGNAL BOX PROJECTION SCREEN HOUSING PROJECTION SCREEN

APPLICABLE TO SYMBOL:


MOTORIZED PROJECTION SCREEN SCALE: NTS

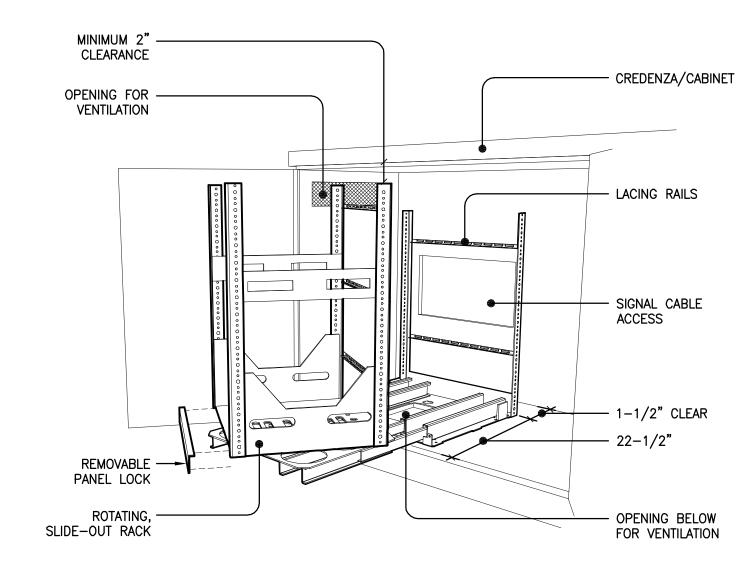


NOTE: INSIDE CLEAR DIMENSIONS OF CREDENZA/CABINET A MINIMUM OF 24" DEEP AND 19-1/4" WIDE. HEIGHT DIMENSION WILL DEPEND ON FINAL EQUIPMENT COUNT PLUS 4". SEE INSTALLATION MANUAL FOR SPECIFIC INFORMATION.

APPLICABLE TO SYMBOL:

SLIDE-OUT AV EQUIPMENT RACK SCALE: NTS

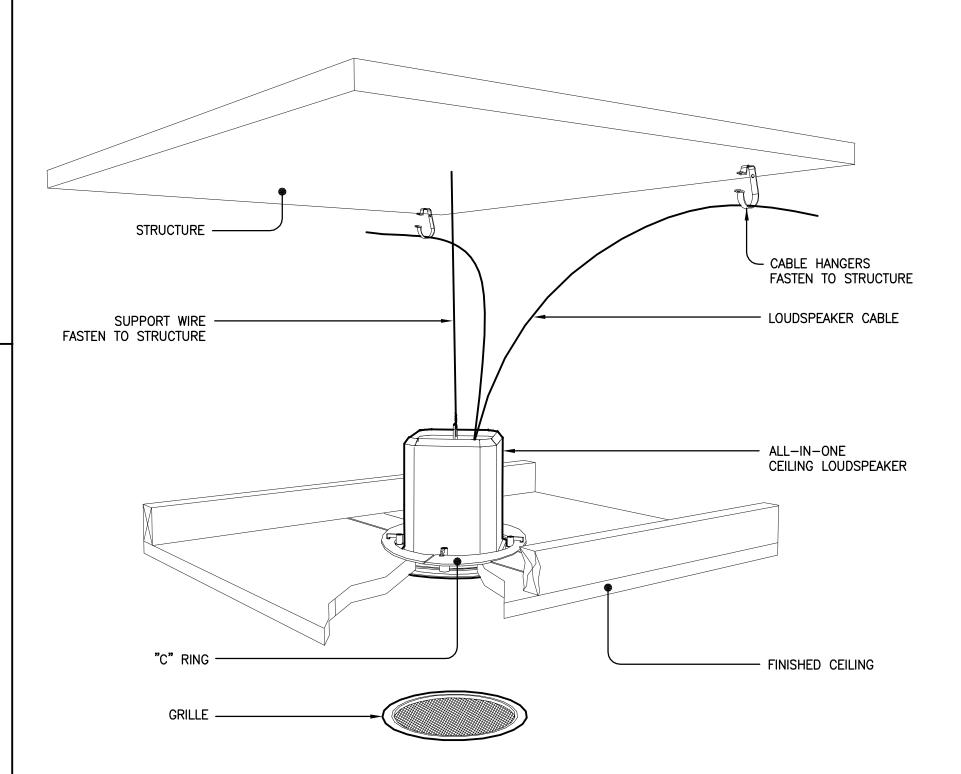


NOTE: SEE SHEET TA-502 FOR STRUCTURAL DETAILS APPLICABLE TO SYMBOL: S CEILING MOUNTED LOUDSPEAKER - GYP 5

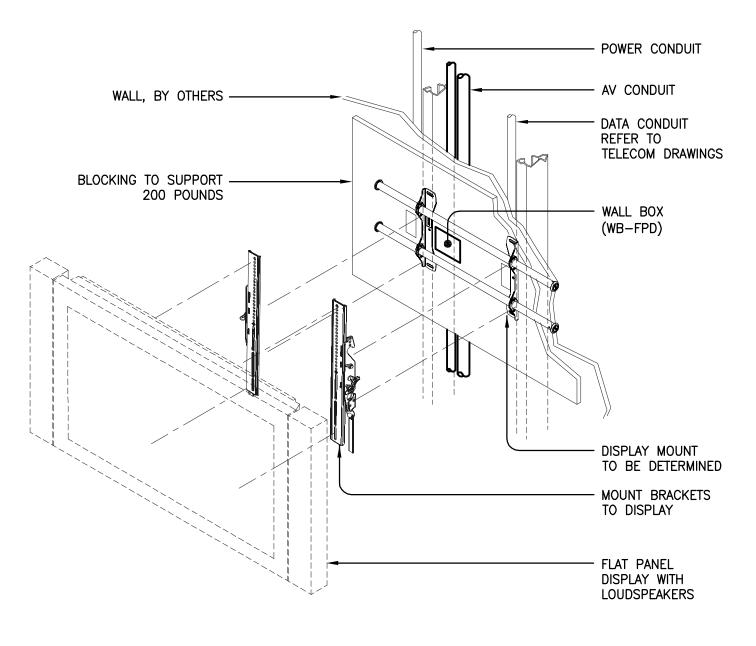


NOTE: SEE SHEET TA-502 FOR STRUCTURAL DETAILS APPLICABLE TO SYMBOL: | WB FPD

WALL MOUNTED FLAT PANEL DISPLAY
SCALE: NTS

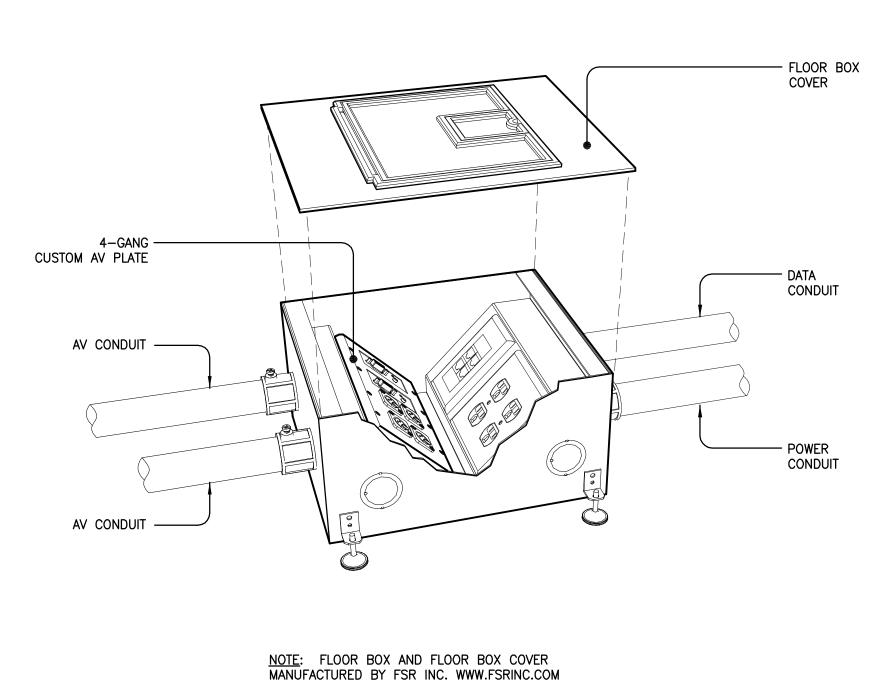

APPLICABLE TO SYMBOL: FB


FLOOR BOX SCALE: NTS

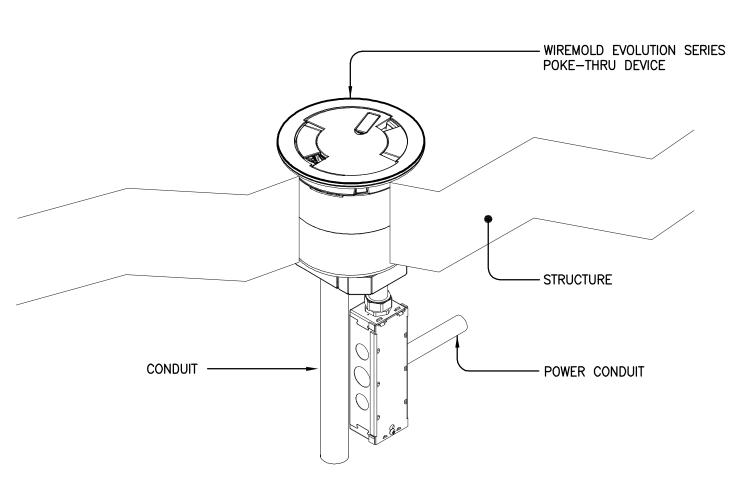

NOTE: POKE-THRU DEVICE AND COVER MANUFACTURED BY WIREMOLD WWW.WIREMOLD.COM/EVOLUTION

APPLICABLE TO SYMBOL: PT

POKE-THRU SCALE: NTS

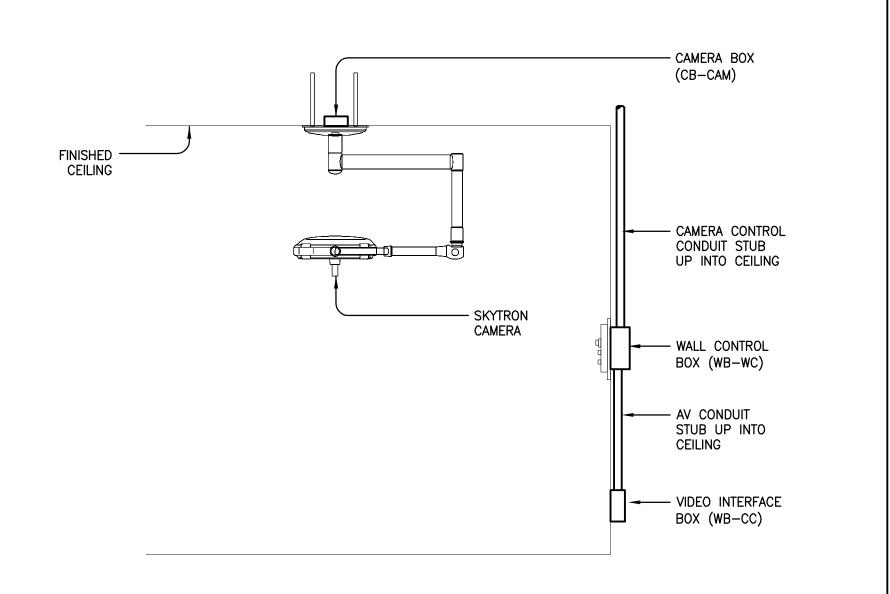

APPLICABLE TO SYMBOL: (CB CAM HWB WC HWB CC

SKYTRON CAMERA

WRNSSTUDIO

501 SECOND STREET 4TH FLOOR, STE. 402 SAN FRANCISCO **CALIFORNIA 94107** 415.489.2224 TEL 415.358.9100 FAX WWW.WRNSSTUDIO.COM

Steinberg Architects







| NO. | ISSUES/REVISIONS | DATE |
|-----|--|----------|
| 1 | 100% SCHEMATIC DESIGN SUBMITTAL | 04/28/08 |
| 2 | 50% DESIGN DEVELOPMENT SUBMITTAL | 06/13/08 |
| 3 | 100% DESIGN DEVELOPMENT SUBMITTAL | 07/28/08 |
| 4 | DSA INCREMENT #1: SITE DEMOLITION, EXCAVATION, ROUGH GRADING & UTILITIES | 09/25/08 |
| 5 | INCREMENT 2 80% REVIEW | 10/10/08 |
| 6 | DSA INCREMENT #2: STRUCTURE & GFRC PANELS | 11/11/08 |
| 7 | DSA INCREMENT #3 50% REVIEW | 11/11/08 |
| 8 | DSA INCREMENT #1: BACK CHECK | 11/19/08 |
| 9 | DSA INCREMENT #3: 90% REVIEW | 12/19/08 |
| 10 | DSA INCREMENT #3: TENANT IMPROVEMENT & | 02/09/09 |
| 11 | ROOFING SYSTEM DSA INCREMENT #2: BACKCHECK | 03/11/09 |
| 12 | DSA INCREMENT #3: BACKCHECK | 05/12/09 |
| 13 | PROJECT RECORD SET | 01/31/11 |
| | | |


PROJECT RECORD SET


SKYLINE COLLEGE CIP2 DESIGN-BUILD **BUILDING 4N**


PROJECT NO.: CHECKED BY: APA DATE: 01/31/11 SCALE: NONE SHEET TITLE:

AUDIOVISUAL **DETAILS**

SHEET NO:

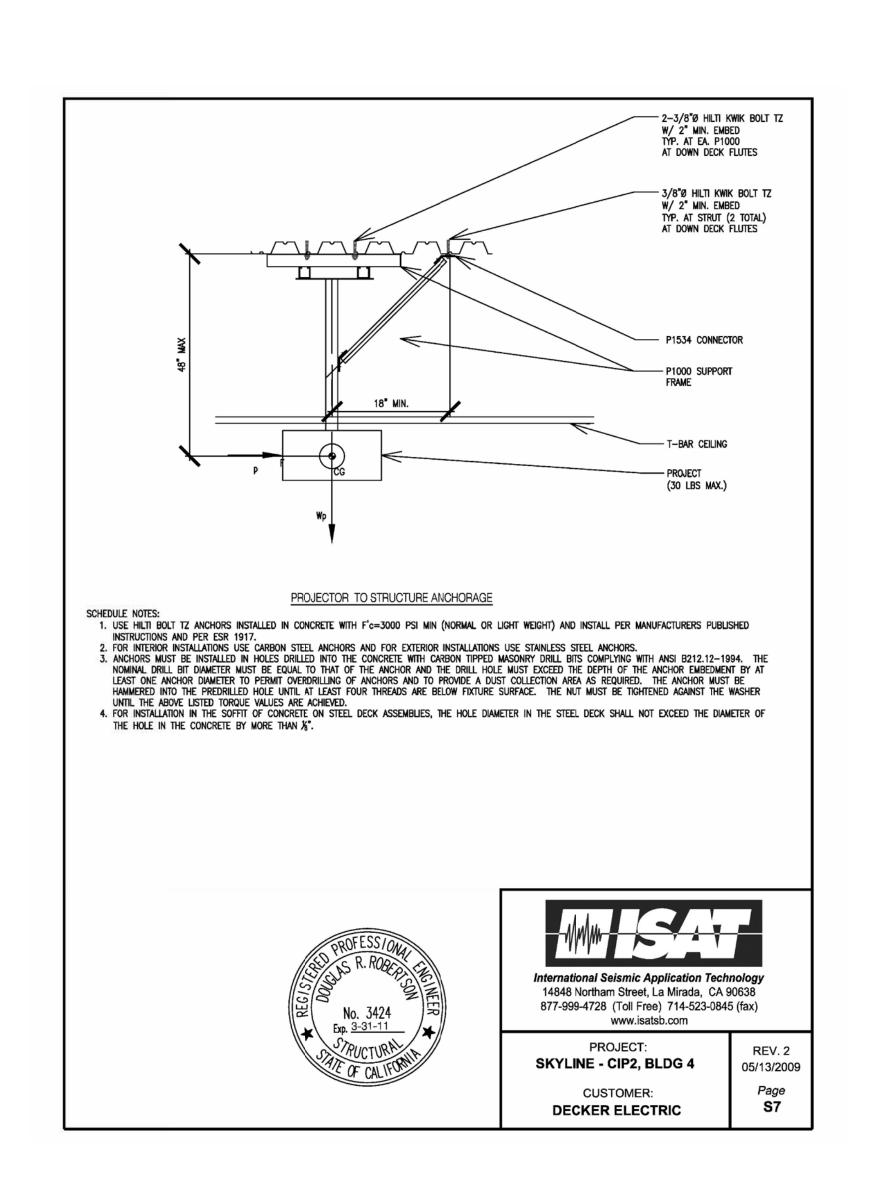

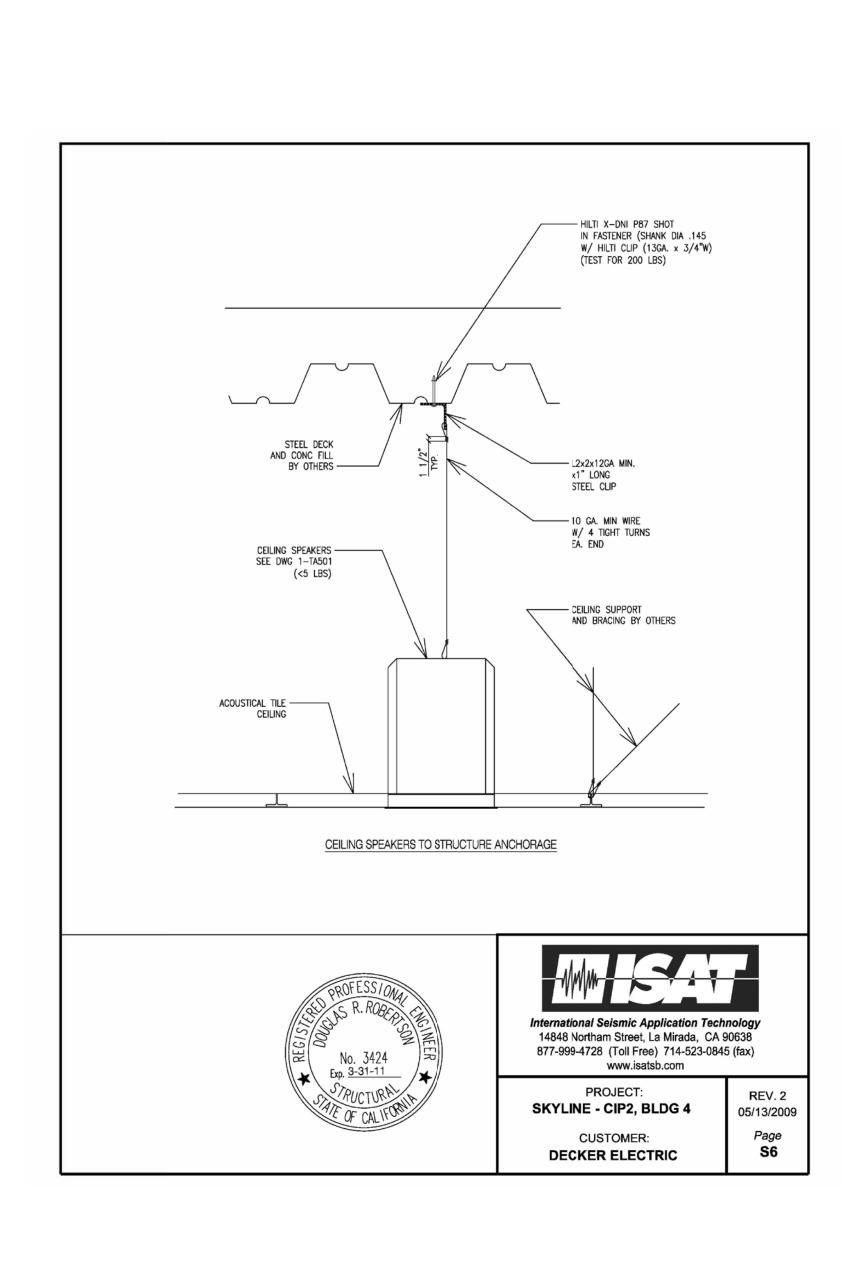

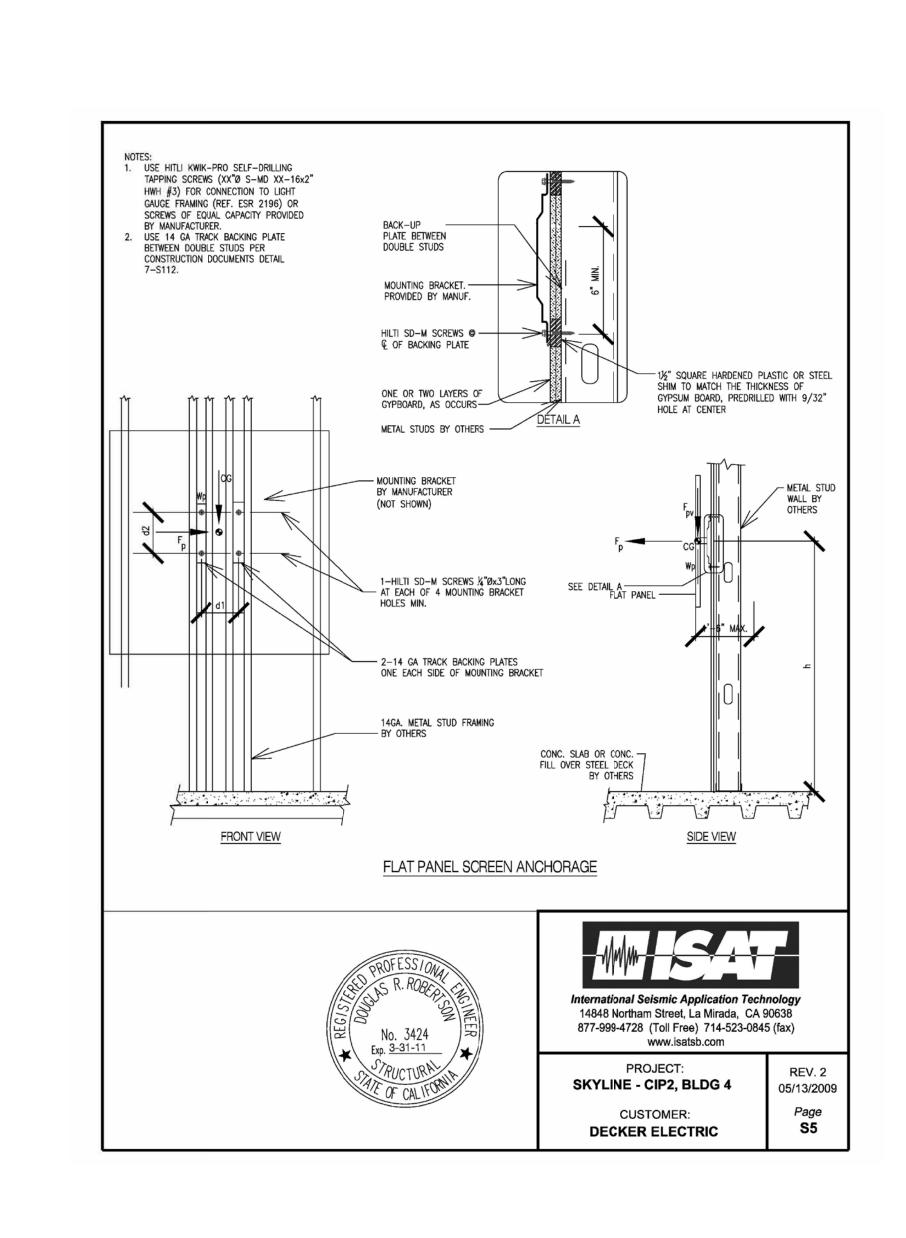

WRNSSTUDIO

501 SECOND STREET 4TH FLOOR, STE. 402 SAN FRANCISCO **CALIFORNIA 94107** 415.489.2224 TEL 415.358.9100 FAX WWW.WRNSSTUDIO.COM

Steinberg Architects







| NO. | ISSUES/REVISIONS | DAT |
|-----|--|---------|
| 1 | 100% SCHEMATIC DESIGN SUBMITTAL | 04/28/0 |
| 2 | 50% DESIGN DEVELOPMENT SUBMITTAL | 06/13/0 |
| 3 | 100% DESIGN DEVELOPMENT SUBMITTAL | 07/28/0 |
| 4 | DSA INCREMENT #1: SITE DEMOLITION, EXCAVATION, ROUGH GRADING & UTILITIES | 09/25/0 |
| 5 | INCREMENT 2 80% REVIEW | 10/10/0 |
| 6 | DSA INCREMENT #2: STRUCTURE & GFRC PANELS | 11/11/0 |
| 7 | DSA INCREMENT #3 50% REVIEW | 11/11/0 |
| 8 | DSA INCREMENT #1: BACK CHECK | 11/19/0 |
| 9 | DSA INCREMENT #3: 90% REVIEW | 12/19/0 |
| 10 | DSA INCREMENT #3: TENANT IMPROVEMENT & ROOFING SYSTEM | 02/09/0 |
| 11 | DSA INCREMENT #2: BACKCHECK | 03/11/0 |
| 12 | DSA INCREMENT #3: BACKCHECK | 05/12/0 |
| 13 | PROJECT RECORD SET | 01/31/1 |
| | | |

PROJECT **RECORD SET**

SKYLINE COLLEGE CIP2 DESIGN-BUILD **BUILDING 4N**

PROJECT NO.:

DATE: 01/31/11 SCALE: NONE SHEET TITLE:

AUDIOVISUAL **DETAILS**

CEILING MOUNTED PROJECTOR SCALE: NTS

CEILING MOUNTED LOUDSPEAKER
SCALE: NTS

WALL MOUNTED FLAT PANEL DISPLAY
SCALE: NTS

SHEET NO: