



SEE TYPICAL CLASSROOM LAYOUT FOR LOCATIONS OF ALL DEVICES. FIXTURE MOUNTING SHALL COMPLY WITH CALIFORNIA SEISMIC REGULATIONS.

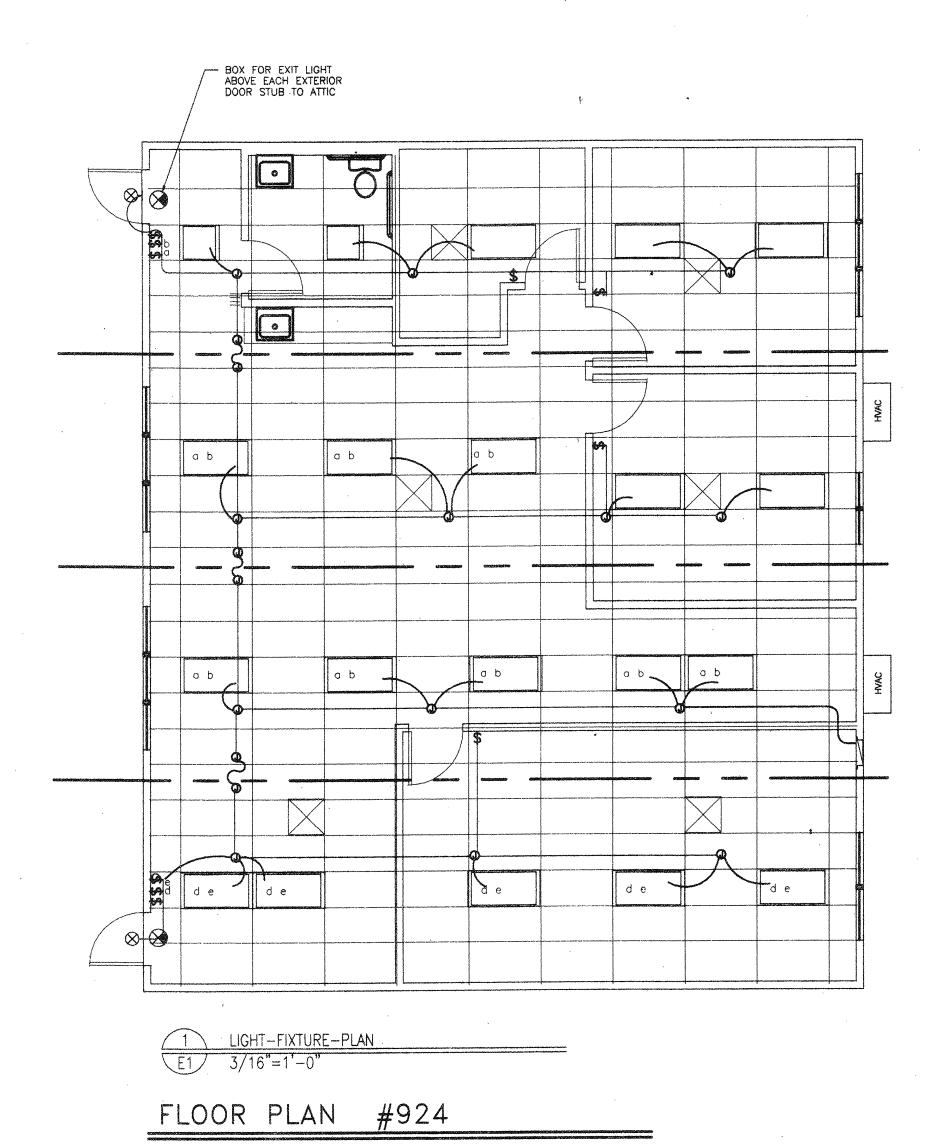

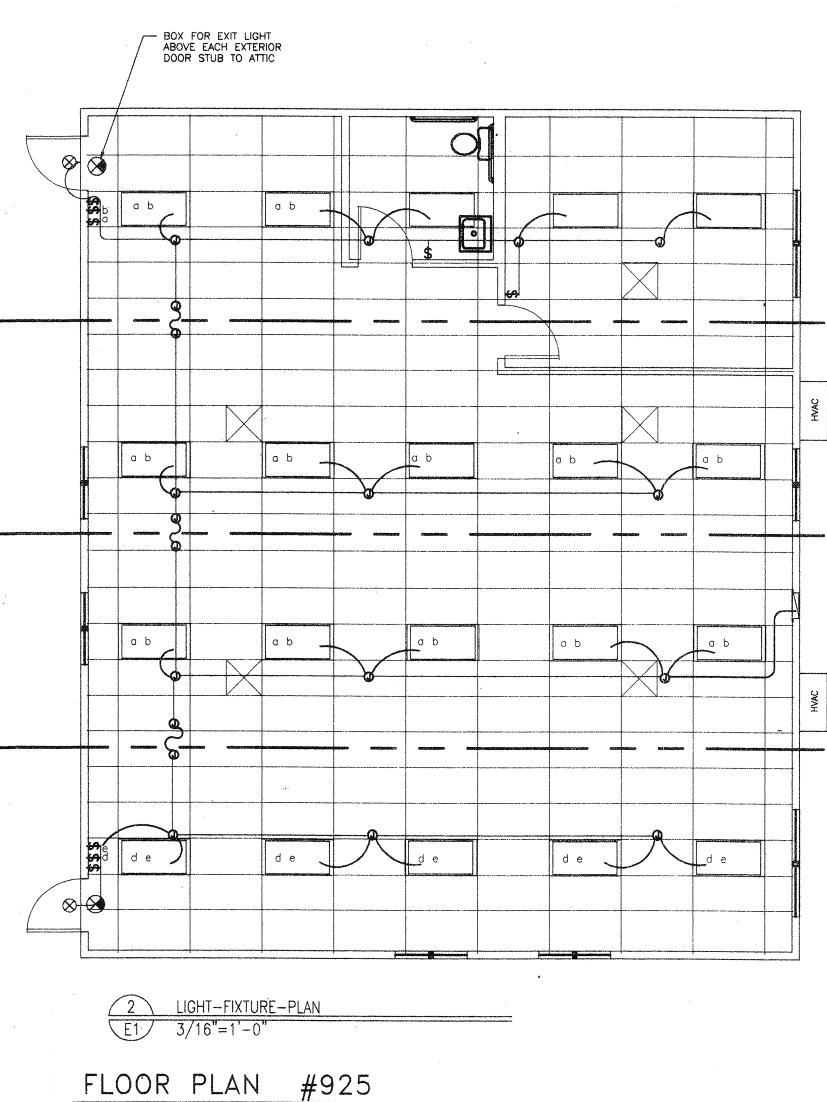

NOTE: #926 MIRROR OF #925

STANDARD ELECTRICAL SYMBOLS

FIRE ALARM STATION - OUTLET ONLY, 4" SQ. BOX W/ SINGLE DEVICE RING AND COVER +48"CENTERLINE FIRE ALARM HORN - OULET ONLY - 4" SQ.

BOX W/ SINGLE DEVICE RING AND COVER +90" A.F.F. AND NOT LESS THAN 6" BELOW FINISHED CEILING. FIRE ALARM VISUAL ALARM- OUTLET ONLY - 4" SQ.

SPEAKER- OUTLET ONLY - 4" SQ. BOX W/ SINGLE

A.F.F. BUT NO GREATER THAN +96".

SINGLE DEVICE RING AND COVER +48"

DEVICE RING AND COVER +84"

BOX W/ SINGLE DEVICE RING AND COVER BOTTOM +80".

INTERCOM TELEPHONE- OUTLET ONLY- 4" SQ. BOX W/

FIRE ALARM MINI HORN/STROBE - OULET ONLY - 4" SQ. BOX W/ SINGLE DEVICE RING AND COVER +80" MIN. AND NOT LESS THAN 6" BELOW FINISHED CEILING.

FLUORESCENT LIGHTING FIXTURE - SURFACE MOUNTED. FLUORESCENT LIGHTING FIXTURE - RESCESSED. WIRE HANGER (TYP.) H.P.S. LIGHTING FIXTURE - WALL MOUNTED (EXTERIOR) (NOT T-BAR GRID SUPPORT) INCANDESCENT LIGHTING FIXTURE - WALL MOUNTED (INTERIOR). 12 GA. (4) TOTAL ATTACHED TO FRAMING ABOVE, SEE SHT ; DUPLEX WALL CONVENIENCE OUTLETS +18" TO CENTER LINE. SINGLE POLE LIGHT SWITHCES +48", HUBBELL PREMIUM, BRYANT HEAVY DUTY, OR LEVITON SPECIFICATIONS GRADE. ELECTRICAL CROSSOVER J-BOXES ABOVE T-BAR CEILING #1-4"X1",#22 4"X2 " WALL CLOCK OUTLET WITH POWER OUTLET +84". SWITCH SUBSCRIPTS - a=DEVICE CONTROLLED. 15 AMP DUPLEX RECEPTACLE +18" TO CENTER LINE. FIXTURE TAB (3) JUNCTION BOX - SIZE AND TYPE AS REQUIRED. TIGHT TURNS WITHIN-PANELBOARD - SEE SCHEDULE. 1 1/2" (TYP. EA. CRNR) TERMINAL CABINET - SIZE AND TYPE AS NOTED. CONDUIT CONCEALED IN CEILING OR WALL. CONDUIT CONCEALED BELOW FLOOR OR GRADE. HOMERUN TO RESPECTIVE PANEL TO TERMINAL. INDICATES 1#14 (GREEN) GROUND WIRE, OTHER SIZES AS INDICATED. BRANCH CIRCUIT WITHOUT FURTHER DESIGNATION IS A 2#14 WIRE CIRCUIT, FOR MORE THAN 2#14 WIRES AS FOLLOWS, -#1 3#14, -- HII- 4#14 ETC. FOR OTHER SIZES AS FOLLOWS, -- 3#10, -- 4#6 ETC. FIXTURE IDENTIFICATION - LETTER INDICATES TYPE. #8 S.M.S. EA. ABBREV. FOR NOT IN ELECTRICAL SECTION OF THESE PLANS AND SPEC'S. PROVIDE WIRE HANGERS AND E.Q. CLIPS ABBREV. FOR EMPTY CONDUIT WITH POLY PULL CORD. AS REQUIRED BY CALIFORNIA SEISMIC SUPPORT FUSED DISCONNECT SWITCH SIZE AS REQUIRED. PROVIDE REGULATIONS CBC 2501.A.5 & IR. M-3 DETAIL FUSES AS RECOMMENDED BY EQUIPMENT SUPPLIER. [W.E.F.] WALL MOUNTED EXHAUST FAN N.I.E.S. CONNECT AS REQUIRED. 50 AMP 250 VOLT RANGE RECEPTACLE.

VOLTS: 120/240 SINGLE PHASE PANEL: A

ELECTRICAL PANEL -RELOCATABLE MANUF. SHALL PROVIDE STUB ONLY ALL ITEMS BEYOND BY OTHERS PANEL BONDED TO GROUND CONDUCTOR RIGID CONDUIT W/ TO WALL W/2-HOLE STRAPS BY OTHERS -TEE CONDUIT FOR SEPARATE CONDUCTOR GROUND BONDED TO METAL BUILDING FRAME GROUND CLAMP METAL BUILDING FRAME -1/2" DIA. X 8' LONG COPPERCLAD GROUND ROD OR OTHER ELECTRODE AS SPECIFIED IN C.E.C. BY OTHERS - GROUND CLAMP BY OTHERS GROUND ROD BOX BY OTHERS Size of conductors shall comply W/CEC Table Bond separate conductors from ground rod to electrical panel & metal building frame. In addition to the detail shown above, bond the

electrical ground to metal water pipe embedded @ least 10'

Electrical bond modules together W/#8 CU @ modline. By manufacturer. Check resistance to ground. If resistance

exceeds 25 OHMS, install additional ground rods as required. Grounding detail per DSA I—R M—5.

into the soil if available.

The I.O.R. must wittness the test.

BUILDING GROUND DETAIL

WATTS BRK. C A B C BRK. WATTS LOAD LIGHTS, FLUORESCENT DUPLEX RECEPT. LIGHTS, FLUORESCENT DUPLEX RECEPT. DUPLEX RECEPT. DUPLEX RECEPT. DUPLEX RECEPT SPARE 5760 5760 PHASE WATTAGE TOTAL WATTS "A"LEG: 9220 TOTAL WATTS A+B= 18910 TOTAL WATTS "B" LEG 9690 TOTAL WATTS: 18910 86 AMPS 120/240V SINGLE PHASE FEEDERS: TO BE RUN BY THE DISTRICT EITHER UNDERGROUND OR OVERHEAD, SEE SITE ELEC. PLAN.

MAIN: 200 AMP MAIN BKR. LOCATION: INTERIOR MOUNTING: FLUSH

ELECTRICAL DISTRIBUTION PLAN 1/4" = 1'-0"

> // No. 2310 IDENTIFICATION STAMP DIV. OF THE STATE ARCHITECT OFFICE OF REGULATION SERVICES

FEED: EXTERIOR LB

STUB OUT LOCATIONS FOR ELECTRICAL PANEL, FIRE ALARM, AND DATA BOXES. LOCATIONS SHOWN ARE DIAGRAMITICAL ONLY EXACT LOCATIONS MAY VARY +/- SEVERAL FEET. PLEASE CONTACT AMERICAN MODULAR SYSTEMS FOR EXACT LOCATIONS.

P 24501-50

BASED ON PC# 02-101835

48 X 40 PC RELOCATABLE CLASSROOMS



CUSTOMER: MOBILE MODULAR MANAGEMENT CORP. #924-#926

ELECTRICAL & LIGHTING PLAN & NOTES

E1

DATE: 01-03-01 SCALE: NONE DRAWN BY: CHECKED BY: CHECKED BY: SERIAL NO.

REVISIONS NO DATE DESCRIPTION NO DATE DESCRIPTION

PROJECT No. SHEET No.