### Abbreviations

)	EXISTING
	AMPERES, AMBER

AIC AVAILABLE INTERRUPTING CAPACITY

AWG AMERICAN WIRE GAUGE

C CONDUIT, CLOSE, CONTROL

CB CIRCUIT BREAKER

CLG CEILING

COORD COORDINATE

CU COPPER

DIM DIMENSION

DWG DRAWING

EA EACH

FT FOOT, FEET

G, GND

GROUND

GFCI GROUND FAULT CIRCUIT INTERRUPTER

GFI GROUND FAULT INTERRUPTER

HT HEIGHT

IN INCH, INCHES

KVA KILOVOLT AMPERES

KW KILOWATT

LED LIGHT EMITTING DIODE

MIN MINIMUM

MT, MTD MOUNT, MOUNTED

N/A NOT APPLICABLE

NEC NATIONAL ELECTRIC CODE

NEMA NATIONAL ELECTRICAL MANUFACTURERS ASSOCIATION

NTS NOT TO SCALE

OC ON CENTER

REQD REQUIRED

RM ROOM

SHT SH

TYP TYPICAL

UNDERWRITERS LABORATORIES

JON UNLESS OTHERWISE NOTED

V VOLTS, VOLTAGE

WITHOUT

SWITCH

W/ WITH

**Connections / Equipment** 

① OR ① JUNCTION BOX

<u>General</u>

 $\begin{pmatrix} X \\ X \end{pmatrix}$ 

DETAIL NUMBER AND SHEET LOCATION

**KEYED NOTE** 

#### Miscellaneous

BRANCH CIRCUIT WIRING. ARROW INDICATES HOME RUN TO PANEL WITH CIRCUITS AS NOTED. WIRE SIZE IS #12 AWG MINIMUM UNLESS NOTED OTHERWISE. SHORT TICK MARKS INDICATE PHASE CONDUCTORS. LONG TICK MARKS INDICATE NEUTRAL CONDUCTORS. A SINGLE CURVED TICK MARK INDICATES INSULATED GREEN GROUND CONDUCTOR. SECOND CURVED TICK MARK INDICATES "ISOLATED GROUND" (GREEN INSULATION WITH YELLOW STRIPE) CONDUCTOR.

BRANCH PANEL

FLUSH WALL MOUNTED BRANCH PANEL

**GROUNDING POINT** 

Raceways

CONDUIT/WIRING CONTINUATION

─∃ CONDUIT/W BUSHING

CONDUIT/WIRING STUBBED OUT WITH END CAP OR INSULATED PLASTIC BUSHING

#### **Switches and Receptacles**

DUPLEX RECEPTACLE

### **GENERAL ELECTRICAL NOTES**

- A. DO NOT COMMENCE INSTALLATION OF ELECTRICAL SYSTEMS AND EQUIPMENT WITHOUT RELATED SHOP DRAWING APPROVALS.
- B. ELECTRICAL CIRCUITS SHALL BE INTERRUPTED ONLY WITH PRIOR WRITTEN CONSENT. SUCH INTERRUPTIONS SHALL BE PRECEDED BY ALL POSSIBLE PREPARATIONS BY THE CONTRACTOR WHICH ARE NECESSARY TO KEEP THE ELECTRICAL CIRCUITS OFF FOR A MINIMUM PERIOD IN AN EXPEDITIOUS MANNER PURSUANT WITH GOOD WORKMANSHIP. THIS INCLUDES CIRCUIT TRACING TO IDENTIFY THE ELECTRICAL LOAD BEING SERVED AND THE ORIGIN OF THE CIRCUIT.
- C. COORDINATE WITH OWNER SO THAT WORK CAN BE SCHEDULED NOT TO INTERRUPT OPERATIONS, NORMAL ACTIVITIES, BUILDING ACCESS, ACCESS TO DIFFERENT AREAS. THE OWNER WILL COOPERATE TO THE BEST OF THEIR ABILITY TO ASSIST IN A COORDINATED SCHEDULE, BUT WILL REMAIN THE FINAL AUTHORITY AS TO TIME OF WORK PERMITTED.
- D. COORDINATE THE EXACT LOCATION OF EXISTING UTILITIES AND EQUIPMENT PRIOR TO COMMENCEMENT OF WORK. COMPENSATE THE OWNER FOR DAMAGES CAUSED BY THE FAILURE TO LOCATE AND PRESERVE UTILITIES. REPLACE DAMAGED ITEMS WITH NEW MATERIAL TO MATCH EXISTING.
- E. REMOVE EXISTING LUMINAIRES, SWITCHES, RECEPTACLES, AND OTHER ELECTRICAL EQUIPMENT AND DEVICES AND ASSOCIATED WIRING FROM WALLS, CEILINGS, FLOORS, AND OTHER SURFACES SCHEDULED FOR REMODELING, RELOCATION, OR DEMOLITION UNLESS SHOWN AS RETAINED OR RELOCATED ON DRAWINGS
- F. MAINTAIN ELECTRICAL CONTINUITY OF EXISTING SYSTEMS. REMOVE OR RELOCATE ELECTRICAL BOXES, CONDUIT, WIRING, EQUIPMENT, LUMINAIRES, AND THE LIKE, AS REQUIRED IN REMOVED OR REMODELED AREAS IN THE EXISTING CONSTRUCTION AFFECTED BY THIS WORK.
- G. REMOVE AND RESTORE WIRING WHICH SERVES USABLE EXISTING OUTLETS CLEAR OF THE CONSTRUCTION OR DEMOLITION.
- H. IF EXISTING JUNCTION BOXES WILL BE MADE INACCESSIBLE, OR IF ABANDONED OUTLETS SERVE AS FEED THROUGH BOXES FOR OTHER EXISTING ELECTRICAL EQUIPMENT WHICH IS BEING RETAINED, PROVIDE NEW CONDUIT AND WIRE TO BYPASS THE ABANDONED OUTLETS.
- I. IF EXISTING CONDUITS PASS THROUGH PARTITIONS OR CEILING WHICH ARE BEING REMOVED OR REMODELED, PROVIDE NEW CONDUIT AND WIRE TO REROUTE CLEAR OF THE CONSTRUCTION OR DEMOLITION AND MAINTAIN SERVICE TO THE EXISTING LOAD.
- J. CONCEALED CONDUIT LOCATED IN CONCRETE WALLS OR HARDBOARD CEILING SPACES MAY BE ABANDONED IN PLACE. REMOVE CONDUCTORS AND TAG ABANDONED CONDUITS WITH CORRESPONDING SYSTEM AND TERMINATION POINT. CUT AND CAP ABANDONED CONDUIT. DO NOT EXTEND STUBS ABOVE FINISHED FLOOR.
- K. EXTEND CIRCUITING AND DEVICES IN EXISTING WALLS TO BE FURRED OUT.
- L. PROVIDE TEMPORARY SUPPORT FOR ELECTRICAL SYSTEMS THAT REMAIN IN PLACE.
- M. VERIFY EXACT LOCATION AND NUMBER OF EXISTING ELECTRICAL OUTLETS AND LUMINAIRES IN THE FIELD. LOCATIONS OF ITEMS SHOWN ON DRAWINGS AS EXISTING ARE PARTIALLY BASED ON RECORD AND OTHER DRAWINGS WHICH MAY CONTAIN ERRORS. VERIFY THE ACCURACY OF THE INFORMATION SHOWN PRIOR TO BIDDING AND PROVIDE SUCH LABOR AND MATERIAL AS IS NECESSARY TO ACCOMPLISH THE INTENT OF THE CONTRACT DOCUMENTS.
- N. REMOVE ABANDONED WIRING TO LEAVE SITE CLEAN.
- O. EXISTING LIGHTING WHICH IS TO REMAIN OR BE RELOCATED IS TO BE RELAMPED, REBALLASTED, AND CLEANED. LEAVE ALL LUMINAIRES IN PROPER WORKING ORDER. REPLACE DAMAGED OR BROKEN LENS AND/OR COMPONENTS.
- P. MAINTAIN ACCESS TO EXISTING ELECTRICAL INSTALLATIONS WHICH REMAIN ACTIVE. MODIFY INSTALLATION OR PROVIDE ACCESS PANEL AS APPROPRIATE.
- Q. WHERE DRAWINGS INDICATE EXISTING ELECTRICAL EQUIPMENT OR DEVICES TO BE RELOCATED AND/OR REUSED, REFURBISH THEM. THOROUGHLY CLEAN SUCH ITEMS. NOTIFY ARCHITECT OF ANY DEFECTS IN SUCH INSTALLATIONS. REPAIR ANY DAMAGE CAUSED BY DEMOLITION OR CONSTRUCTION PERFORMED UNDER THIS CONTRACT.
- R. PROVIDE UPDATED PANEL SCHEDULES AND DIRECTORIES THAT IDENTIFY EXISTING CIRCUITS AND NUMBER OF SPARE CIRCUITS AVAILABLE UPON COMPLETION OF DEMOLITION WORK.
- S. OFFER REMOVED LUMINAIRES, WIRING DEVICES, PANELBOARDS AND EQUIPMENT TO THE OWNER. IF OWNER CHOOSES TO RETAIN THESE ITEMS, RETURN SUCH ITEMS TO OWNER. CAREFULLY REMOVE AND DISPOSE OF ITEMS REJECTED BY OWNER FROM PROJECT SITE AND IN A LEGAL MANNER.
- T. RECONNECT EXISTING LUMINAIRES NOT SHOWN ON DRAWINGS AND AFFECTED DUE TO DEMOLITION TO NEAREST AVAILABLE EXISTING LIGHTING CIRCUIT ABLE TO TAKE THE ADDITIONAL LOAD.
- U. REFER TO SPECIFICATIONS FOR ADDITIONAL REQUIREMENTS.
- V. DRAWINGS AND SPECIFICATIONS COMPLIMENT EACH OTHER. REQUIREMENT BY EITHER INFERS REQUIREMENT BY BOTH.
- W. CONNECT EQUIPMENT AND DEVICES FURNISHED UNDER OTHER DIVISIONS OF THIS CONTRACT, BY OWNER OR BY OTHER CONTRACTS.
- X. UNLESS OTHERWISE NOTED, PROVIDE CONCEALED AND FLUSH MOUNTED INSTALLATION OF DEVICES AND EQUIPMENT IN AREAS.
- Y. PROVIDE SEPARATE EQUIPMENT GROUNDING CONDUCTOR IN 120 VOLT, MULTI-WIRE CIRCUITS.
- Z. FOR 120 VOLT, 20 AMP CIRCUITS, WHERE CIRCUIT DISTANCE FROM PANELBOARD TO FARTHEST DEVICE/FIXTURE EXCEEDS 75 FEET, PROVIDE #10 SIZE CONDUCTOR.
- AA. RUN ELECTRICAL CONDUIT CONCEALED AND PARALLEL TO BUILDING LINES. VERIFY WITH ARCHITECT.
- AB. RECEPTACLE OUTLETS SHALL COMPLY WITH CEC SECTION 210.7.
- AC. LIGHTS, SWITCHES AND CONTROL MECHANISMS SHALL COMPLY WITH CEC SECTION 404.
- AD. BRACE ELECTRICAL EQUIPMENT TO RESIST A HORIZONTAL FORCE THAT ACT IN ANY DIRECTION. COMPLY WITH TITLE 24 REQUIREMENTS.
- AE. INSTALL COMPLETE SYSTEM OF CONDUCTORS IN RACEWAY SYSTEM THROUGHOUT BUILDING FOR FEEDERS, BRANCH CIRCUITS, ETC.

## SHEET INDEX

- E0.1 SYMBOL LIST AND GENERAL NOTES ELECTRICAL
- E2.1 FLOOR PLAN LIGHTING
- E2.2 LIGHTING CONTROL FLOOR PLANS



PROJECT 2014-0380

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COLLEGE OF SAN MATEO DUSE LIGHTING RETROFIT SAN MATEO - BUILDING 3

SAN MATEO COUNTY

CAÑADA/

THEATER P

SHEET TITLE
THEATER HOUSE
LIGHTING RETROFIT
SYMBOL LIST AND
GENERAL NOTES
- ELECTRICAL

REVISIONS

SCALE: NO SCALE DATE: Sept. 9, 2014

E0.1



# **GENERAL SHEET NOTES**

- A. COORDINATE EXACT LOCATION AND MOUNTING HEIGHT OF LUMINAIRES AND LIGHTING CONTROLS WITH THEATRICAL LIGHTING CONSULTANT PRIOR TO
- B. REFER TO THEATRICAL LIGHTING CONSULTANT DRAWINGS FOR ADDITIONAL INFORMATION AND LIGHTING CONTROL REQUIREMENTS.
- C. REFER TO THEATRICAL LIGHTING CONSULTANT DRAWINGS FOR LUMINAIRE SCHEDULE AND SYMBOLS.
- D. EXISTING LUMINAIRES AND LIGHTING CONTROLS NOT SHOWN ON PLAN SHALL REMAIN, U.O.N.

# **○ SHEET KEYNOTES**

1 DISCONNECT AND REUSE EXISTING LIGHTING CIRCUIT AS PART OF LED LUMINAIRE REPLACEMENT. LUMINAIRES TO BE RECONNECTED BACK TO EXISTING DIMMER

REVISIONS

SHEET TITLE
THEATER HOUSE
LIGHTING RETROFIT
FLOOR PLAN LIGHTING

SCALE: AS NOTED DATE: Sept. 9, 2014

E2.1

## **GENERAL SHEET NOTES**

- A. COORDINATE EXACT LOCATION AND MOUNTING HEIGHT OF EQUIPMENTS AND LIGHTING CONTROLS WITH THEATRICAL LIGHTING CONSULTANT PRIOR TO INSTALLATION.
- B. REFER TO THEATRICAL LIGHTING CONSULTANT DRAWINGS FOR ADDITIONAL INFORMATION AND LIGHTING CONTROL REQUIREMENTS.
- C. EXISTING EQUIPMENTS AND LIGHTING CONTROLS NOT SHOWN ON PLAN SHALL REMAIN, U.O.N.


## **○ SHEET KEYNOTES**

- 1 DISCONNECT AND REMOVE EXISTING UNISON SINGLE-GANG 10-BUTTON SNAPSHOT STATION AND REPLACE WITH NEW STATION 'S'. RECONNECT COMPLETE BACK TO EXISTING CIRCUIT TO PLACE BACK INTO SERVICE.
- 2 DISCONNECT AND REMOVE EXISTING UNISON SINGLE-GANG 5-BUTTON HOUSE/WORKLIGHT STATION AND REPLACE WITH NEW STATION 'HL'. RECONNECT COMPLETE BACK TO EXISTING CIRCUIT TO PLACE BACK INTO SERVICE.
- 3 DISCONNECT AND REMOVE EXISTING HOUSE LIGHT KEYSWITCH CONTROL STATION AND REPLACE WITH NEW STATION 'HLK'. RECONNECT COMPLETE BACK TO EXISTING CIRCUIT TO PLACE BACK INTO SERVICE.
- 4 EXISTING ETC UNISON ER-4 DR12 WALL MOUNTED DIMMER RACK TO REMAIN.
- 5 INSTALL NEW ETC UNISON PARADIGM ERn2 SIGNAL PROCESSOR RACK WITH SMALL 4-PORT NETWORK SWITCH. INTERCEPT AND EXTEND EXISTING CIRCUIT '3RBB-1.' TO NEW RACK AND CONNECT COMPLETE AS REQUIRED TO PLACE INTO SERVICE.








SCALE: 1/4"=1'-0"

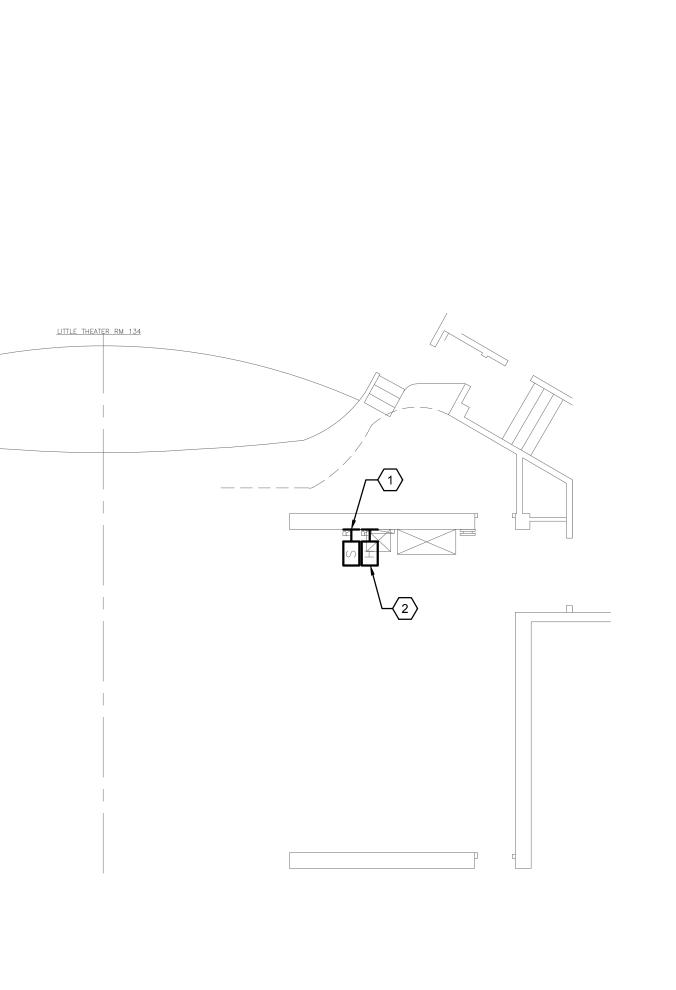

THEATER MAIN LEVEL STAGE PLAN

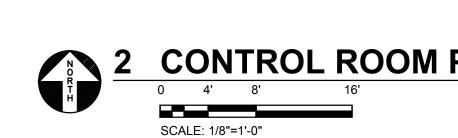

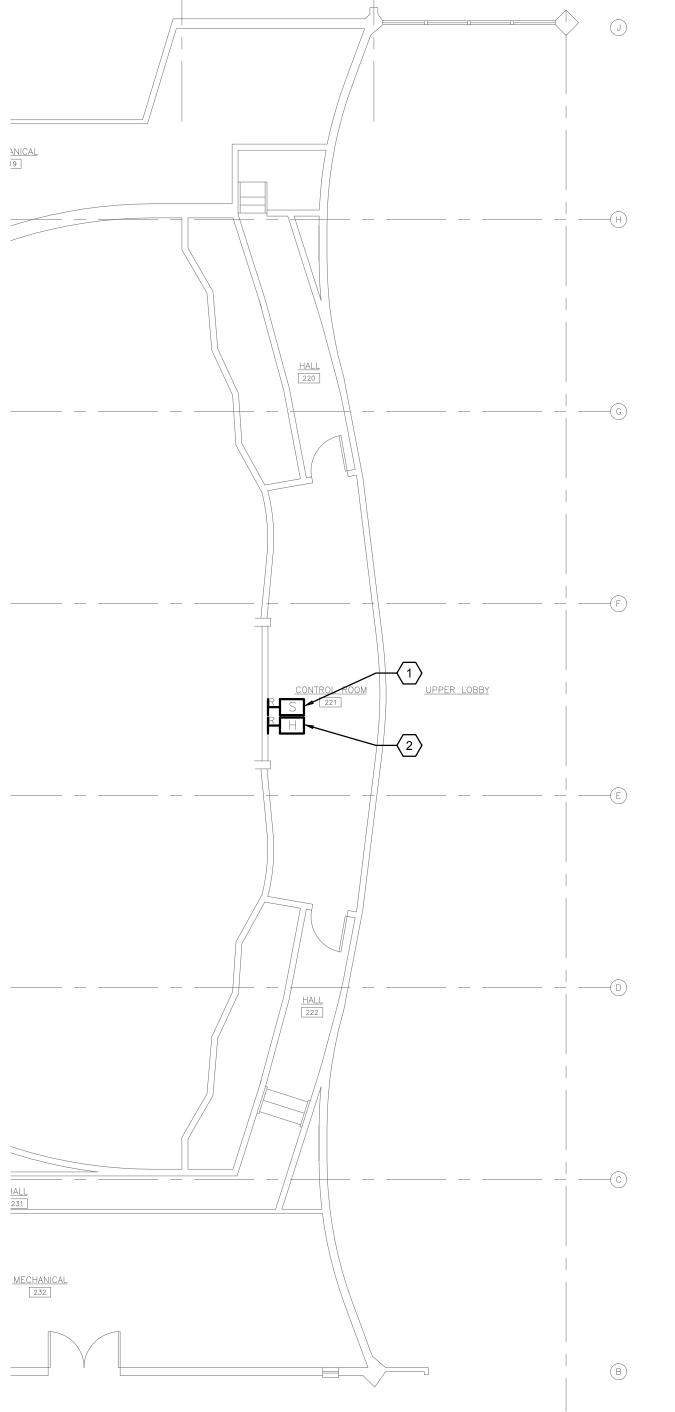

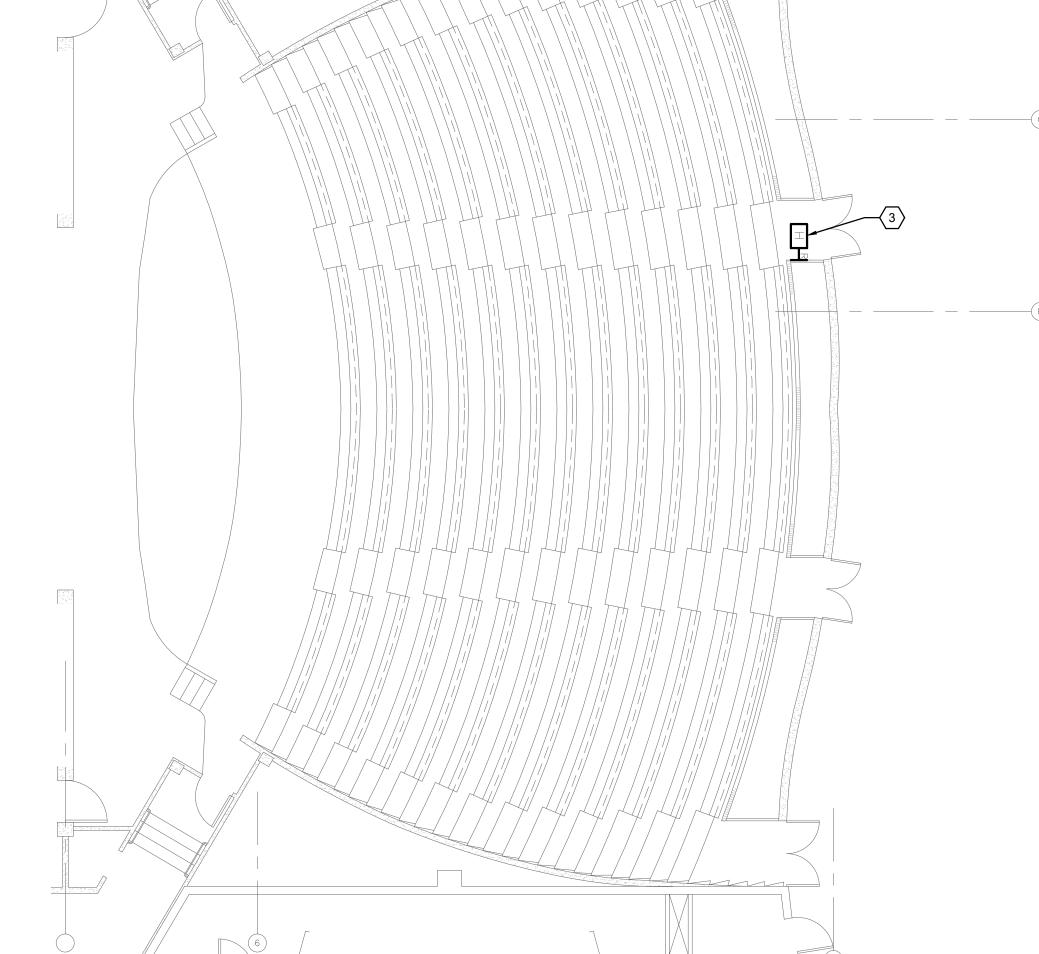







REVISIONS

SHEET TITLE
THEATER HOUSE
LIGHTING RETROFIT
LIGHTING CONTROL
FLOOR PLANS

SCALE: AS NOTED DATE: Sept. 9, 2014

SCALE: 1/8"=1'-0"