



College of San Mateo 1700 West Hillside Boulevard San Mateo, CA 94402

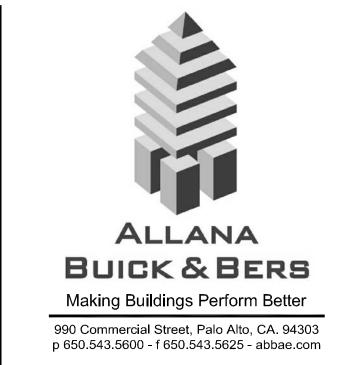


College of San Mateo Colonnades & District Office Deck Waterproofing Project

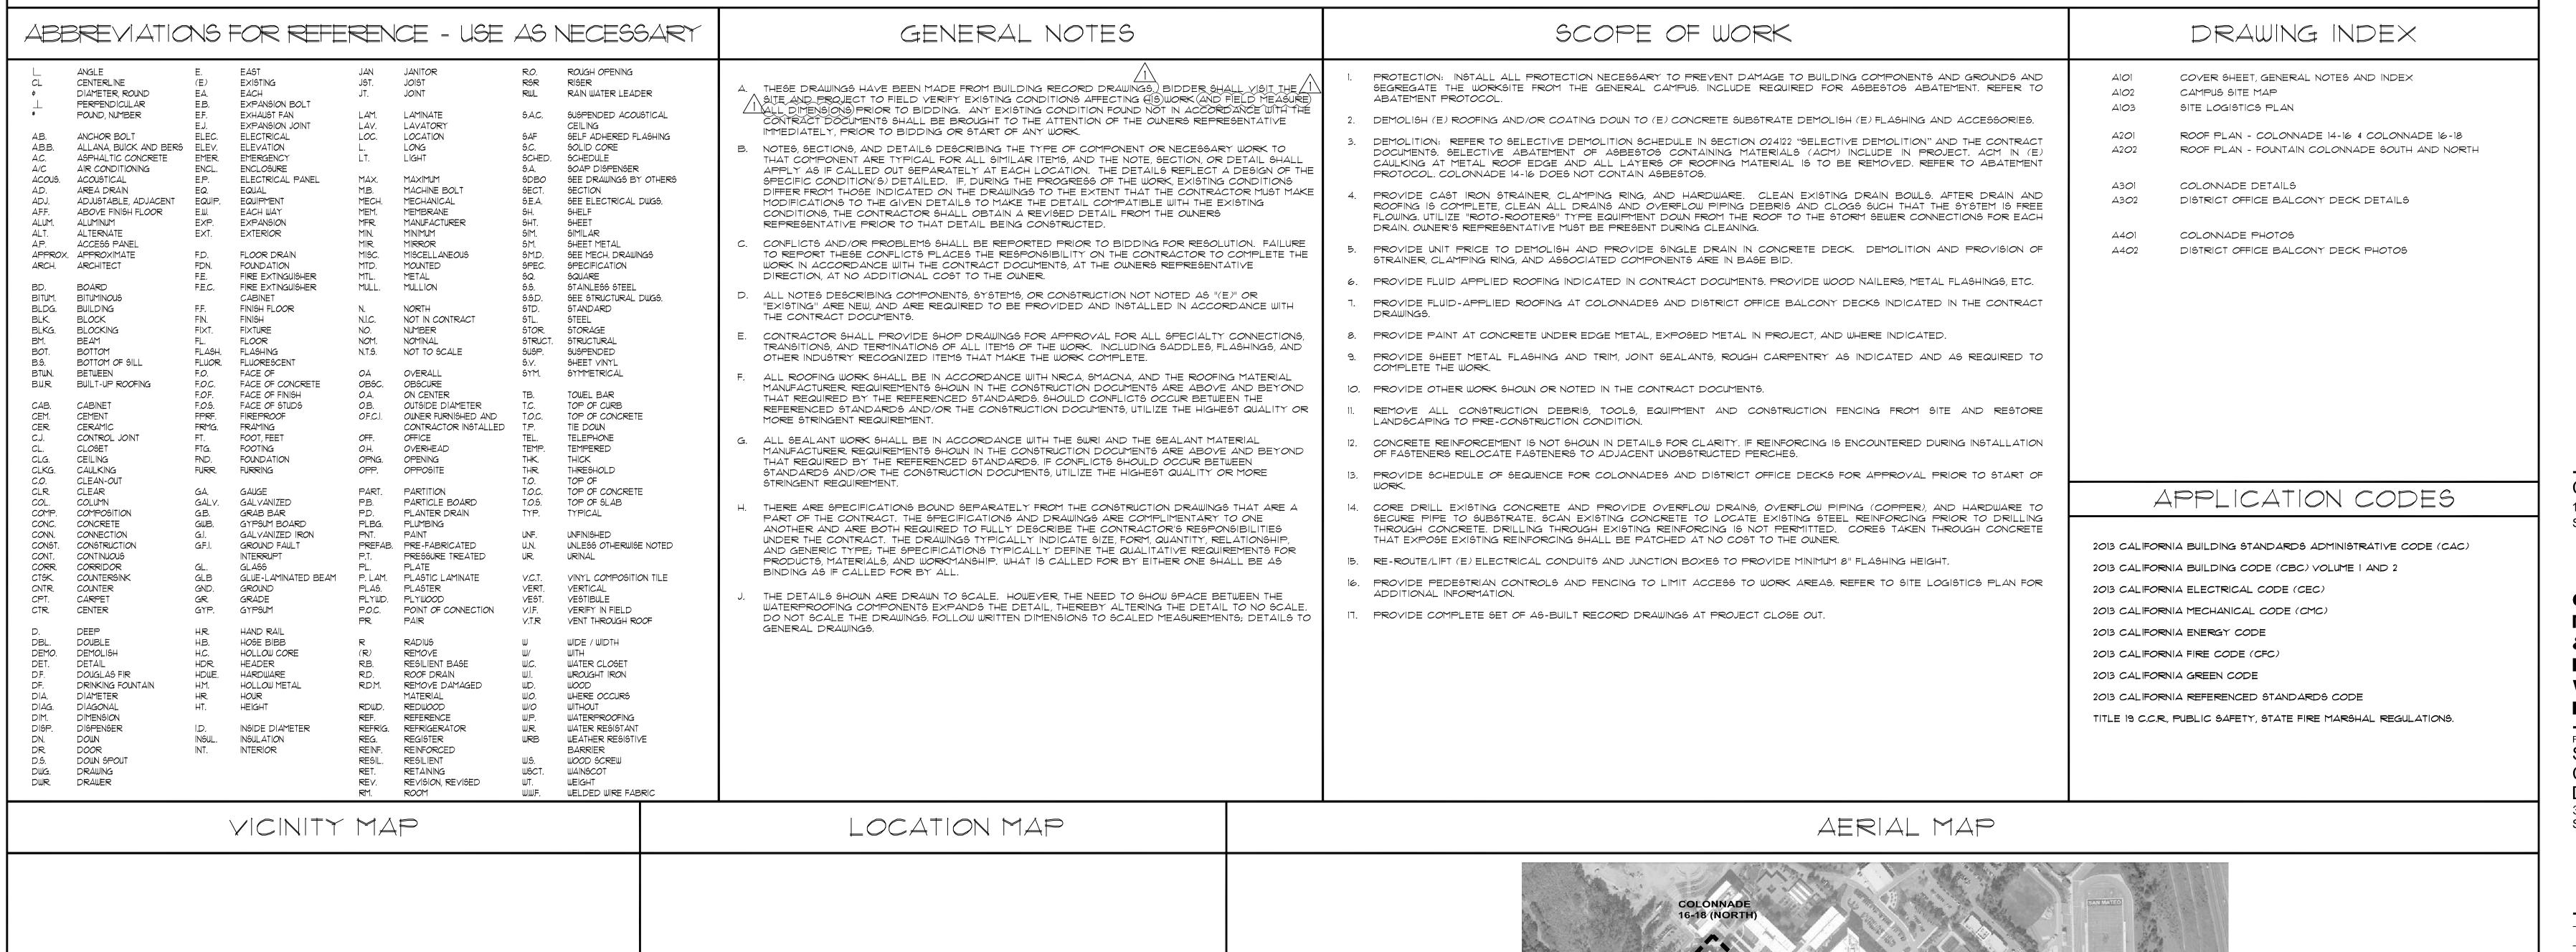

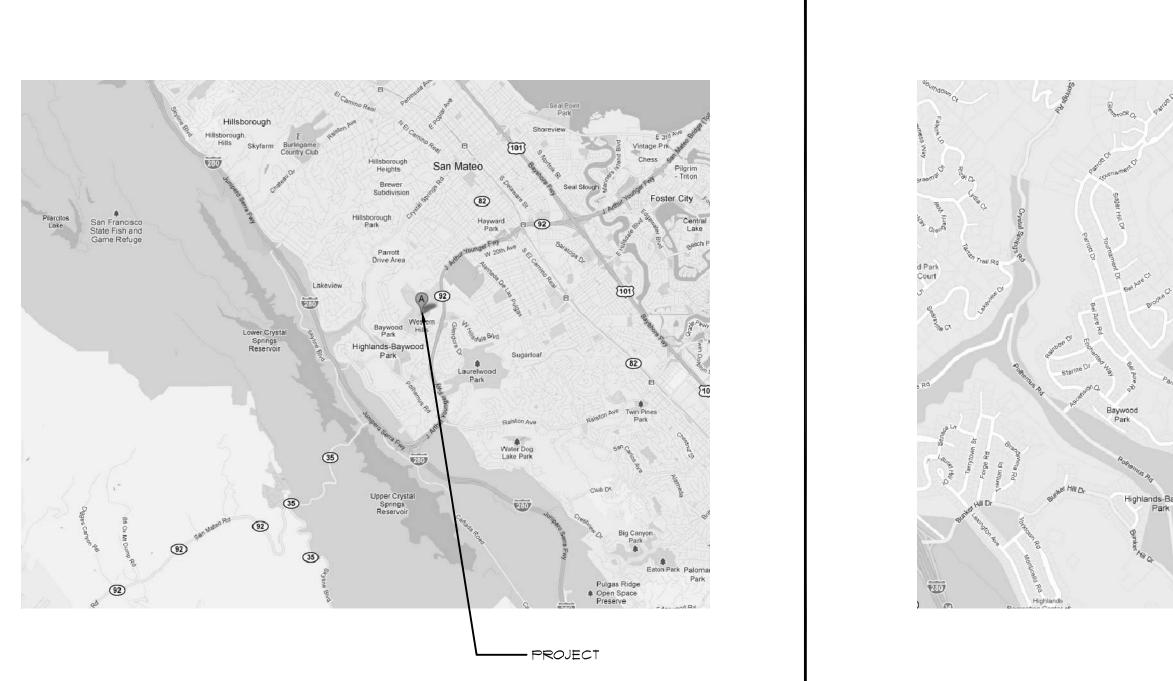

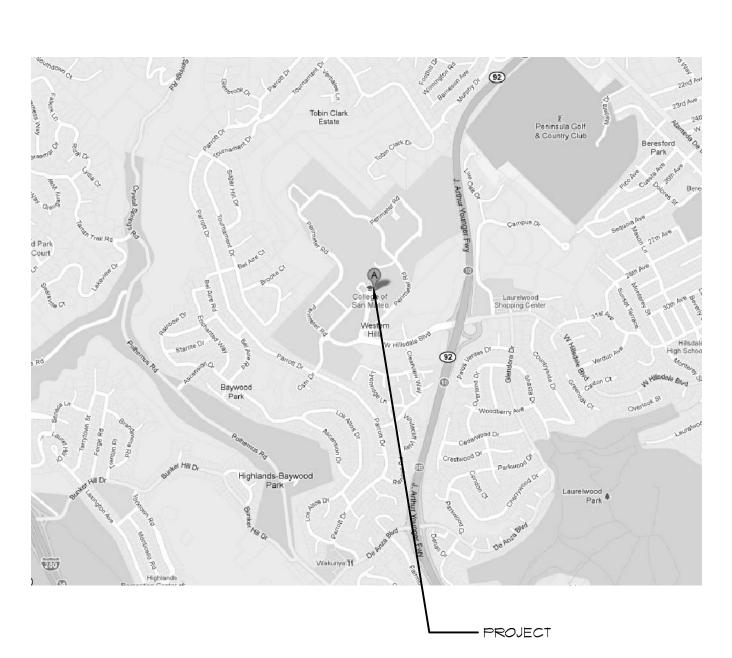


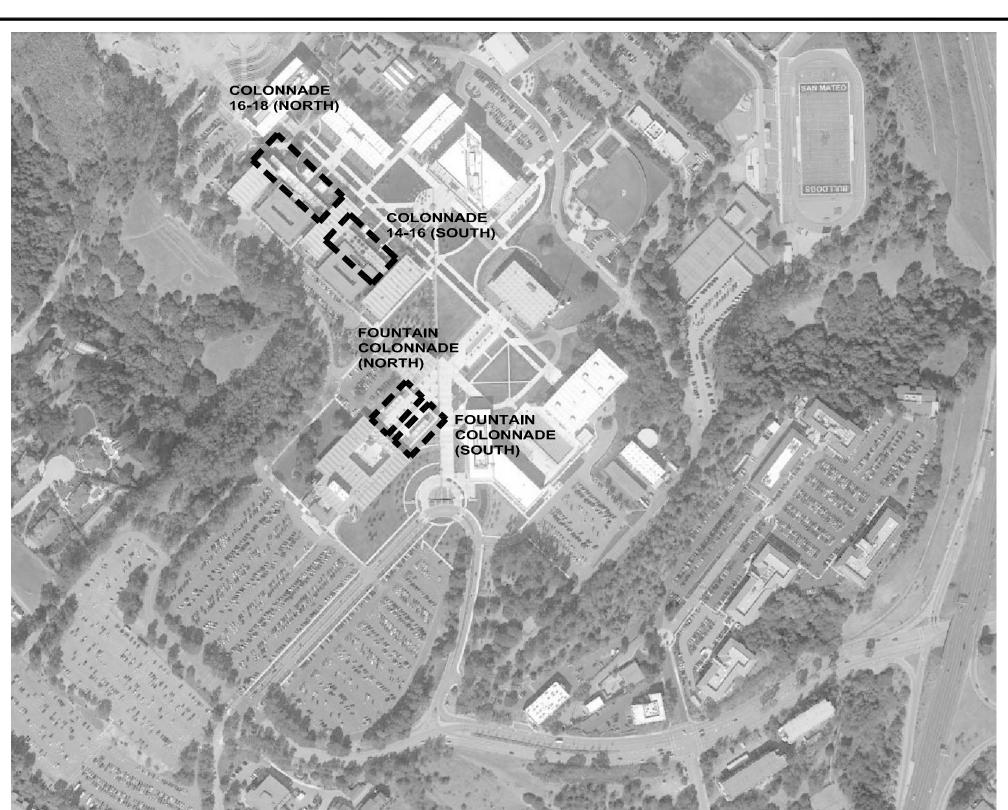

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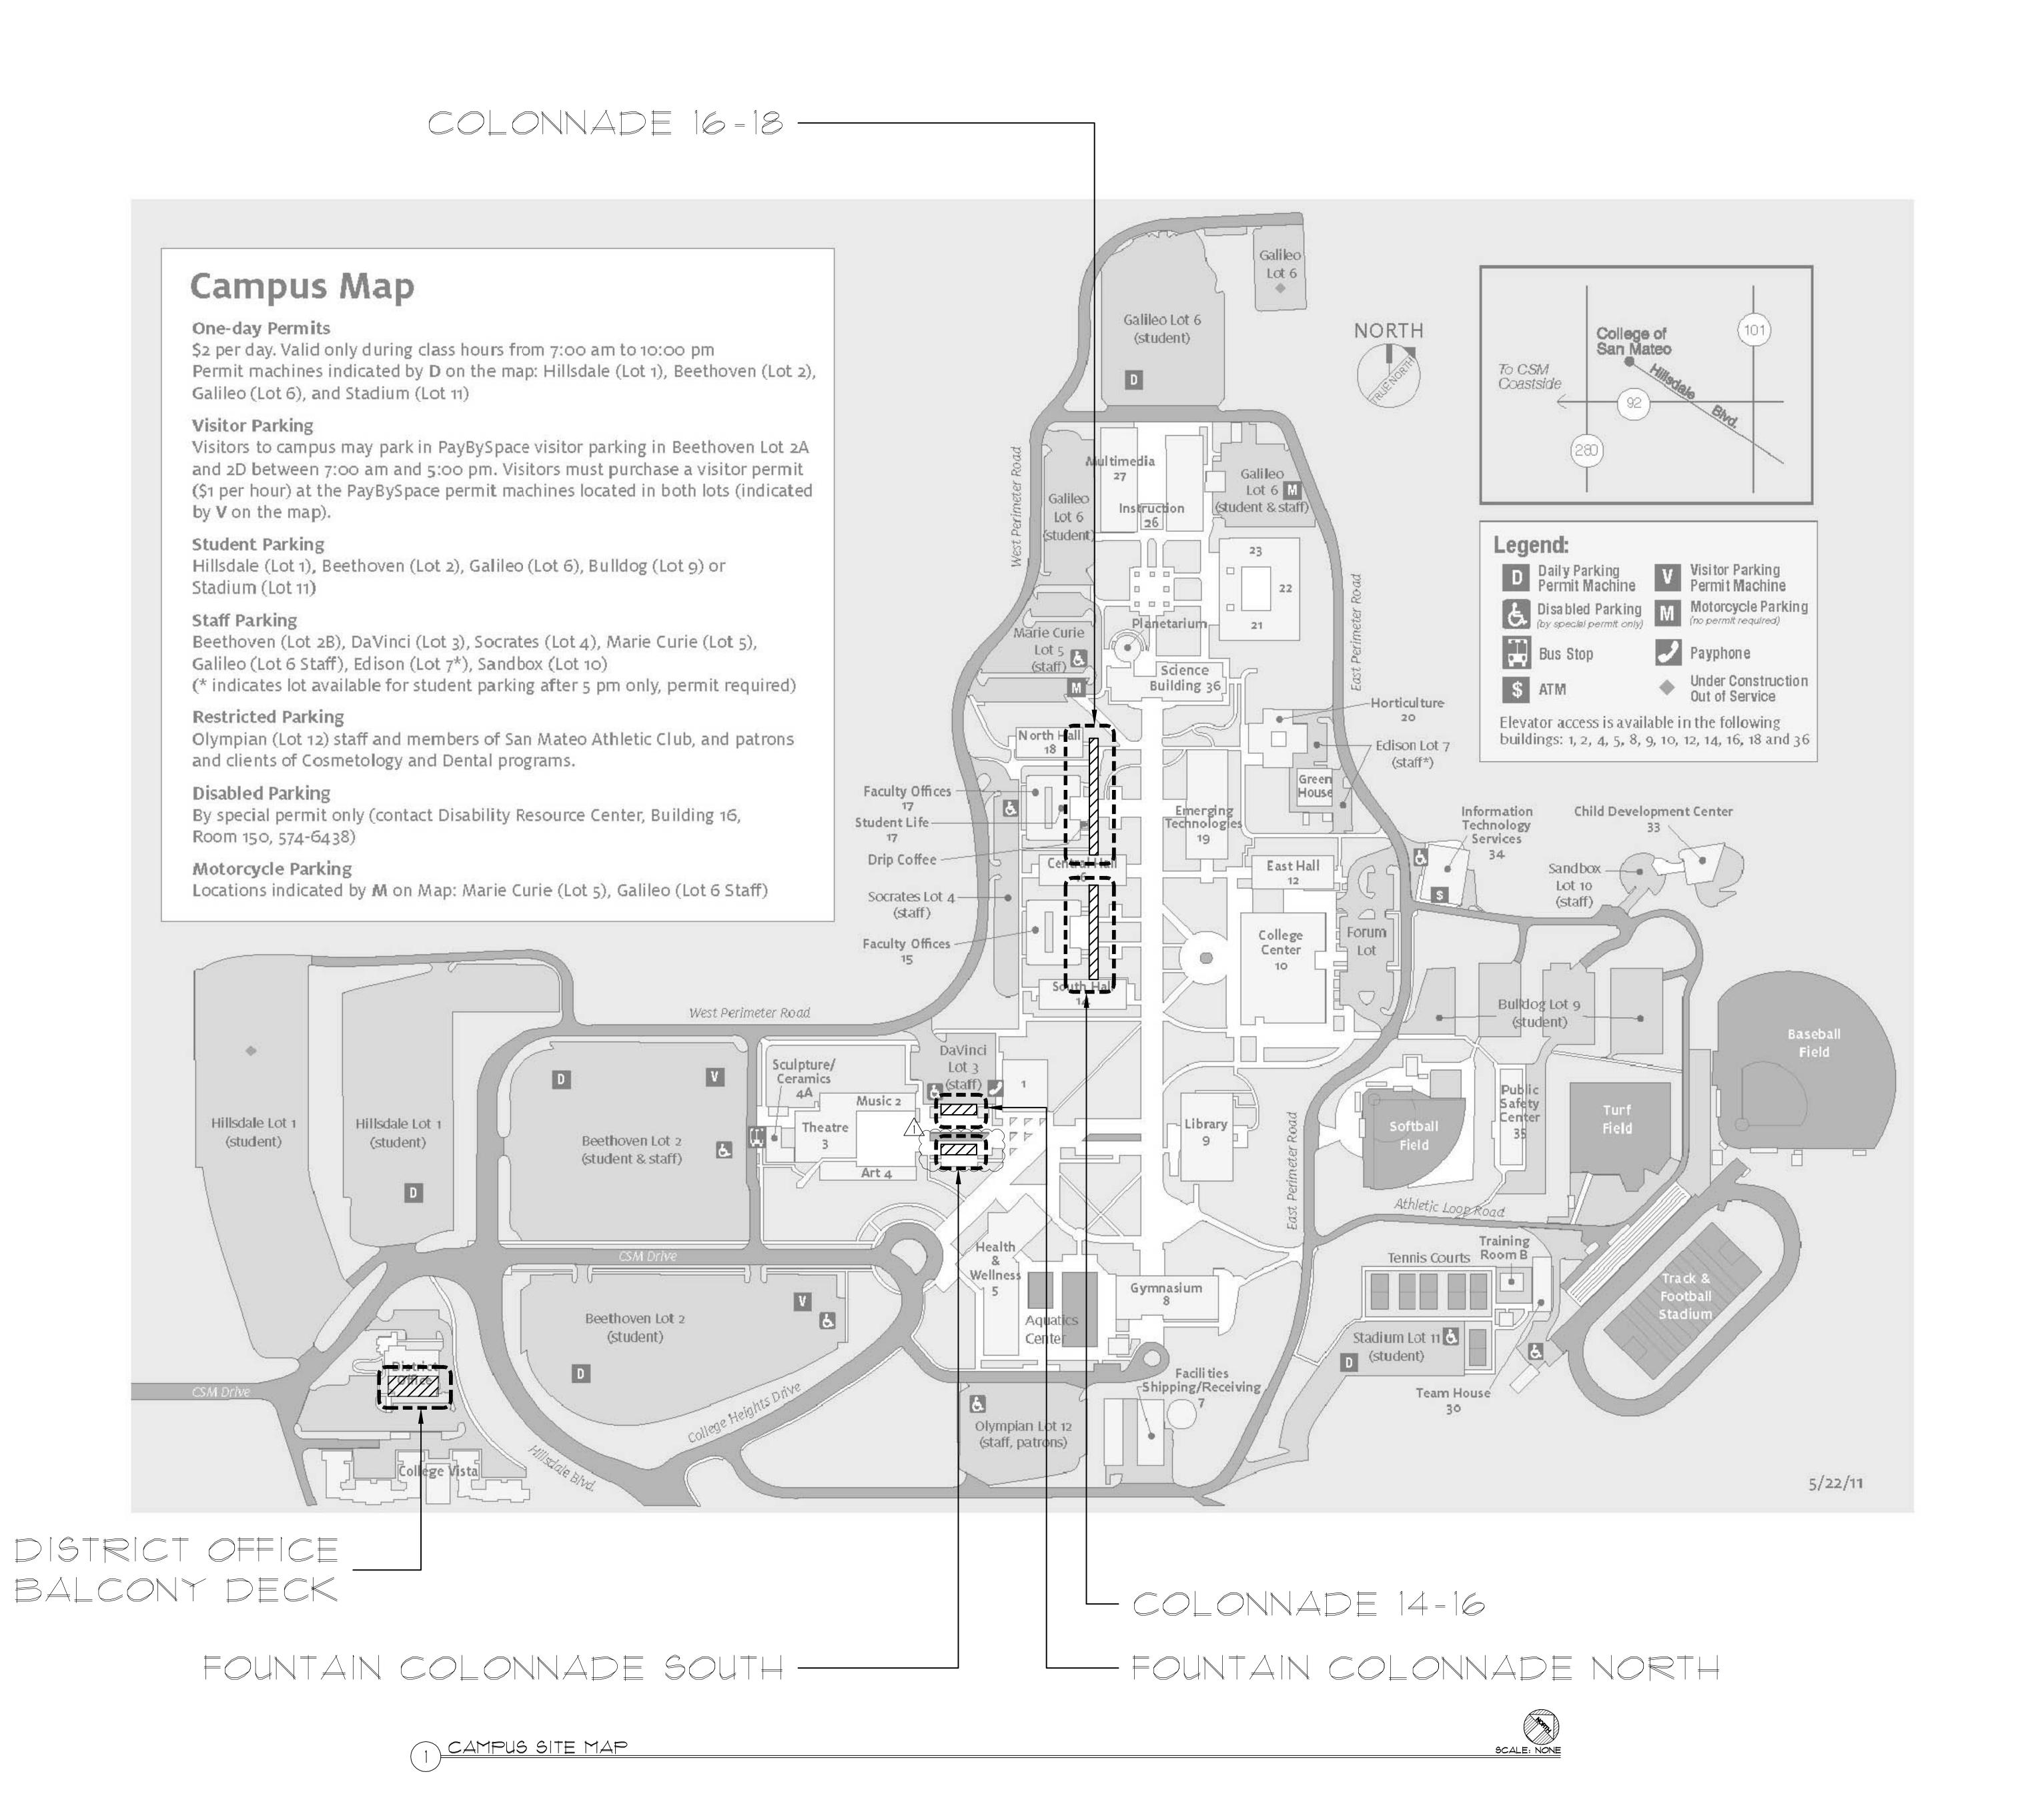
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Mateo Colonnades
& District Office
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SCALE: NOTED ON DRAWINGS

INDEX

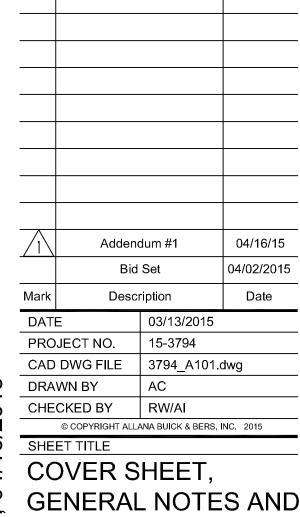

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GENERAL SHEET NOTES

- A. NO MATERIAL SHALL BE STOCK PILED ON ROOF SURFACE, BEYOND THAT REQUIRED FOR IMMEDIATE USE.
- B. REFER TO SITE LOGISTICS PLAN FOR ALL STAGING, STORAGE, PARKING, ACCESS, FENCING SIGNAGE, ETC DIRECTION.
- C. CAMPUS SITE AND BUILDING TO REMAIN IN-USE. DO NOT BLOCK ACCESS TO SITE OR BUILDING AT ANY TIME.
- D. CONTRACTOR TO ABIDE BY SITE PROTECTION AND SITE CLEANING REQUIREMENTS OUTLINED IN DIVISION I OF THE SPECIFICATIONS.

 CONSTRUCTION AND DEMOLITION DEBRIS TO BE CONFINED WITHIN BARRIER FENCING, EXCEPT AT DESIGNATED DISPOSAL AREAS.
- E. LANDSCAPING AND / OR SITE WORK DAMAGED BY DEMOLITION / CONSTRUCTION OPERATIONS, CONTRACTOR EMPLOYEES, SUB-CONSULATANTS OR CONTRACTOR'S SUPPLIERS SHALL BE REPLACED BY CONTRACTOR AT NO COST TO OWNER OR OWNER'S REPRESENTATIVES.
- F. ANY DAMAGE (TIŘE MAŘKŠ, MAŘŘING) (DISCOLORATIONS) TO THE BUILDING EXTERIOR FINISHES, WINDOWS, DOORS, SIGNS OR APPURTANCES SHALL BE REPAIRED BY THE CONTRACTOR AT NO EXPENSE TO THE OWNER OR OWNER'S REPRESENTATIVES.
- OR SIDEWALKS SHALL BE REPAIRED BY THE CONTRACTOR AT NO EXPENSE TO THE OWNER OR OWNER'S REPRESENTATIVES.

ANY DAMAGE TO (E) PAVED ROADS, WALKWAYS

- H. COORDINATE WORK SCHEDULE WITH FACILITIES.

 J. DOOR ENTRANCE CANOPIES SHALL BE FULL WIDTH OF OPENING. FULLY PROTECT ENTRANCE AND EXIT PATH FOR OCCUPANTS.
- K. CONTRACTOR SETUP AND STORAGE AREA.
 WALKWAYS ADJACENT TO SETUP AND STORAGE
 AREAS TO BE MAINTAINED AT WIDTHS IN
 COMPLIANCE WITH ADA REQUIREMENTS.

LEGEND

SCOPE OF WORK

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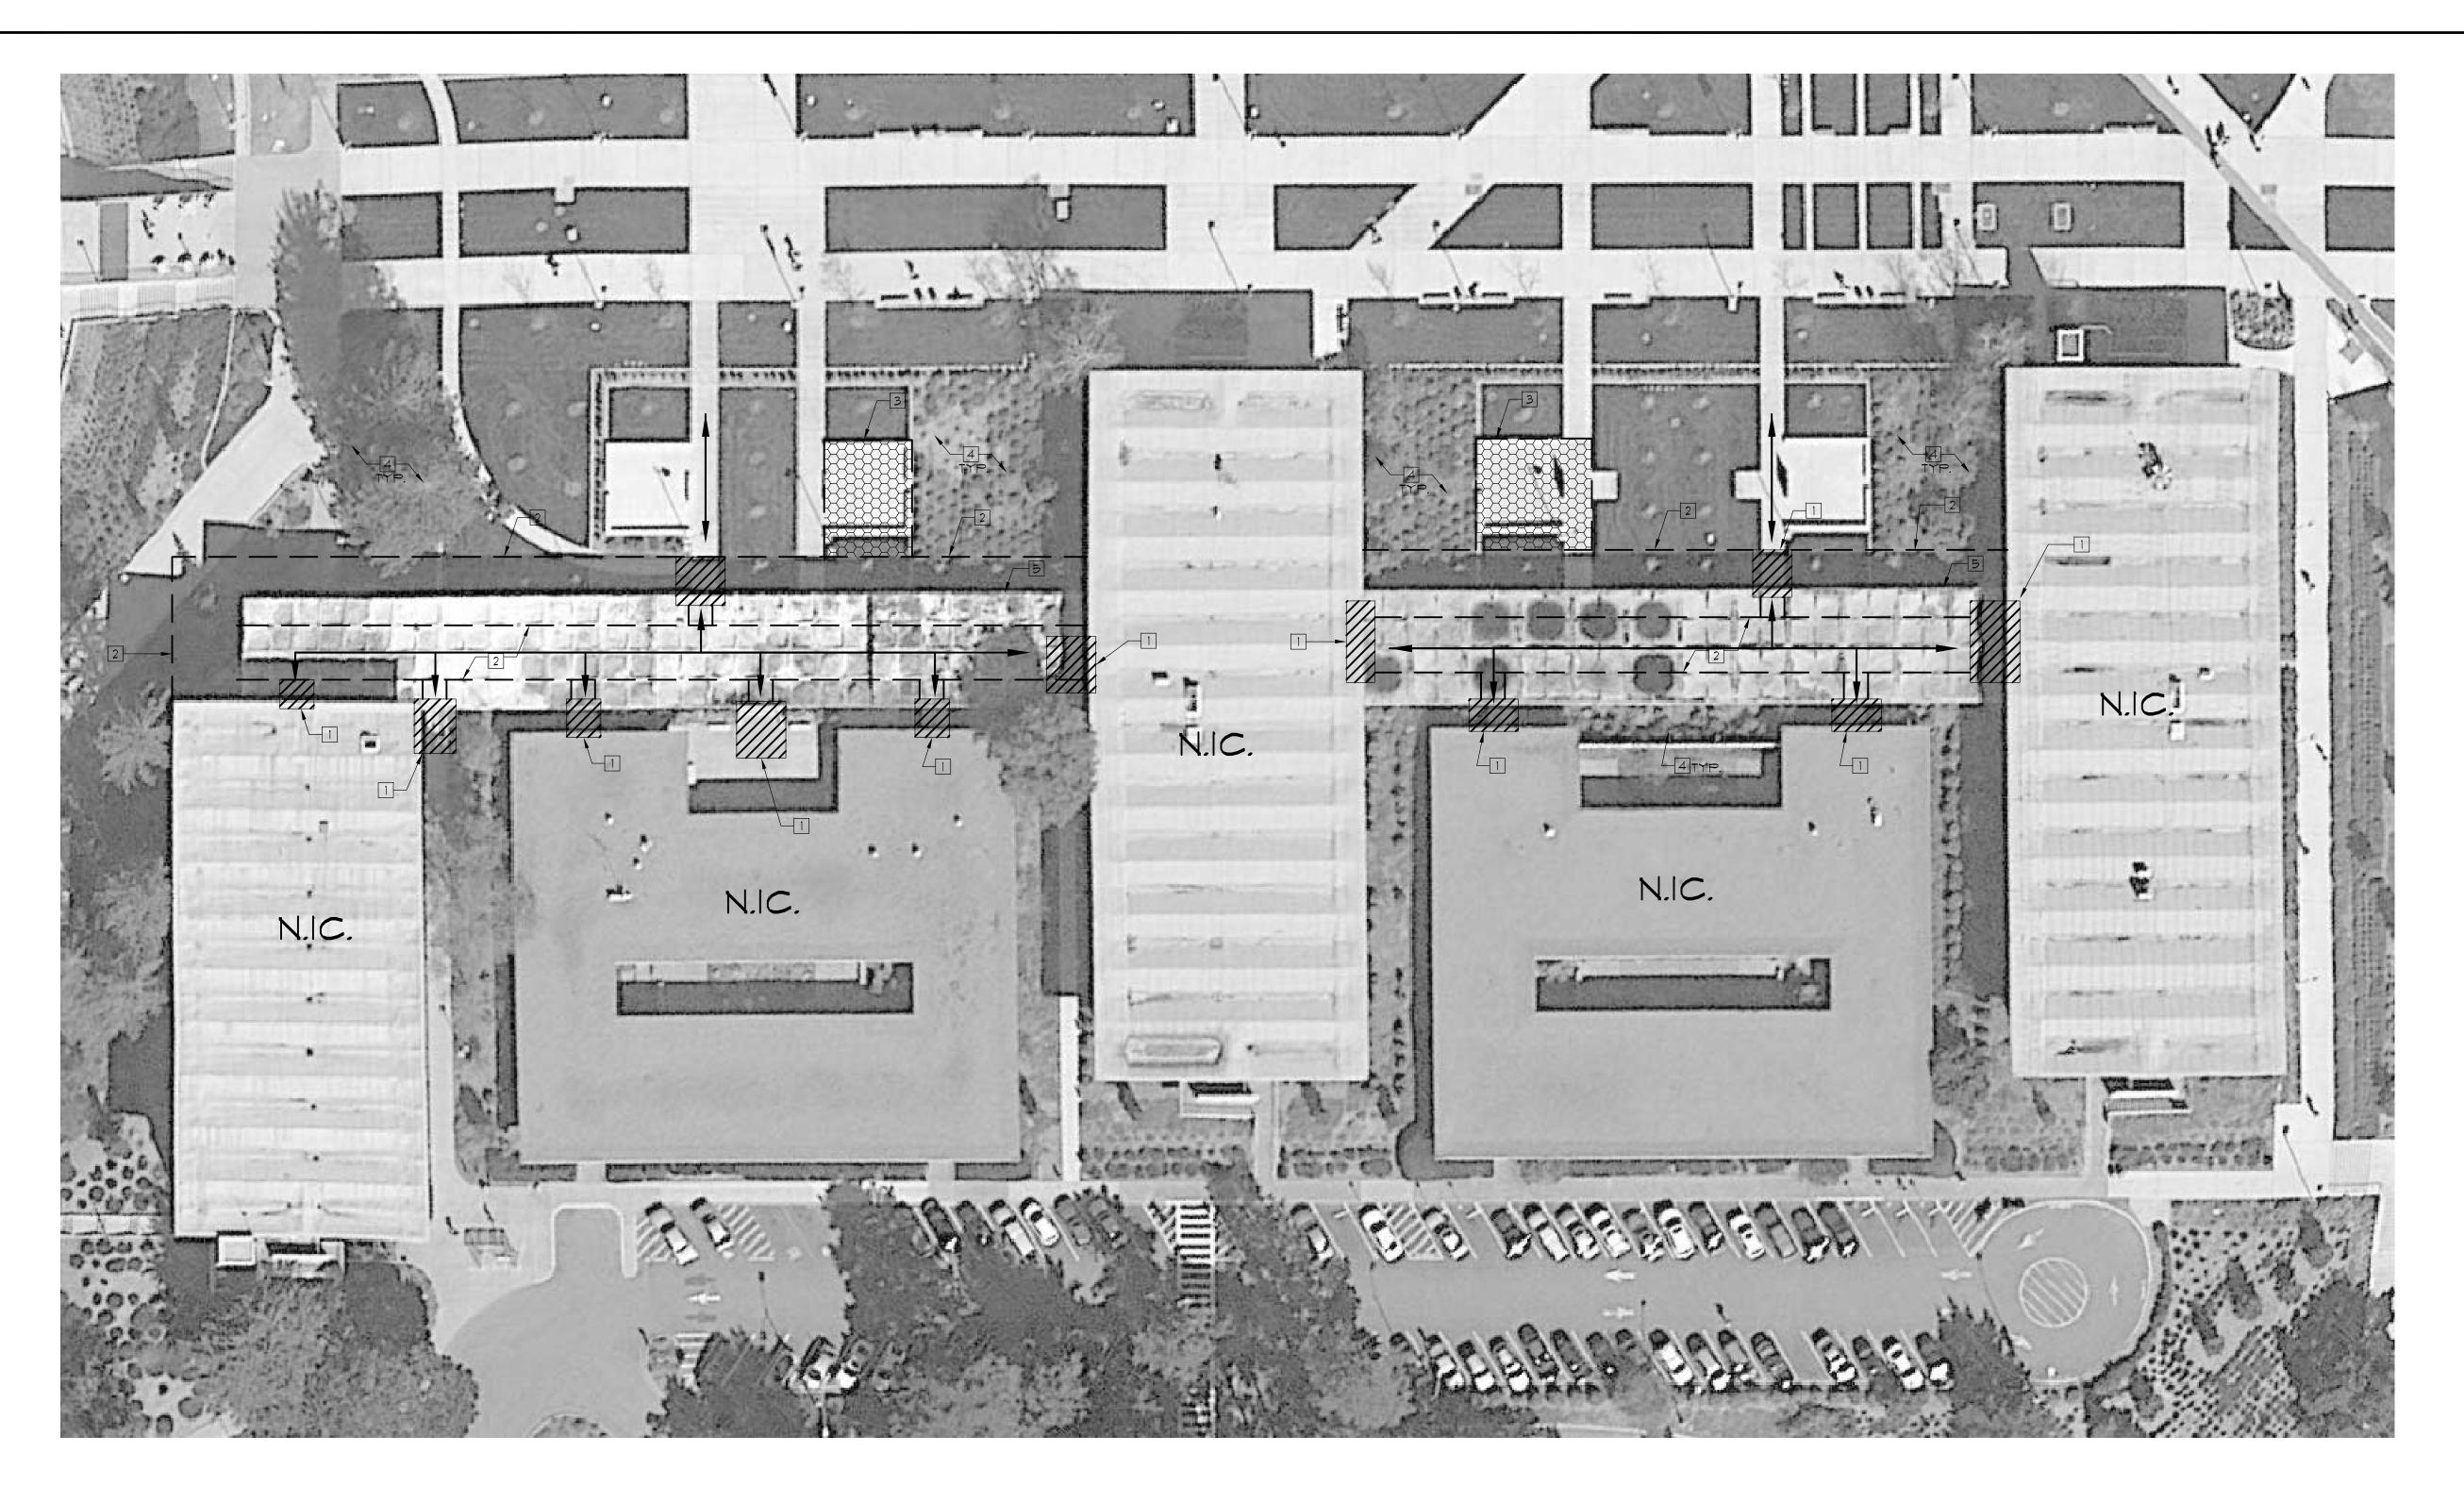
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SHEET TITLE

CAMPUS SITE MAP

SCALE: NOTED ON DRAWINGS





GENERAL SHEET NOTES

- A. THE TEMPORARY MEASURES AND REQUIREMENTS INDICATED ON THIS SITE LOGISTICS PLAN ILLUSTRATE ONLY A PORTION OF THE CONTRACTOR'S RESPONSIBILITY FOR STORAGE, SAFETY, AND PROTECTION UNDER THE CONTRACT. REFER TO DIVISION O \$ 1.
- B. BUILDING MATERIALS TO BE STORED IN INDICATED AREAS ONLY. VEHICLES WILL BE ALLOWED IN DESIGNATED LOCATIONS ONLY.
- C. CONTRACTORS, SETUP AND STORAGE AREAS SHALL BE WHERE INDICATED ONLY.
- D. ROOF ACCESS SHALL BE FROM EXTERIOR ONLY. SUBMIT PLAN FOR APPROVAL BY OWNER.
- E. BUILDING AND SITE TO REMAIN IN-USE. DO NOT BLOCK ACCESS TO SITE OR BUILDING AT ANY TIME
- F. CONTRACTOR TO ABIDE BY SITE PROTECTION
 AND SITE CLEANING REQUIREMENTS OUTLINED IN
 DIVISION I OF THE SPECIFICATIONS.
 CONSTRUCTION AND DEMOLITION DEBRIS TO BE
 CONFINED WITHIN BARRIER FENCING, EXCEPT AT
 DESIGNATED DISPOSAL AREAS.
- G. LANDSCAPING AND / OR SITE WORK DAMAGED BY DEMO / CONSTRUCTION OPERATIONS, CONTRACTOR EMPLOYEES, SUB-CONSULATANTS OR CONTRACTORS SUPPLIERS SHALL BE REPLACED BY CONTRACTOR AT NO COST TO OWNER OR OWNER'S REPRESENTATIVES.
- FINISHES, WINDOWS, DOORS, SIGNS OR
 APPURTANCES SHALL BE REPAIRED BY THE
 CONTRACTOR AT NO EXPENSE TO THE OWNER
 OR OWNER'S REPRESENTATIVES.

H. ANY DAMAGE TO THE BUILDING EXTERIOR

- J. ANY DAMAGE TO (E) PAVED ROADS, WALKWAYS,
 OR SIDEWALKS SHALL BE REPAIRED BY THE
 CONTRACTOR AT NO EXPENSE TO THE OWNER
 OR OWNER'S REPRESENTATIVES.

 K. CONTRACTOR SHALL PROVIDE BARRIER
- FENCING CONTINUOUS AROUND THE AREA OF CONSTRUCTION AS INDICATED, INCLUDING GATES AND LOCKS.


 L. DOOR ENTRANCE CANOPIES SHOWN ARE THE MIN.
- L. DOOR ENTRANCE CANOPIES SHOWN ARE THE MIN. REQUIRED BY CONTRACT. CONTRACTOR AT HIS OPTION MAY USE ADDITIONAL CANOPIES AS REQUIRED TO COMPLETE THE WORK.
- M. DOOR ENTRANCE CANOPIES SHALL BE FULL WIDTH OF OPENING. FULLY PROTECTED ENTRANCE AND EXIT PATH FOR OCCUPANTS.
- N. CONTRACTOR SETUP AND STORAGE AREA.
 WALKWAYS ADJACENT TO SETUP AND STORAGE
 AREAS TO BE MAINTAINED AT WIDTHS IN
 COMPLIANCE WITH ADA REQUIREMENTS.
- P. PROVIDE DETOUR SIGNAGE WHERE DIRECTED BY THE OWNER, INCLUDING FENCE-MOUNTED SIGNAGE NECESSARY TO RE-DIRECT TO AVAILABLE ENTRANCES.
- Q. NO MATERIAL SHALL BE STOCK PILED ON ROOF SURFACE BEYOND THAT REQUIRED FOR IMMEDIATE USE.
- R. REMOVAL OF DEBRIS FROM ROOF TO GROUND LEVEL SHALL BE BY ENCLOSED CHUTE OR DEBRIS BOX AND CRANE PICKS, CONTRACTOR TO CONSOLIDATE MATERIALS TO MINIMIZE PICKS,
- S. SAFETY IS THE SOLE RESPONSIBILITY OF THE CONTRACTOR.

KEY NOTES

- PROVIDE PROTECTIVE CANOPIES OVER BUILDING ENTRANCES, WHERE SHOWN ON SITE LOGISTICS PLAN. CONTRACTOR TO PROVIDE SHOP DRAWINGS OF EACH CANOPY FOR APPROVAL PRIOR TO ERECTION.
- 2 BARRIER FENCING WITH MESH FABRIC AND LOCKS, WHERE POSSIBLE WHILE MAINTAINING ADA ACCESS.
- AREA FOR CONTRACTOR SETUP AND STORAGE.
 PROVIDE FENCING AND GATES AS REQ'D, 4' MIN.
 FROM EDGE OF BUILDING, WHERE POSSIBLE WHILE
 MAINTAINING ADA ACCESS. CONTRACTOR
 RESPONSIBLE FOR PROTECTION OF (E)
 LANDSCAPING OR (E) HARDSCAPING, INCLUDING
 GRASS TURF. ANY DAMAGE TO (E) LANDSCAPING
 OR (E) HARDSCAPING SHALL BE REPAIRED BY
 THE CONTRACTOR AT NO EXPENSE TO THE OWNER
 OR OWNER'S REPRESENTATIVES.
- 4 TYPICAL ALL LANDSCAPING AREAS TO BE PROTECTED FROM FALLING DEBRIS/SCRAP.
- 5 LOCATION FOR EXTENSION LADDER, ANCHOR PER OSHA REQUIREMENTS,

LEGEND

--- BARRIER FENCING WITH MESH FABRIC

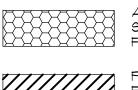

AUTHORIZED CONTRACTOR
SETUP AND STORAGE AREA IF
FIELD CONDITIONS ALLOW

PROTECTIVE CANOPIES OVER BUILDING
ENTRANCES AND WALKWAYS 8 FEET MIN
TWICE THAT OF SCAFFOLDING

PATH OF TRAVEL

SHEET KEYED NOTE

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	ISSUE			
	Addendum #1		dum #1	04/16/15
		Bid Set		04/02/2015
	PROJECT NO. 1		ription	Date
			03/13/2015	
			15-3794	
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	DRAWN BY		ΔC	

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DRAWN BY AC

CHECKED BY RW/AI

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SHEET TITLE

SITE LOGISTICS PLAN

SCALE: NOTED ON DRAWINGS

A103

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(E) ROOF DRAIN 2. DEMOLISH (E) LEAD FLASHING BUT DO NOT DAMAGING EXISTING PENETRATIONS, TYPICAL. (E) COPPER OVERFLOW PIPE OVERFLOW CORE AND COPPER PIPE DEMOLISH (E) STRAINER DOME, CLAMPING RING AND BOLTS. SALVAGE COMPLETE ASSEMBLIES AND DELIVER TO OWNER. DETAIL CALLOUTS 4. PROVIDE FLUID-APPLIED ROOFING SYSTEM. # 5. ADJUST HEIGHT OF (E) COPPER PENETRATION KEY NOTES ADJACENT TO DRAIN. PROVIDE INTAKE LEVEL AT 2" ABOVE ROOF DRAIN. 6. ELECTRICAL CONDUIT PENETRATION, RAISE TO 8" MINIMUM HEIGHT. p 650.543.5600 - f 650.543.5625 - abbae.com 1. ELECTRICAL JUNCTION BOX, RAISE CONDUIT STUB TO 8" MINIMUM HEIGHT. 8. RE-ROUTE CONDUIT TO PROPER 8" HEIGHT. 9. PROVIDE OVERFLOW CORE IN CONCRETE DECK AND COPPER DRAIN LINE. 10. (E) SEALANT AT OUTSIDE EDGE OF METAL FLASHING CONTAINS ASBESTOS. ABATEMENT REQUIRED, FOLLOW ABATEMENT PROTOCOL. 11. ALL LAYERS OF ROOFING MATERIAL CONTAIN ASBESTOS. ABATEMENT REQUIRED, FOLLOW ABATEMENT PROTOCOL. ±256' TYP. 3 2 TYP. 4301 2 4 11 TYP. 9 A301 TYP. TYP. 6 8 PENETRATION A301 A301 8 A301 6 TYP. A301 7 39 23 13 A301 TYP. (2) ROOF PLAN - COLONNADE 16-18 (NORTH COLONNADE) SCALE: 1/8"=1'-0" ±192' A301 PENETRATION TYP. 4301 TYP. ROOF PLAN - COLONNADE 14-16 (SOUTH COLONNADE) SCALE: 1/8"=1'-0" I INCH AT FULL SCALE.
IF NOT I INCH THIS DRAWING.
HAS BEEN REPRODUCED.
(NOT TO SCALE SHOWN.)



KEY NOTES

CONCRETE.


1. DEMOLISH EXISTING ROOF SYSTEMS TO BASE

AS NOTED WITH: #

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ROOF PLAN -COLONNADE 14-16 & **COLONNADE 16-18**

SCALE: NOTED ON DRAWINGS

A301 A301 9 TYP. 10 TYP. TYP. 3
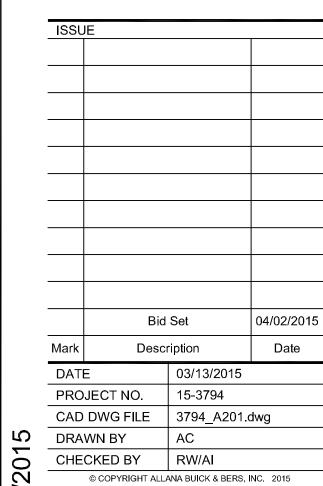
#

(E) ROOF DRAIN

(E) COPPER OVERFLOW PIPE OVERFLOW CORE AND COPPER PIPE

DETAIL CALLOUTS

KEY NOTES

KEY NOTES

DEMOLISH EXISTING ROOF SYSTEMS TO BASE CONCRETE.

AS NOTED WITH: #

2. DEMOLISH (E) LEAD FLASHING BUT DO NOT

DAMAGING EXISTING PENETRATIONS, TYPICAL.

3. DEMOLISH (E) STRAINER DOME, CLAMPING RING AND BOLTS. SALVAGE COMPLETE ASSEMBLIES

AND DELIVER TO OWNER.

AND COPPER DRAIN LINE.

ABATEMENT PROTOCOL.

4. PROVIDE FLUID-APPLIED ROOFING SYSTEM. 5. ADJUST HEIGHT OF (E) COPPER PENETRATION

ADJACENT TO DRAIN. PROVIDE INTAKE LEVEL AT 2" ABOVE ROOF DRAIN.

6. ELECTRICAL CONDUIT PENETRATION, RAISE TO 8"

MINIMUM HEIGHT. 1. ELECTRICAL JUNCTION BOX, RAISE CONDUIT STUB TO 8" MINIMUM HEIGHT.

8. RE-ROUTE CONDUIT TO PROPER 8" HEIGHT.

9. PROVIDE OVERFLOW CORE IN CONCRETE DECK


10. (E) SEALANT AT OUTSIDE EDGE OF METAL FLASHING CONTAINS ASBESTOS. ABATEMENT REQUIRED, FOLLOW ABATEMENT PROTOCOL. II. ALL LAYERS OF ROOFING MATERIAL CONTAIN ASBESTOS. ABATEMENT REQUIRED, FOLLOW

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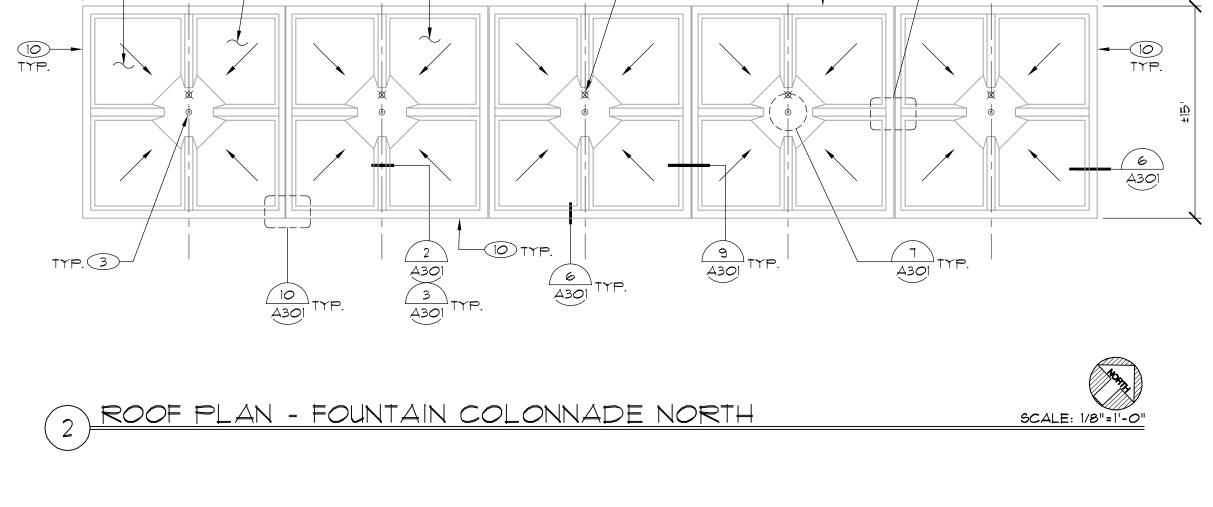
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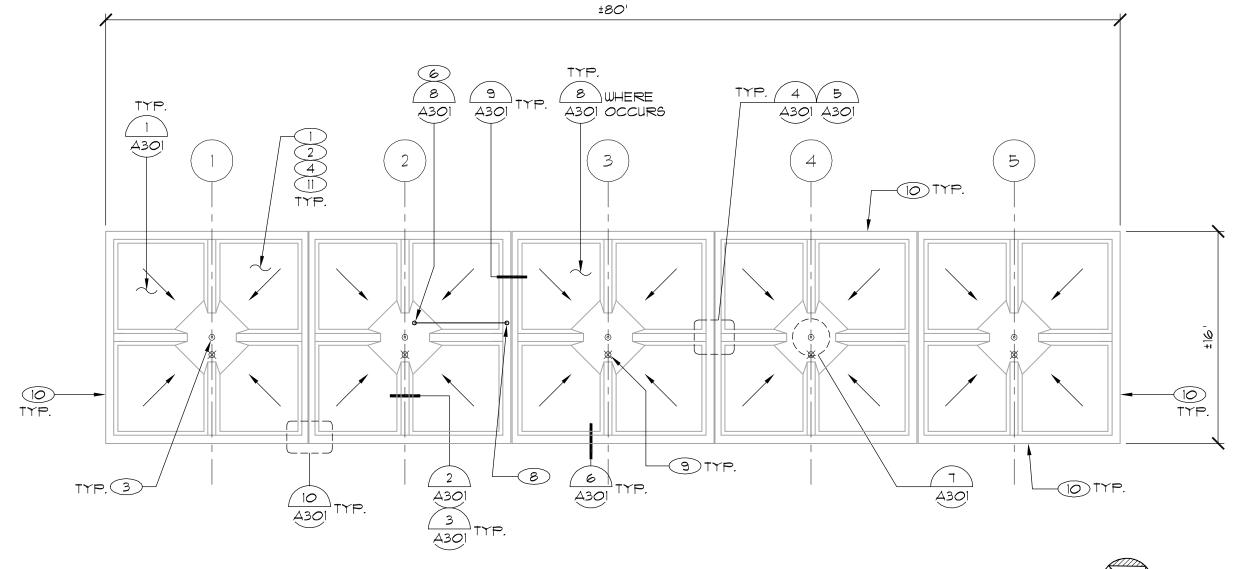
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ROOF PLAN - FOUNTAIN
COLONNADE SOUTH
AND NORTH & BLDG 1 ≥ AND 4 COLONNADE SCALE: NOTED ON DRAWINGS

A202

I NCH AT FULL SCALE.
IF NOT I NCH THIS DRAWING
HAS BEEN REPRODUCED
(NOT TO SCALE SHOWN)



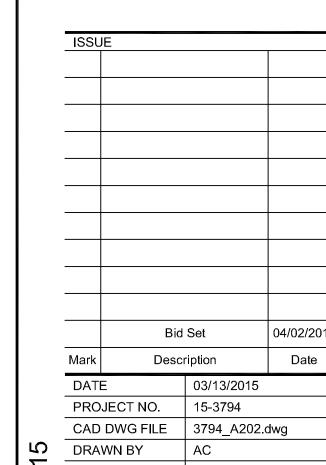


ROOF PLAN - FOUNTAIN COLONNADE SOUTH

SCALE: 1/8"=1'-0"

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SCALE: N.T.S.



MIN. BEYOND LINE OF

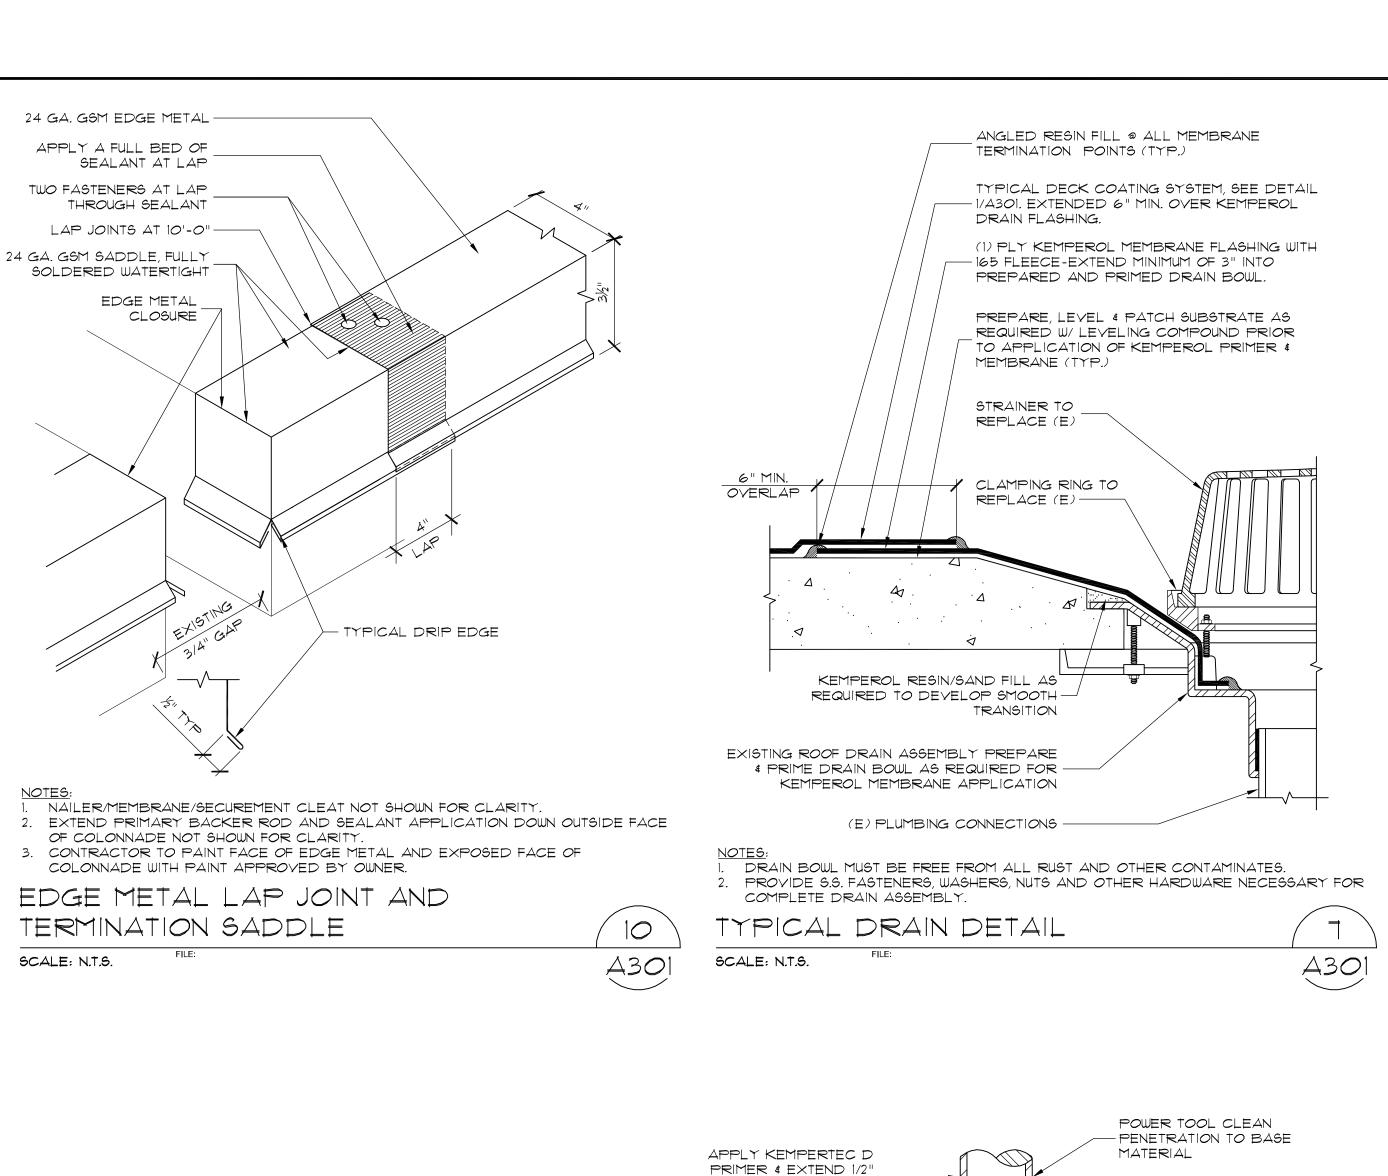6" MIN.

FLASHING HEIGHT, TYPICAL.

POLYURETHANE SEALANT,

WIDTH/DEPTH RATIOS. LET

SEALANT CURE/SKIN OVER -

PRIOR TO INSTALLING

SECOND BACKER ROD

AND MEMBRANE DETAIL

OF COLONNADE.

SCALE: N.T.S.

SET IN CORRECT

APPROXIMATELY

BETWEEN SECTIONS

¾" E×ISTING 🕺

TYPICAL EXPANSION JOINT

SCALE: N.T.S.

A301

A301

24 GA GSM EDGE METAL WITH 4" MIN. DECK

FLANGE SET IN A FULL BED OF MASTIC

1/2" LONG GALY. RING — SHANK NAILS AT 3" *O.*C. TWO ROWS, STAGGERED

NOTES: 1. SEE DETAIL 10/A301 FOR LAPS AND 13/A301 FOR CORNERS.

EDGE FABRICATION

SCALE: N.T.S.

15


A301

22 GA GSM CONTINUOUS CLEAT,

- FASTENED WITH 1½" LONG GALVANIZED STEEL ROOFING NAILS, 6" O.C. MAX.

I. RAISE/EXTEND ELECTRICAL CONDUIT TO PROVIDE 8" MIN.

TYPICAL PENETRATION DETAIL

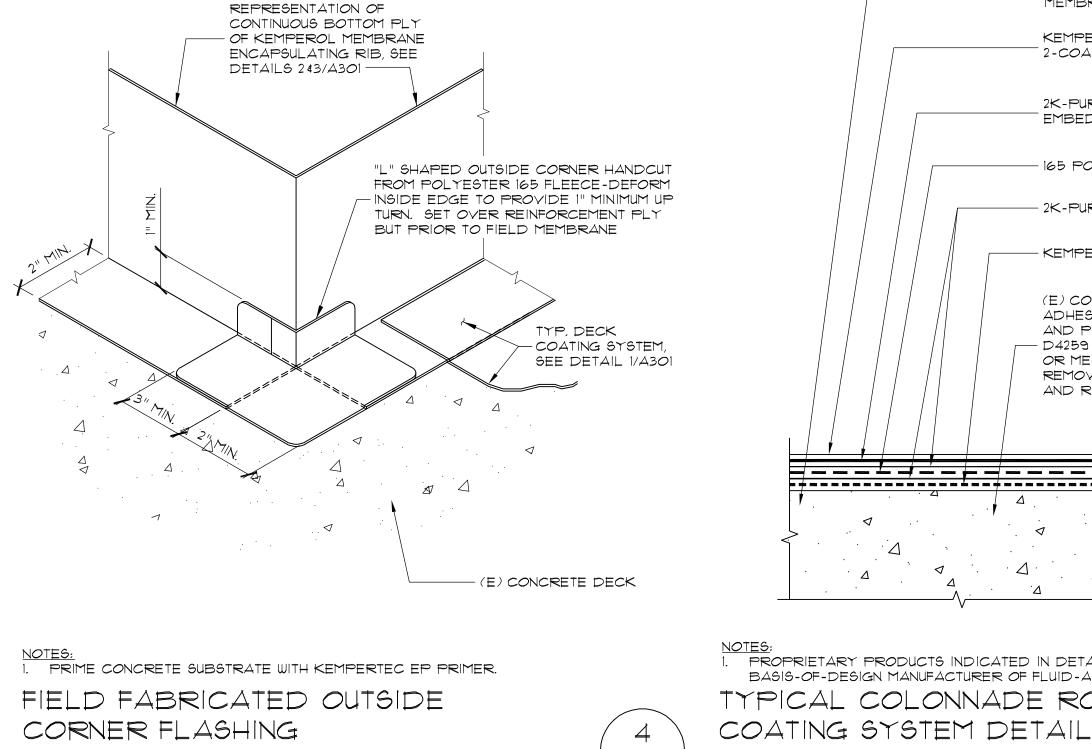

REPRESENTATION OF

CONTINUOUS BOTTOM PLY

_ OF KEMPEROL MEMBRANE ENCAPSULATING RIB, SEE

DETAILS 2 \$3/A301 -----

TYP. DECK COATING

<u>NOTES:</u> 1. PRIME CONCRETE SUBSTRATE WITH KEMPERTEC EP PRIMER.

FIELD FABRICATED INSIDE

CORNER FLASHING

SCALE: N.T.S.

STAGGERED 1/2"

INFORMATION.

SCALE: N.T.S.

A301

SYSTEM, SEE DETAIL 1/A301

SCALE: N.T.S.

ANGLED RESIN FILL @ ALL

KEMPEROL MEMBRANE SKIRT

FLASHING WITH 165 FLEECE

WRAPPED AROUND PIPE W/ 2" MIN.

KEMPEROL MEMBRANE COLLAR

- WITH FLEECE CUT INSIDE DIA. 1/2"

SMALLER THAN PIPE DIAMETER

TYPICAL DECK COATING SYSTEM.

CUT TIGHT TO PENETRATION

COVE OF SEALANT TO SEAL

(E) CONCRETE SUBSTRATE, PRIME

A301

WITH KEMPERTEC EP PRIMER

CONTINUOUS CLOSED CELL

FLEECE

30° (TYP.)

- RESIN CANT (TYP.)

POLYETHYLENE FOAM BACKER ROD.

(2) PLY KEMPEROL MEMBRANE TOP & (1) PLY BOTTOM SET WET-IN-WET W/ 2"

MIN. OFFSET END/SIDE LAPS. USE 165

TYPICAL DECK COATING

(E) CONCRETE DECK. PRIME

WITH KEMPERTEC EP PRIMER

BEVELED EDGE 3/8" MAX. @

APPLY BOND BREAKER TAPE

_W/ ADHESIVE BACKING @
VERTICAL JOINT SURFACES,

CONTINUOUS CLOSED CELL

ABOVE SEALANT JOINT

-POLYURETHANE FOAM

BACKER ROD

I. EXTEND PRIMARY BACKER ROD AND SEALANT APPLICATION DOWN OUTSIDE FACE

SYSTEM, SEE DETAIL 1/A301

RADIAL CUTS TO SKIRT

AS REQUIRED


- GAP AT DECK TO

PENETRATION

- SEE DETAIL 1/A301, WITH 165 FLEECE

MEMBRANE TERMINATION

POINTS (TYP.)

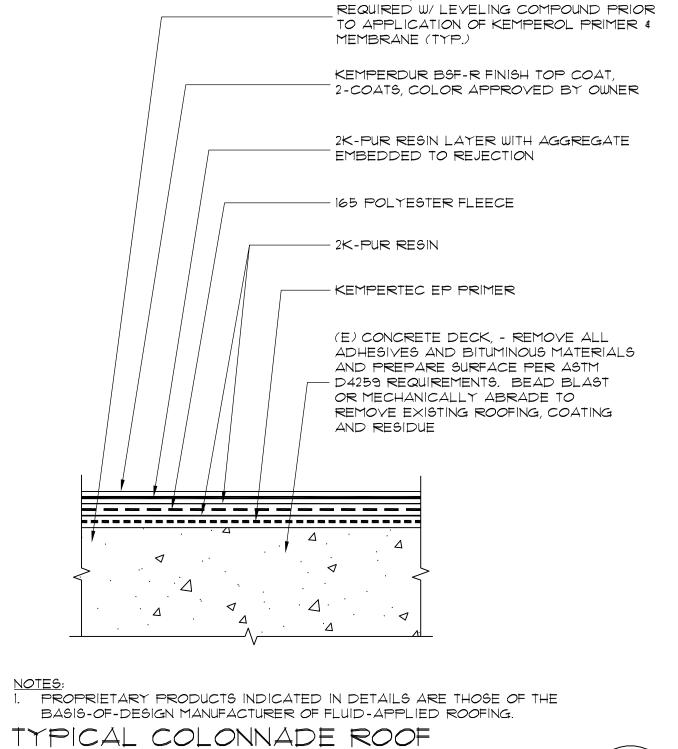

PREPARE, LEVEL & PATCH SUBSTRATE AS

A301

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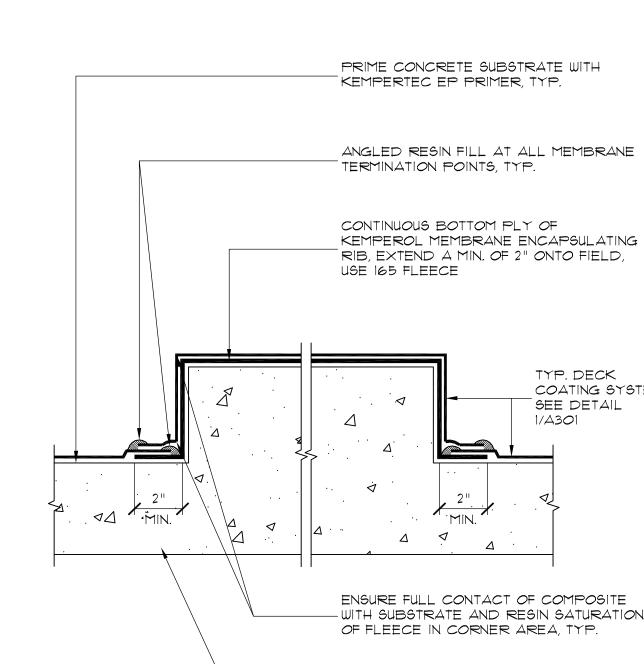
San Mateo County


Mateo Colonnades

San Mateo, CA 94402


Deck

Project



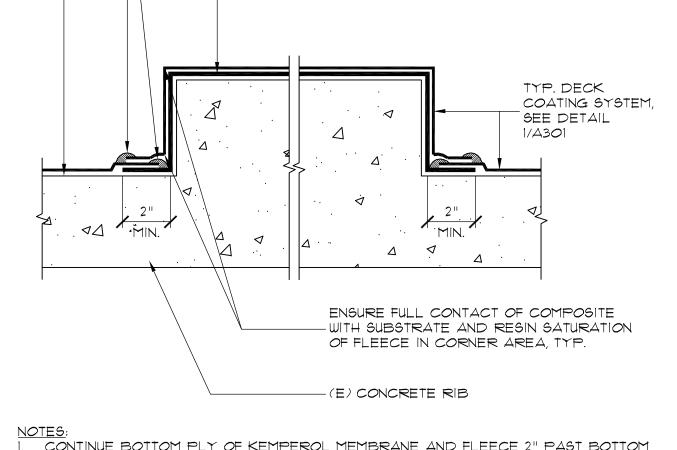

CONTINUE BOTTOM PLY OF KEMPEROL MEMBRANE AND FLEECE 2" PAST BOTTOM END OF 90 DEGREE CONCRETE RIB. 90 DEGREE CONCRETE RIB 4 A301 A301 SCALE: N.T.S.

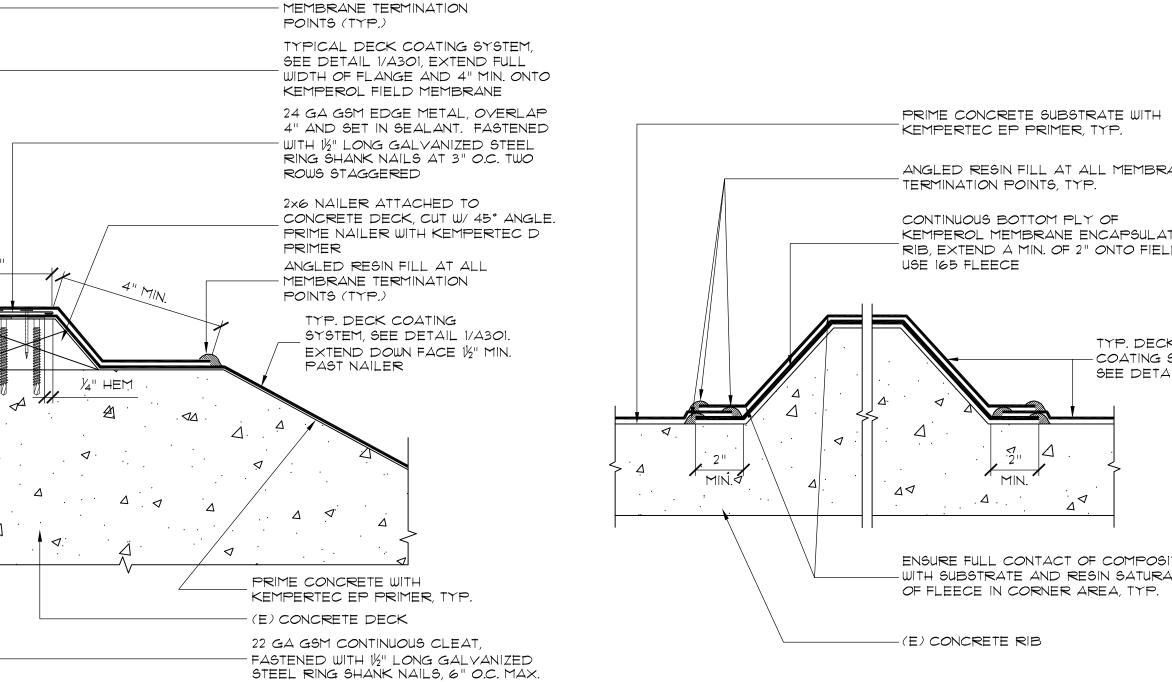

A301

INSIDE CORNER HANDOUT FROM POLYESTER 165 FLEECE-DEFORM TO -PROVIDE 1" MINIMUM UP TURN. SET

OVER REINFORCEMENT PLY BUT

(E) CONCRETE

ANGLED RESIN FILL AT ALL


PRIOR TO FIELD MEMBRANE

SCALE: N.T.S.

1. 2x6 NAILER FASTENED WITH CONCRETE ANCHORS AT 24" O.C. TWO ROWS CONTRACTOR TO PAINT FACE OF EDGE METAL AND EXPOSED FACE OF COLONNADE CONTINUE BOTTOM PLY OF KEMPEROL MEMBRANE AND FLEECE 2" PAST BOTTOM WITH PAINT APPROVED BY OWNER. END OF SLOPED CONCRETE RIB. 3. SEE DETAILS 10/A301. 12/A301 AND 13/A301 FOR ADDITIONAL EDGE METAL SLOPED CONCRETE RIB TYPICAL EDGE DETAIL 6

SCALE: N.T.S.

A301

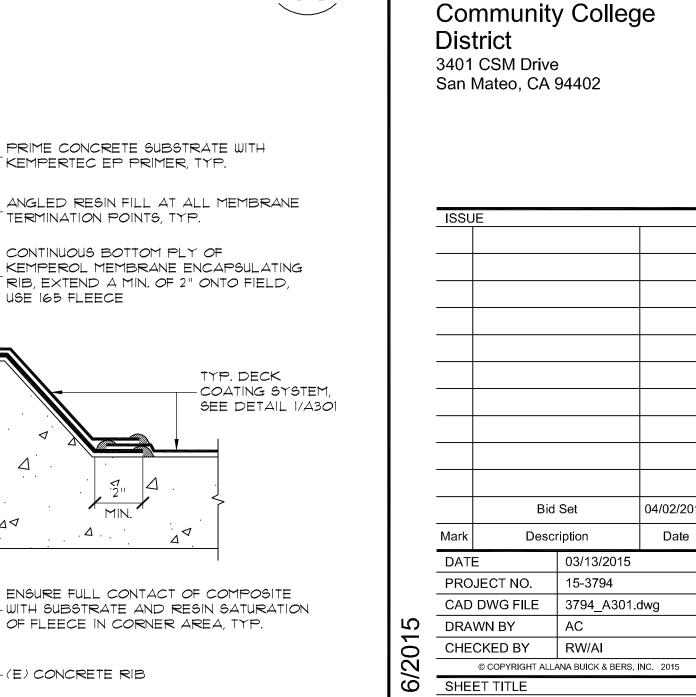


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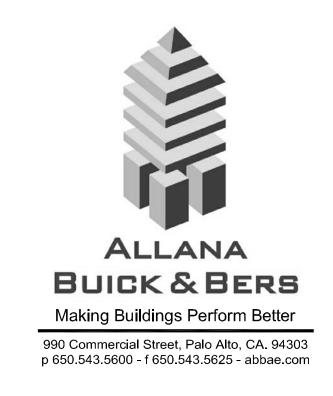
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COLONNADE DETAILS




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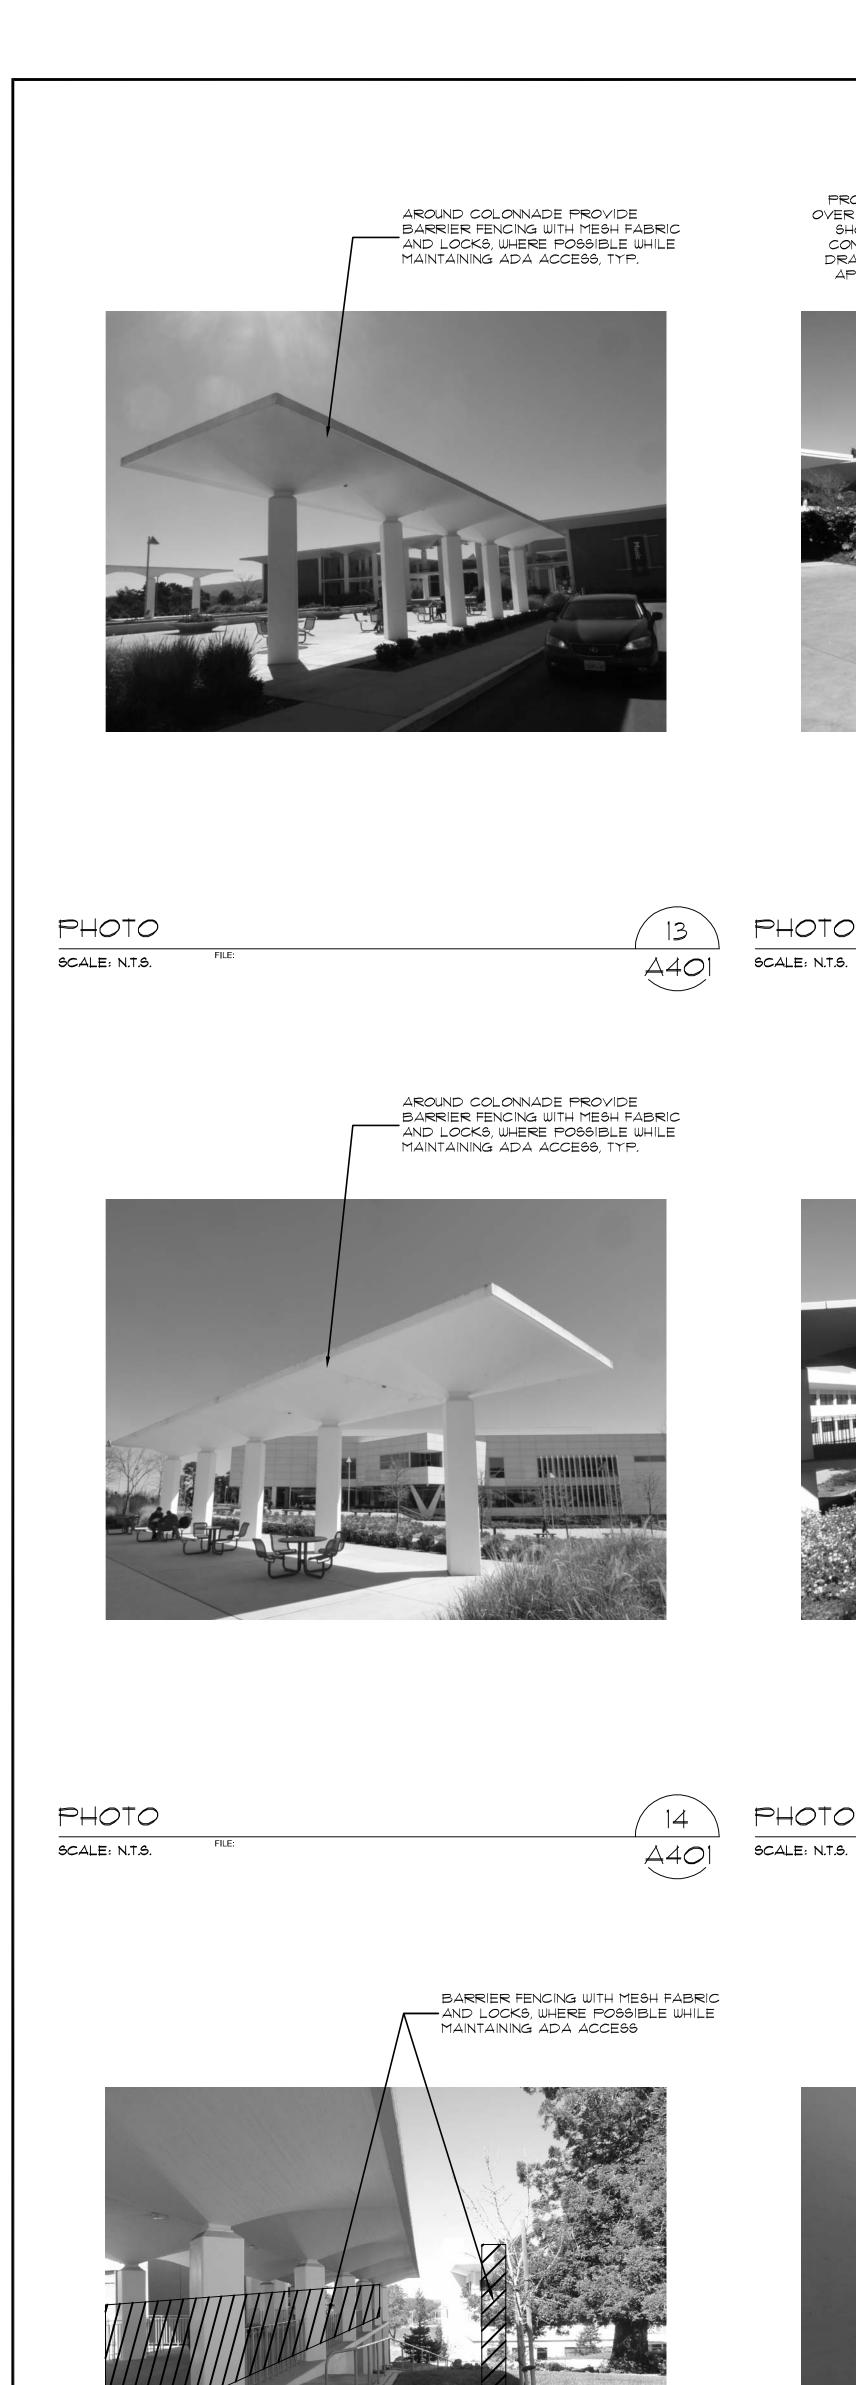
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PROVIDE PROTECTIVE CANOPIES

SHOWN ON SITE LOGISTICS PLAN.

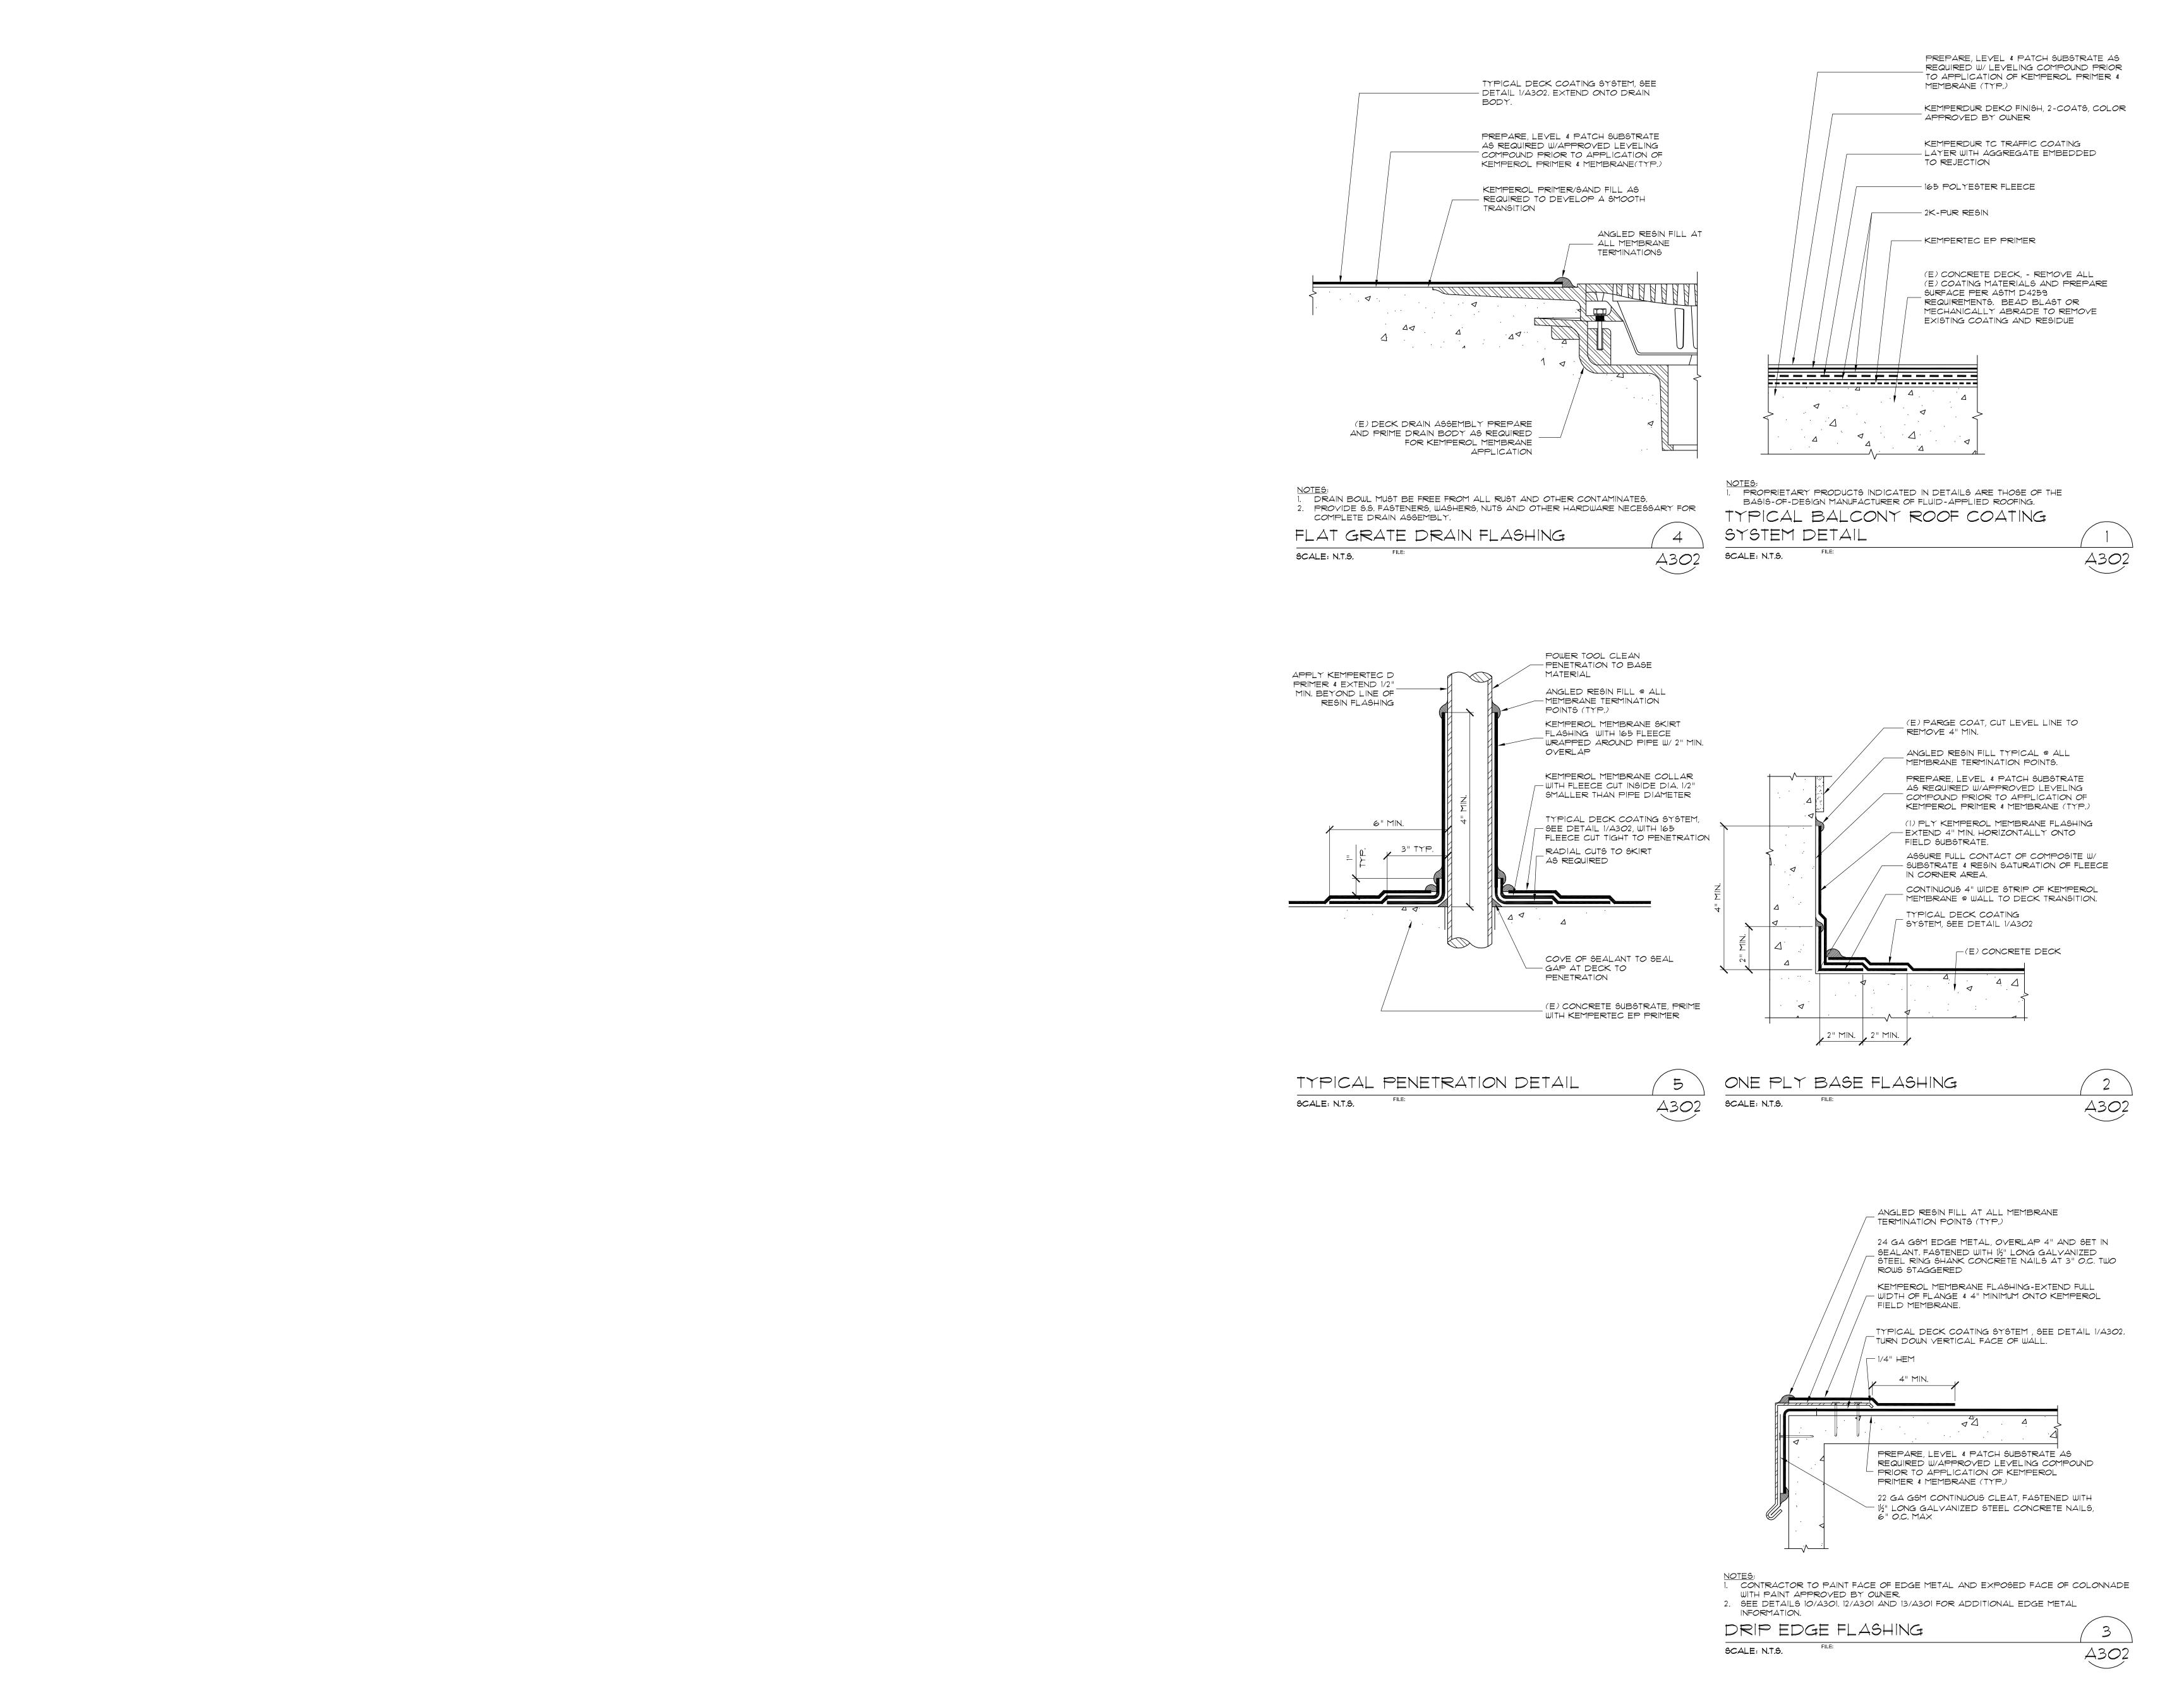CONTRACTOR TO PROVIDE SHOP DRAWINGS OF EACH CANOPY FOR


APPROVAL PRIOR TO ERECTION


OVER BUILDING ENTRANCES, WHERE

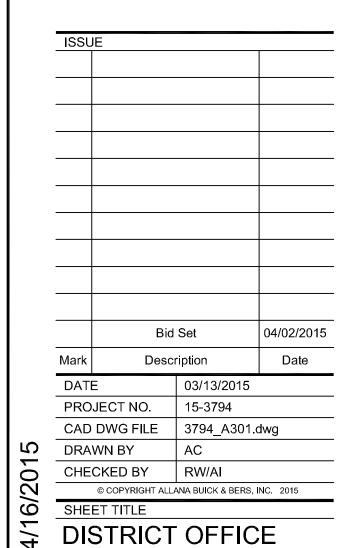PROVIDE PROTECTIVE CANOPIES

SHOWN ON SITE LOGISTICS PLAN.

OVER BUILDING ENTRANCES, WHERE

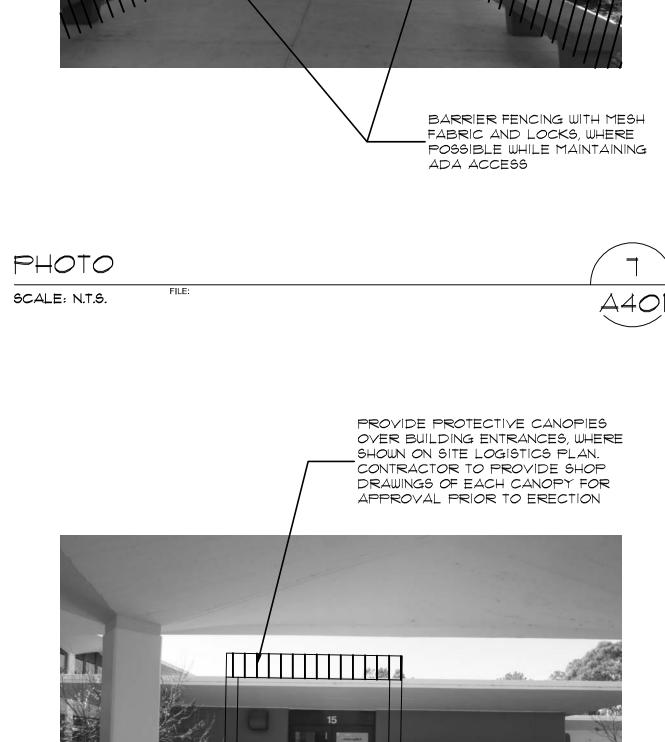

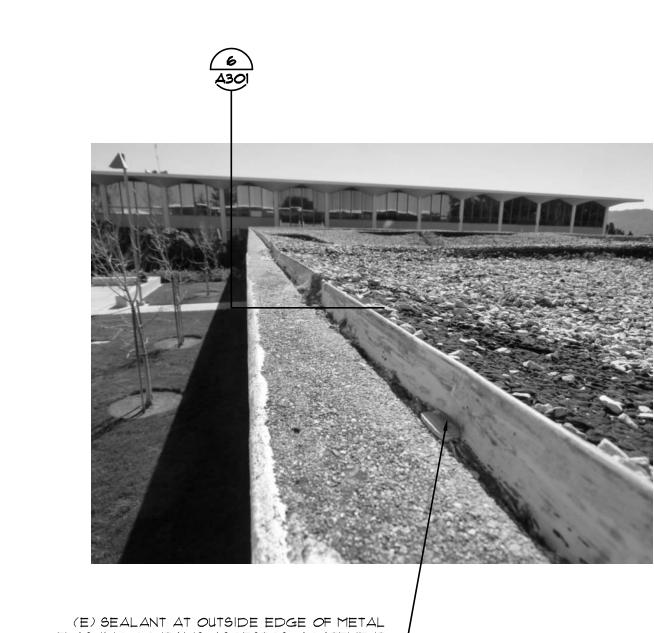

PHOTO

SCALE: N.T.S.

PHOTO

SCALE: N.T.S.


ELECTRICAL CONDUIT

PENETRATION, RAISE
TO 8" MINIMUM HEIGHT

A301


DEMOLISH (E) STRAINER DOME, CLAMPING

-RING AND BOLTS, SALVAGE COMPLETE ASSEMBLIES AND DELIVER TO OWNER

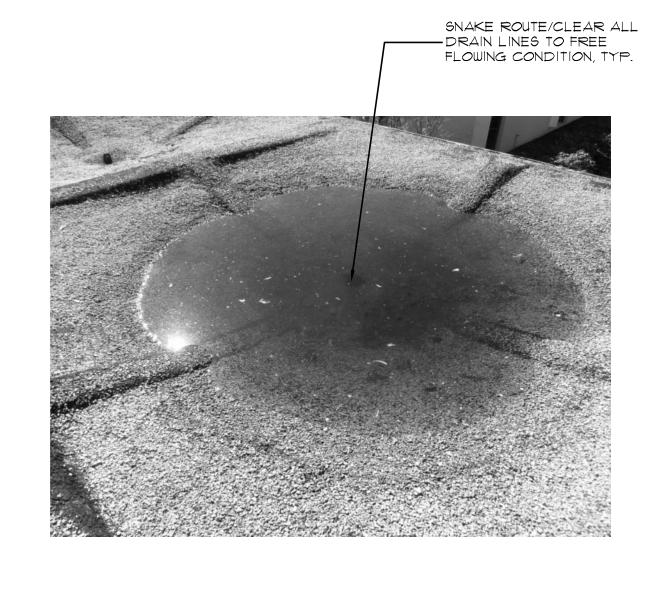





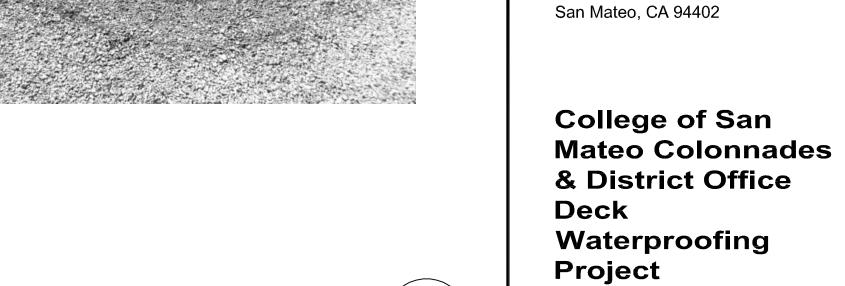

A401

_DEMOLISH EXISTING ROOF

SYSTEMS TO BASE CONCRETE

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Description

03/13/2015 15-3794


A401




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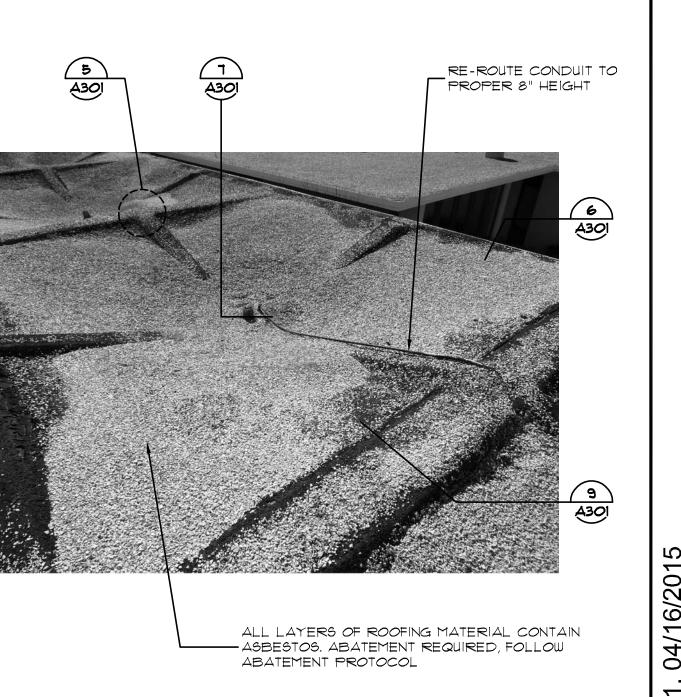



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6

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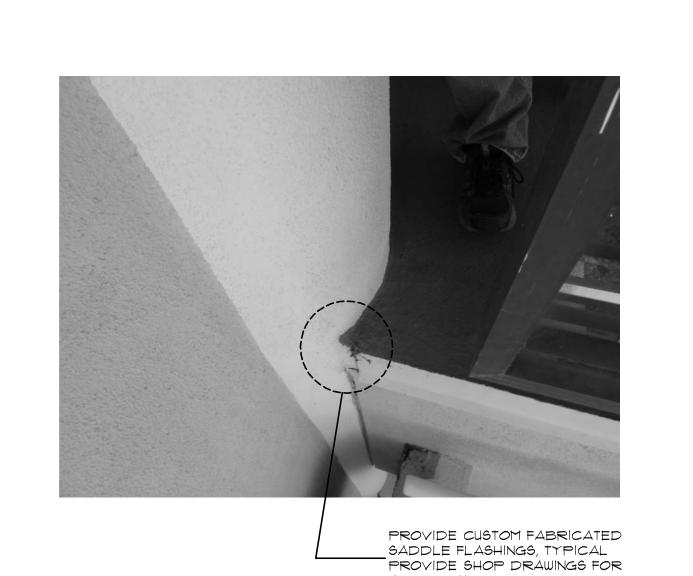

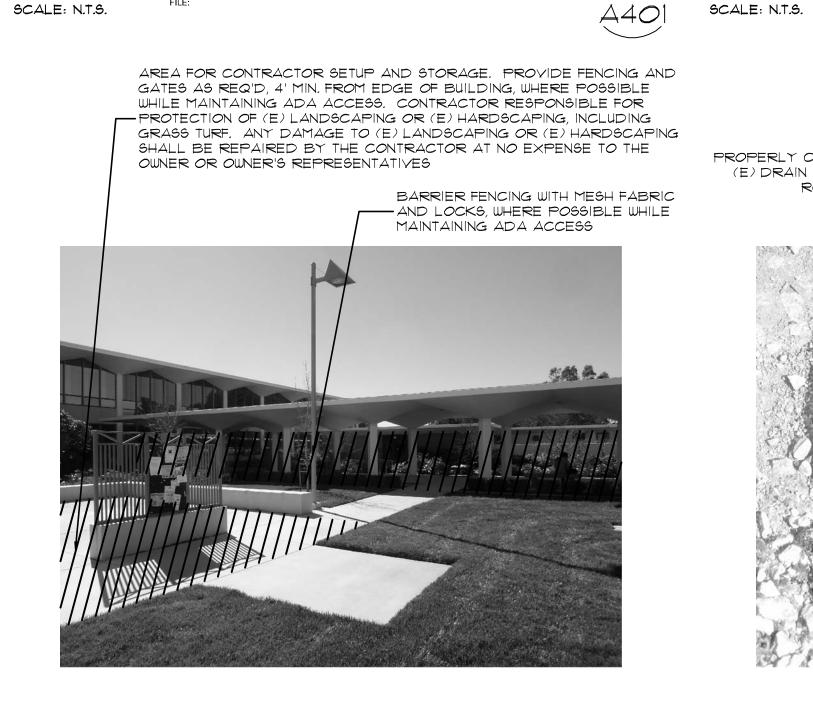
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PHOTO

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PHOTOS SCALE: NOTED ON DRAWINGS

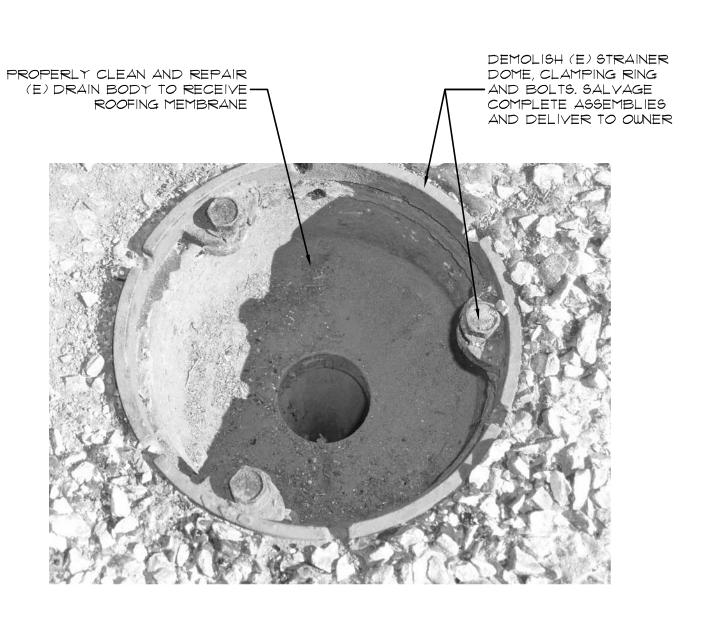

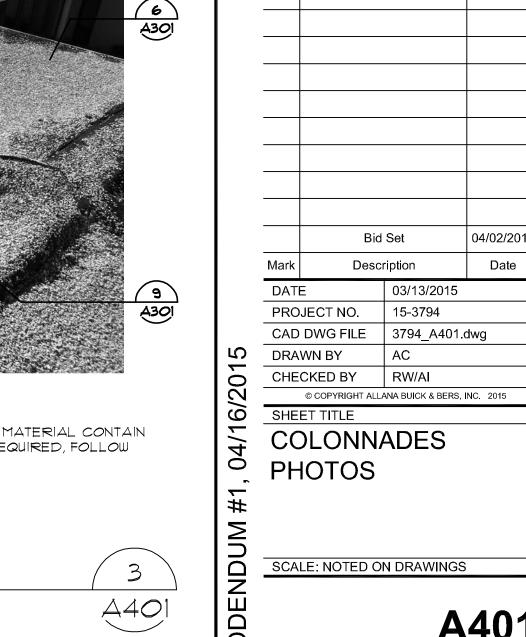


REPLACE 2 DAMAGED CLIPS — WHERE OCCUR. PROVIDE STAINLESS STEEL BRACKETS








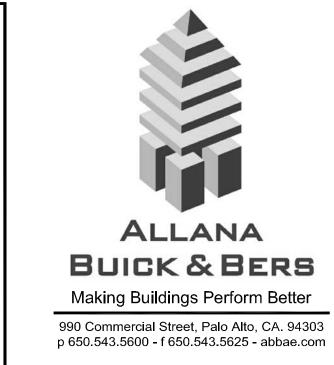

CONTRACT TO MOVE ITEMS
TO ACCOMPLISH WORK.
STAGE APPROXIMATELY
HALF BALCONY PER INSTALL

3
A303



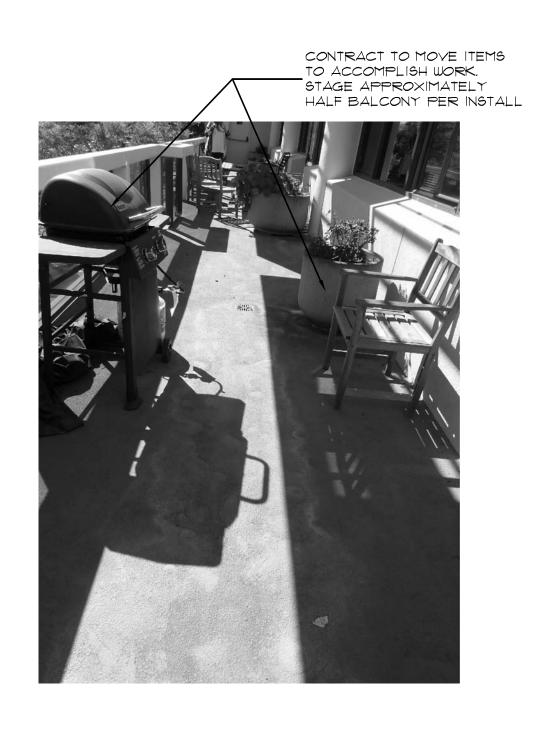






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PHOTO

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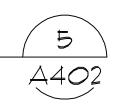
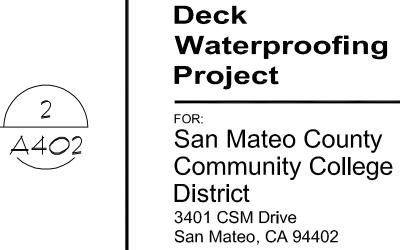


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College of San Mateo

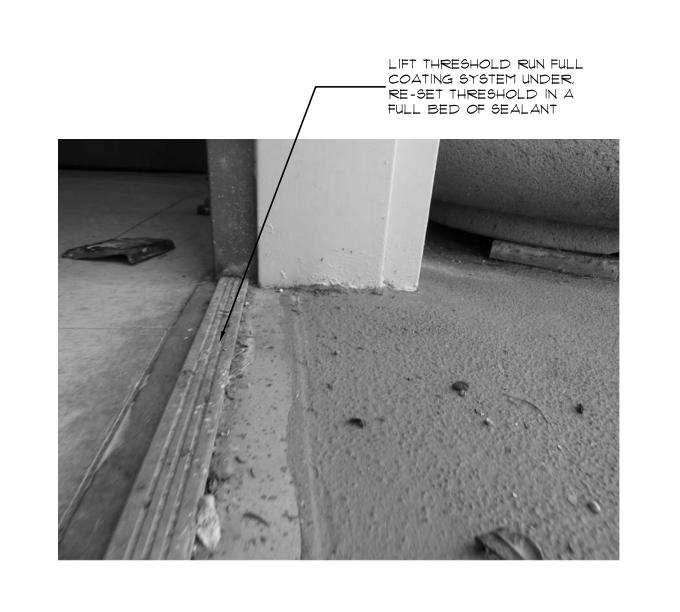1700 West Hillsdale Boulevard San Mateo, CA 94402


College of San


& District Office


Mateo Colonnades

A402



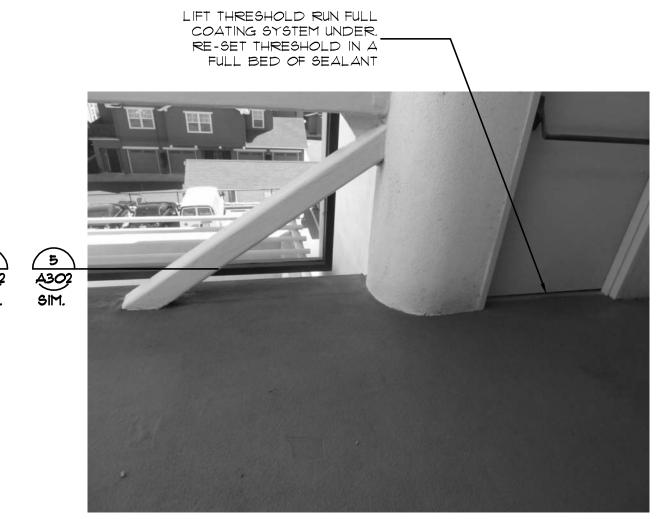

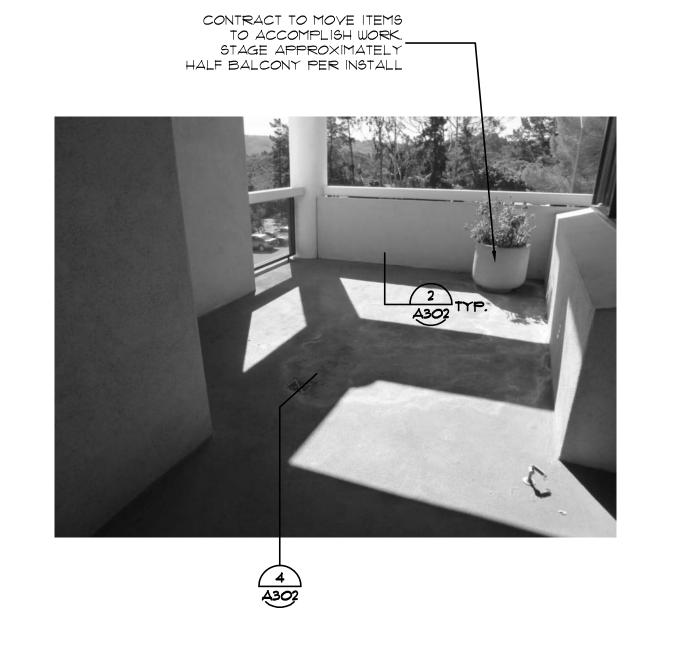

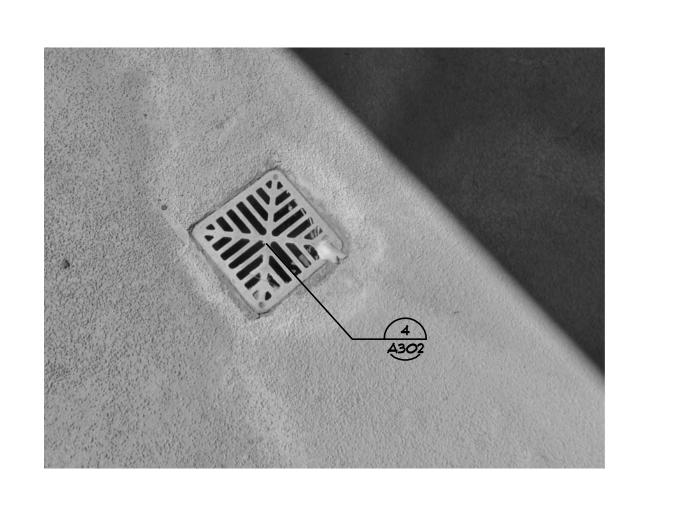



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15 A402

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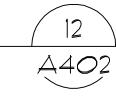
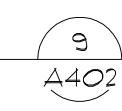


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SCALE: N.T.S.



PHOTO SCALE: N.T.S.



Bid Set 04/02/201

Mark Description Date

DATE 03/13/2015

PROJECT NO. 15-3794

CAD DWG FILE 3794_A401.dwg

DRAWN BY AC

CHECKED BY RW/AI

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DISTRICT OFFICE

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PHOTOS

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