
SHEET NOTES


- 1. REMOVE EXISTING PLENUMS CONNECTING TO EXISTING LOUVER AND RELATED DUCT AS SHOWN TO ALLOW FOR THE REMOVAL OF THE EXISTING LOUVER AND THE INSTALLATION OF A NEW ELECTRICAL LOAD CENTER. NEW PLENUMS AND RELATED DUCT ARE TO BE INSTALLED TO MATCH THE EXISTING INSTALLATION.
- 2. REMOVE EXISTING 16" DUCT.
- 3. EXISTING SUPPLY FAN TO REMAIN.
- 4. EXISTING FAN COIL UNIT TO REMAIN.
- 5. TWO (2) 24"x24"x8" DEEP PLENUMS, ONE (1) ABOVE AND ONE (1) BELOW, ARE TO CONNECT TO THE LOUVER AS HIGH AS POSSIBLE. THE UPPER 24"x24"x8" PLENUM IS TO HAVE A SMOOTH SQUARE TO ROUND TRANSITION FROM 24"x24" TO 12"ø AND CONNECT TO THE EXISTING 12"ø DUCT. THE LOWER 24"x24"x8" PLENUM IS TO HAVE A SMOOTH SQUARE TO ROUND TRANSITION FROM 24"x24" TO 14"ø AND IS TO CONNECT TO THE EXISTING 14"ø DUCT.
- 6. 36"x36"x8" DEEP PLENUM IS TO CONNECT TO THE LOUVER AS HIGH AS POSSIBLE. PROVIDE A SMOOTH SQUARE TO ROUND TRANSITION FROM 36"x36" TO 16"ø AND CONNECT TO THE EXISTING 16"ø DUCT.
- 7. 24"x24"x8" DEEP PLENUM IS TO CONNECT TO THE LOUVER AS HIGH AS POSSIBLE. PROVIDE A SMOOTH SQUARE TO ROUND TRANSITION FROM 24"x24" TO 12"ø AND CONNECT TO THE EXISTING 12"ø DUCT.
- 8. 30"x24"x8" DEEP PLENUM IS TO CONNECT TO THE LOUVER AS HIGH AS POSSIBLE. PROVIDE A SMOOTH SQUARE TO ROUND TRANSITION FROM 30"x24" TO 18" AND CONNECT TO THE EXISTING 18"ø DUCT.
- INSTALL NEW 16"ø DUCT TO AVOID ROUTING ANY DUCT OVER ELECTRICAL LOAD CENTER.

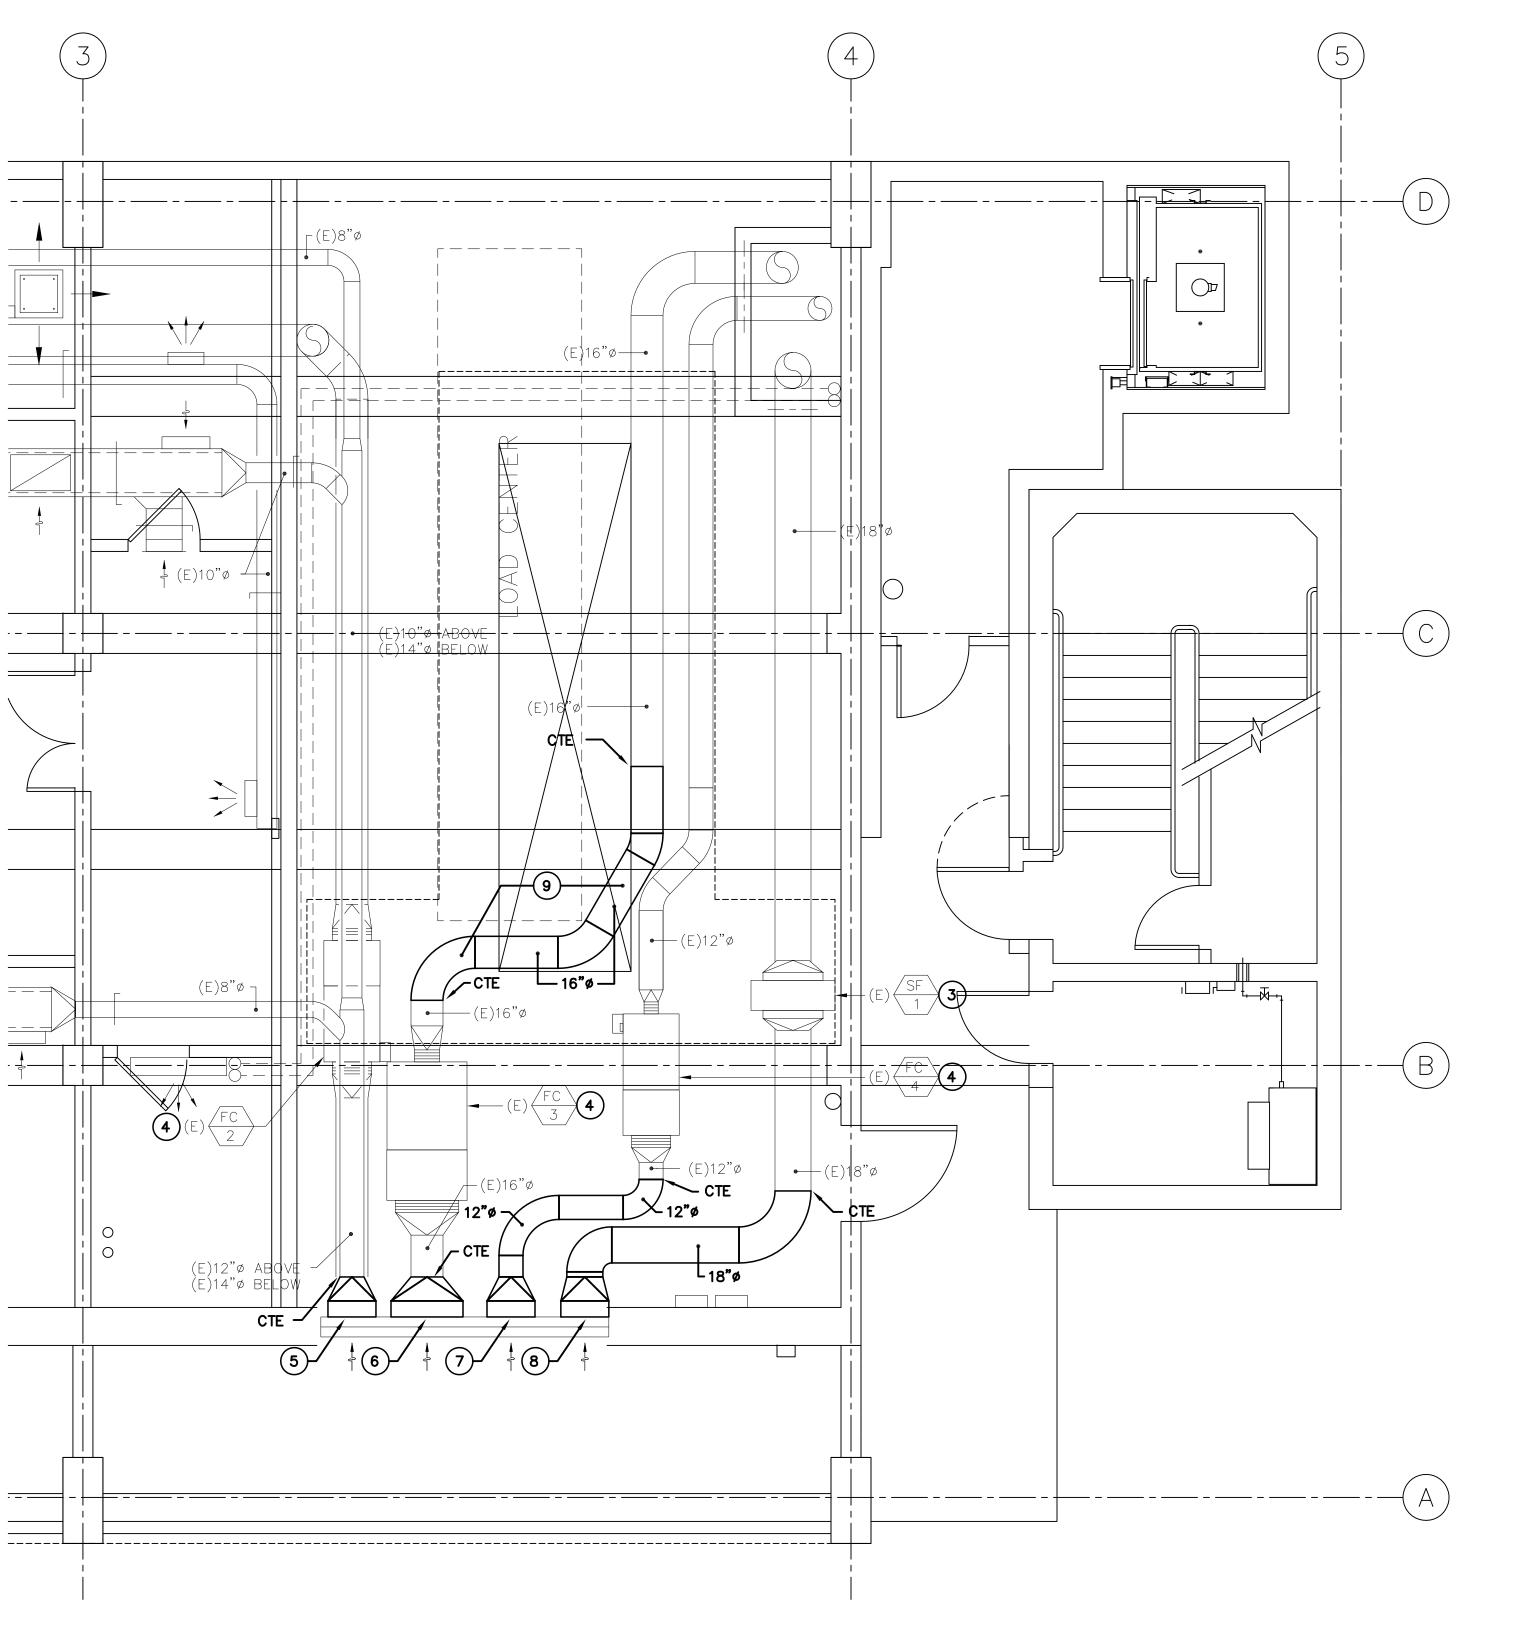

MECHANICAL PARTIAL FLOOR PLAN — BLDG 16 LOAD CENTER #2


SCALE: 1/4" = 1'-0"



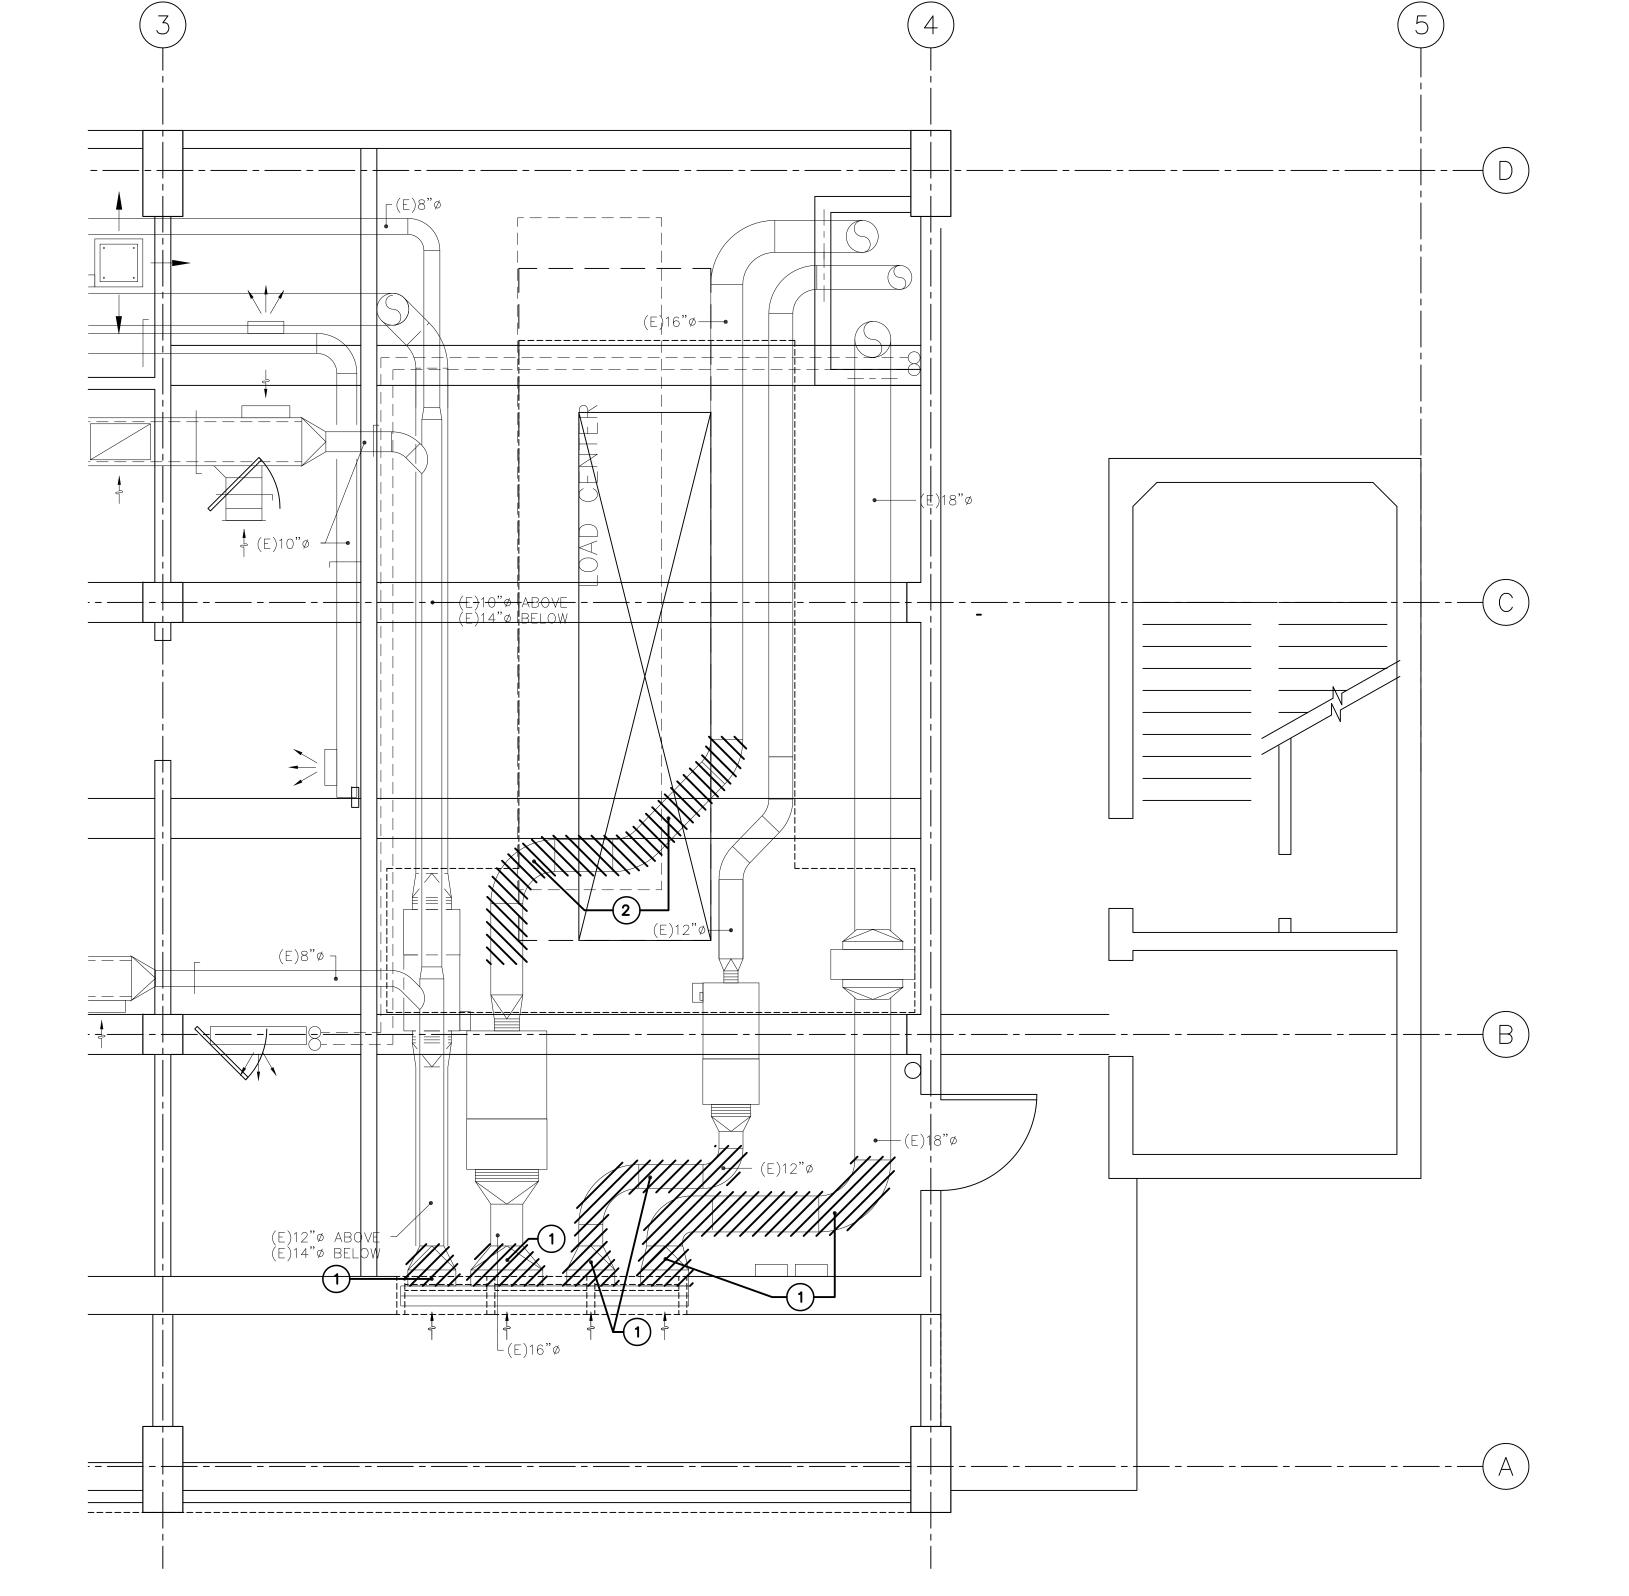

MECHANICAL PARTIAL DEMOLITION PLAN — BLDG 16 LOAD CENTER #2

SCALE: 1/4" = 1'-0"

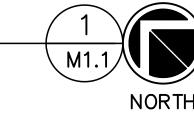

729 Heinz Avenue
Berkeley, CA 94710
510.649.8295
fax 510.649.3008

IDENTIFICATION STAMP
DIVISION OF THE STATE ARCHITECT

APPLICATION NUMBER 01-1 1 1 6 1 8

CALIFORNIA STATE FIRE MARSHAL APPROVED

APPROVAL OF THIS PLAN DOES NOT AUTHORIZE OR APPROVE ANY OMISSION OR DEVIATION FROM APPLICABLE REGULATIONS. FINAL APPROVAL IS SUBJECT TO FIELD INSPECTION. ONE SET OF APPROVED PLANS SHALL BE AVAILABLE ON THE PROJECT SITE AT ALL TIMES.

REVIEWED BY: ______ DATE:

CAÑADA COLLEGE

Electrical
Infrastructure
Replacement
Project

4200 Farm Hill Blvd Redwood City, CA 94061

RECORD SET

SHEET TITLE

MECHANICAL PARTIAL FLOOR PLANS - BLDG 16

REVISIONS

NO. DATE DESCRIPTION

DATE June 15, 2012

DRAWN VT/AL

CHECKED MW

SCALE AS NOTED

JOB NO. 2921.01

SHEET NUMBER

M1.1